

(PPSSSH-62) - (1-21 Dillwynnia Grove Heathcote)

(MA21/0051)

ASSESSMENT REPORT APPENDICES

Appendix	A	Conditions of Consent to be Modified
	B	Public Submissions
	C	Heritage Council of NSW – General Terms of Approval
	D	Rural Fire Service Response (07 June 2021)
	E	Architectural Plans

Appendix A

Conditions of Consent to be Modified

(Delete where in ~~Strike through~~ / Add where **Bold**)

1. Approved Plans and Documents

The development must be undertaken substantially in accordance with the details and specifications set out on the following plans except where they are the subject of the deferred commencement condition/s:

Plan number/ Reference	Title	Prepared by	Date
Project Number IA1633 DA00 Cover Sheet Issue 1 Project No P20-056 MOD00 Revision A	Cover Sheet	Ink Architects DesignInc	27 August 2019 15/01/2021
Project Number IA1633 DA01 Site Plan Roof Plan Issue 1 Project No P20-056 MOD01 Revision A	Site Plan Roof Plan	Ink Architects DesignInc	27 August 2019 - received by Council 29 October 2019 15/01/2021
Project Number IA1633 DA02 Issue A	Demolition Plan	Ink Architects	5/12/2017
Project Number IA1633 DA05 Issue 1 Project No P20-056 MOD05 Revision A	Lower Basement Floor Plan - B2 Lower Basement B2	Ink Architects DesignInc	Amended by Council 25 September 2019 15/01/2021
Project Number IA1633 DA06 Issue 1 Project No P20-056 MOD06 Revision A	Basement Floor Plan - B1	Ink Architects DesignInc	Amended by Council 25 September 2019 15/01/2021

	Lower Basement B1		
Project Number IA1633 DA07 Issue 1 Project No P20-056 MOD07 Revision A	Ground Floor Plan	Ink Architects DesignInc	Amended by Council 25 September 2019 15/01/2021
Project Number IA1633 DA07 CMP Issue 1	Ground Floor Plan CMP	Ink Architects	27 August 2019
Project Number IA1633 DA08 Issue 1 Project No P20-056 MOD08 Revision A	First Floor Plan	Ink Architects DesignInc	27 August 2019 15/01/2021
Project Number IA1633 DA08 CMP Issue 1	First Floor Plan CMP	Ink Architects	27 August 2019
Project Number IA1633 DA09 Issue 1 Project No P20-056 MOD09 Revision A	Second Floor Plan	Ink Architects DesignInc	27 August 2019 15/01/2021
Project Number IA1633 DA09 CMP Issue 1	Second Floor CMP	Ink Architects	27 August 2019
Project Number IA1633 DA10 Issue 1 Project No P20-056 MOD10 Revision A	East, North, West and & South Elevations	Ink Architects DesignInc	Amended by Council 30 October 2019 15/01/2021
Project Number IA1633 DA11 Issue 1 Project No P20-056 MOD11 Revision A	Sections A-A, B-B, C-C and & D-D	Ink Architects DesignInc	27 August 2019 – received by Council 29 October 2019 15/01/2021
Project Number IA1633 DA12 Issue 1 Project No P20-056 MOD12 Revision A	Sections E-E, F-F, G-G, & , I-I	Ink Architects DesignInc	27 August 2019 15/01/2021

Project Number IA1633 DA13 Issue I Project No P20-056 MOD13 Revision A	Sections H-H, J-J, K-K	Ink Architects DesignInc	27 August 2019 <i>–received by</i> <i>Council 29</i> <i>October 2019</i> 15/01/2021
Project Number IA1633 DA16 Issue 1	Adaptable and Livable Dwellings	Ink Architects	27 August 2019
Project No P20-056 MOD15 Revision A	FSR Calculations	DesignInc	15/01/2021
Project No P20-056 MOD16 Revision A	Adaptable Townhouse 7, 8, 11 & 12	DesignInc	15/01/2021
Project No P20-056 MOD17 Revision A	Adaptable Townhouse 13, 14, 22 & Apartment B101, B103, B201, B203	DesignInc	15/01/2021
Project Number IA1633 DA20 Issue I Project No P20-056 MOD20 Revision A	Material Finishes Board	Ink Architects DesignInc	27 August 2019 15/01/2021
Project Number IA1633 DA21 Issue D	Material Finishes	Ink Architects	20 March 2019
Project Number IA1633 DA29 Issue I	Wayfinding	Ink Architects	28 August 2019
Project No P20-056 A2050	External Details - Substation	DesignInc	15/01/2021
Project No P20-056 A2051 Revision A	External Details –	DesignInc	15/01/2021

	Hydrant Booster		
Project Number 1609	Schedule of Drawings	Tropman and Tropman Architects	23/11/2017
Project 1609	Location	Tropman and Tropman Architects	23/11/2017
EX100 Revision F Project1609	Existing Site Plan	Tropman and Tropman Architects	23/11/17
EX101 Revision F Project1609	Ground Floor	Tropman and Tropman Architects	23/11/17
EX102 Revision F Project1609	Existing First Floor	Tropman and Tropman Architects	23/11/17
EX110 Revision F Project1609	Existing Elevations S-W	Tropman and Tropman Architects	23/11/17
EX111 Revision F Project1609	Existing Elevation S-E	Tropman and Tropman Architects	23/11/17
EX112 Revision F Project1609	Existing Elevation N-W	Tropman and Tropman Architects	23/11/17
EX113 Revision F Project1609	Existing Elevation N-E	Tropman and Tropman Architects	23/11/17
PR.200 Revision F Project1609	Existing Roof Plan	Tropman and Tropman Architects	23/11/17

PR 201 Revision F Project1609	Proposed Ground Floor Plan	Tropman and Tropman Architects	23/11/17
PR 202 Revision F Project1609	Proposed First Floor Plan	Tropman and Tropman Architects	23/11/17
PR 210 Revision F Project1609	Proposed Elevation S-W	Tropman and Tropman Architects	23/11/17
PR 211 Revision F Project1609	Proposed Elevation N-W	Tropman and Tropman Architects	23/11/17
PR 212 Revision F Project1609	Proposed Elevation N-E	Tropman and Tropman Architects	23/11/17
PR 213 Revision F Project1609	Proposed Elevation S-E	Tropman and Tropman Architects	23/11/17
DA-C01.01 Revision 5	Cover Sheet, Drawing Schedule and Locality Plan	Northrop	16/2/18
DA-C02.01 Revision 5	Concept Sediment and Erosion Control Plan	Northrop	16/2/18
DA-C02.11 Revision 5	Sediment and Erosion Control Details	Northrop	16/2/18
DA-C04.01 Revision 7	Stormwater Management Plan	Northrop	20/5/19
DA-C04.61 Revision 5	Stormwater Management Devices-OSD 1- Sheet 1	Northrop	16/2/18

DA-C04.62 Revision 6	Stormwater Management Devices OSD1-- Sheet 2	Northrop	20/5/19
DA-C04.71 Revision 6	Stormwater Management Devices OSD 2-- Sheet 1	Northrop	20/5/19
DA-C04.91 Revision 1	Pre-Development Stormwater Catchment Plan	Northrop	16/2/18
DA-C04.92 Revision 5	Post-Development Stormwater Catchment Plan	Northrop	16/2/18
DA-C05.61 Revision 5	Site works General Arrangement Plan	Northrop	16/2/18
DA-C05.71 Revision 5	Siteworks Driveway Plan Sheet 1	Northrop	16/2/18
DA-C05.72 Revision 4	Siteworks Driveway Plan Sheet 2	Northrop	16/2/18
C-01-01 Revision 4	Drawing Schedule, Legend and Locality Plan	SCP Consulting	16/12/20
C-01-02 Revision 4	Specification Notes	SCP Consulting	16/12/20
C-03-01 Revision 4	Siteworks and Grading Plan	SCP Consulting	16/12/20
C-03-11 Revision 4	Pavement Plan	SCP Consulting	16/12/20
C-03-51 Revision 3	Siteworks Details	SCP Consulting	16/12/20
C-04-11 Revision 3	Typical Sections	SCP Consulting	16/12/20

C-04-21 Revision 3	Driveway Long Sections – Sheet 01 of 03	SCP Consulting	16/12/20
C-04-22 Revision 3	Driveway Long Sections – Sheet 02 of 03	SCP Consulting	16/12/20
C-04-23 Revision 3	Driveway Long Sections – Sheet 03 of 03	SCP Consulting	16/12/20
C-05-01 Revision 4	Stormwater Drainage Layout Plan	SCP Consulting	16/12/20
C-05-21 Revision 3	Stormwater Catchment Plan	SCP Consulting	16/12/20
C-05-61 Revision 4	Stormwater Details	SCP Consulting	16/12/20
C-06-01 Revision 4	Sediment and Erosion Control Plan	SCP Consulting	16/12/20
C-06-11 Revision 4	Sediment and Erosion Control Details	SCP Consulting	16/12/20
L-02 Issue D	Heritage Survey / Site Analysis	Site Design + Studios	11/12/2017
L-03 Issue D	Heritage Survey Site / Analysis	Site Design + Studios	11/12/2017
L-04 Issue D	Heritage Survey / Site Analysis	Site Design + Studios	11/12/2017
L-05 Issue D	Heritage Survey / Site Analysis	Site Design + Studios	11/12/2017
L-06 Issue C	Heritage Concept Plans - Italianate	Site Design + Studios in	Received by Council on 20 March 2018

		coordination with Michael Lehany	
L-07 Issue D	Heritage Garden/ CMP Reference	Site Design + Studios	Received by Council on 20 March 2018
L-7A Issue D	Heritage – CMP	Site Design + Studios	Received by Council on 20 March 2018
L-09 Issue E	Site Analysis	Site Design + Studios	19/3/18
L-10 Issue E	Interpretation	Site Design + Studios	19/3/18
L-11 Issue E	Landscape Masterplan	Site Design + Studios	19/3/18
L-12 Issue D	Landscape Plans Levels	Site Design + Studios	11/12/2017
L-12A Issue E	Landscape Plans – Hydraulics	Site Design + Studios	19/3/18
L-13 Issue E	Landscape Plan – Details	Site Design + Studios	19/3/18
L-14 Issue E	Existing Trees Plan	Site Design + Studios	19/3/18
L-14A Issue E	Existing Trees Plan	Site Design + Studios	Received by Council on 20 March 2018
L-15 Issue E	Existing Tree Report – Draft	Site Design + Studios	Received by Council on 20 March 2018
L-16 Issue E	Incursions	Site Design + Studios	19/3/18
L-17 Issue E	Planting Area Plan	Site Design + Studios	Received by Council on 20 March 2018

L-18 Issue E	Plant List	Site Design + Studios	Received by Council on 20 March 2018
L-19 Issue E	Landscape Plans - Materials	Site Design + Studios	Received by Council on 20 March 2018
L-20 Issue E	Details	Site Design + Studios	Received by Council on 20 March 2018
L-21 Issue E	Sections	Site Design + Studios	Received by Council on 20 March 2018
L-22 Issue F	Heritage Paths	Site Design + Studios	18/9/18
LA-01 Revision A	Landscape Package Cover Sheet	DesignInc	15/01/2021
LA-02 Revision A	Site Calculations	DesignInc	15/01/2021
LA-03 Revision A	Landscape Master Plan	DesignInc	15/01/2021
LA-04 Revision A	Landscape Master Plan	DesignInc	15/01/2021
LA-05 Revision A	Proposed Levels	DesignInc	15/01/2021
LA-06 Revision A	Detail Design Concepts	DesignInc	15/01/2021
LA-07 Revision A	Proposed Materials	DesignInc	15/01/2021
LA-08 Revision A	Trees to be Removed and Retained	DesignInc	15/01/2021
LA-09 Revision A	Trees to be Retained with TPZ and SRZ	DesignInc	15/01/2021

LA-10 Revision A	Planting Areas	DesignInc	15/01/2021
LA-11 Revision A	Plant Schedule	DesignInc	15/01/2021
LA-12 Revision A	Landscape Sections	DesignInc	15/01/2021
LA-13 Revision A	Landscape Sections	DesignInc	15/01/2021
LA-14 Revision A	Landscape Sections	DesignInc	15/01/2021
Fencing Revision A	Fencing	DesignInc	15/01/2021
LA-15 Revision A	Fencing Details Sheet One	DesignInc	15/01/2021
LA-17 Revision A	Fencing Details Sheet Two	DesignInc	15/01/2021
LA-18 Revision A	Fencing Details Sheet Three	DesignInc	15/01/2021
LA-19 Revision A	Fencing Details Sheet Four	DesignInc	15/01/2021
LA-20 Revision A	Fencing Details Sheet Five	DesignInc	15/01/2021
LA-21 Revision A	Fencing Details Sheet Six	DesignInc	15/01/2021
Project Number IA1633-DA17 Issue A	Project Perspectives	INK Architects	7/12/2017
Reference: 170224 DSP Issue 4 Issue 10 Sheet 1 of 14	Location Plan	Tasy Moraitis Adam Richardson	Printed 18 May 2018 Printed 23 Nov 2020
Reference: 170224 DSP Issue 4 Issue 10 Sheet 2 of 14	Lower Basement Plan Basement Level 2	Tasy Moraitis Adam Richardson	Printed 18 May 2018 Printed 23 Nov 2020

Reference: 170224 DSP Issue 4 Issue 10 Sheet 3 of 14	Basement Level 1	Tasy Moraitis Adam Richardson	Printed 18 May 2018 Printed 23 Nov 2020
Reference: 170224 DSP Issue 4 Issue 10 Sheet 4 of 14	Basement Level 1	Tasy Moraitis Adam Richardson	Printed 18 May 2018 Printed 23 Nov 2020
Reference 170224 DSP Issue 4 Issue 10 Sheet 5 of 14	Basement Level 1	Tasy Moraitis Adam Richardson	Printed 18 May 2018 Printed 23 Nov 2020
Reference 170224 DSP Issue 4 Issue 10 Sheet 6 of 14	Ground Level	Tasy Moraitis Adam Richardson	Printed 18 May 2018 Printed 23 Nov 2020
Reference 170224 DSP Issue 4 Issue 10 Sheet 7 of 14	Ground Level	Tasy Moraitis Adam Richardson	Printed 18 May 2018 Printed 23 Nov 2020
Reference 170224 DSP Issue 4 Issue 10 Sheet 8 of 14	Ground Level	Tasy Moraitis Adam Richardson	Printed 18 May 2018 Printed 23 Nov 2020
Reference 170224 DSP Issue 4 Issue 10 Sheet 9 of 14	Level 1	Tasy Moraitis Adam Richardson	Printed 18 May 2018 Printed 23 Nov 2020
Reference 170224 DSP Issue 4 Issue 10 Sheet 10 of 14	Level 1	Tasy Moraitis Adam Richardson	Printed 18 May 2018 Printed 23 Nov 2020

Reference 170224 DSP Issue 4 Issue 10 Sheet 11 of 14	Level 1	Tasy Moraitis Adam Richardson	Printed 18 May 2018 Printed 23 Nov 2020
Reference 170224 DSP Issue 4 Issue 10 Sheet 12 of 14	Second Level Level 2	Tasy Moraitis Adam Richardson	Printed 18 May 2018 Printed 23 Nov 2020
Reference 170224 DSP Issue 4 Issue 10 Sheet 13 of 14	Ground Level - Hall	Tasy Moraitis Adam Richardson	Printed 18 May 2018 Printed 23 Nov 2020
Reference 170224 DSP Issue 4 Issue 10 Sheet 14 of 14,	Level 1 - Hall, Level 2 - Hall	Tasy Moraitis Adam Richardson	Printed 18 May 2018 Printed 23 Nov 2020
SP Form 3.01 Issue 4 Issue 10 Sheet 1 of 3	Strata Plan Administration Sheet	Tasy Moraitis Adam Richardson	Printed 18 May 2018 Printed 23 Nov 2020
SP Form 3.07 Issue 4 Issue 10 Sheet 2	Strata Plan Administration Sheet	Unknown Adam Richardson	Printed 18 May 2018 Printed 23 Nov 2020
SP Form 3.08 (Annexure) Issue 4 Issue 10 Sheet 3	Strata Plan Administration Sheet	Unknown Adam Richardson	Printed 18 May 2018 Printed 23 Nov 2020

and any details on the application form and on any supporting information received with the application except as amended by the following conditions.

Note: The following must be submitted to Sutherland Shire Council prior to the

commencement of any building or subdivision work

- i) **The relevant** Construction Certificate.
- ii) Notification of the appointment of a Principal Certifying Authority and a letter of acceptance from that Principal Certifying Authority.
- iii) Notification of the commencement of building and/or subdivision works with a minimum of 2 days' notice of such commencement.

(Modified – Error! Reference source not found.)

Under Section 6.5 of the Environmental Planning and Assessment Act 1979, please note that Sutherland Shire Council must be appointed as the Principal Certifying Authority for all subdivision works.

3. Design Changes Required

A. Before Construction

The following design changes must be implemented:

i. ~~Parking basement level 1~~

~~As per Plan DA06 Basement Floor Plan – B1 Issue 1, as amended by Council 25 September 2019 the following amendments shall be made:~~

- ~~a) The stair well associated with Garage 22 shall be 'reversed' so that access is from the south. The stairwell shall also be moved south to facilitate parking for two cars in accordance with AS2890.~~
- ~~b) All double garages shall be provided with a minimum 5.2m wide door opening to be provided central to the location of the parking spaces.~~
- ~~c) All single and tandem garage spaces shall be provided with a minimum 2.8m wide door opening.~~
- ~~d) The garage door for garage 25 shall be splayed to facilitate improved entry and exit for 2 vehicles.~~

ii. ~~Parking basement level 2~~

~~As per Plan DA05 Lower Basement Floor Plan – B2 Issue 1, as amended by Council 25 September 2019, submit amended plans demonstrating:~~

- ~~A. — Basement 2 shall be amended to achieve compliance with AS2890.1, as per the following:~~
- ~~a) — As per AS2890.1, figure 5.2, the columns in Basement 2 adjacent to the central aisle must be moved 750mm into the parking spaces to facilitate manoeuvring.~~
 - ~~b) — The shared space in basement 2 must be 2.4m wide and incorporate a bollard.~~

iii. — Commercial parking basement level 2

- ~~a) — As per Plan DA10 Issue 1, East, North, West and South Elevations as amended by Council 30 October 2019; submit amended plans indicating the stair from commercial basement parking at Basement level 2, adjacent to the southern side of Building B shall be deleted.~~
- ~~b) — As per Plan DA05 Lower Basement Floor Plan – B2 Issue 1, as amended by Council 25 September 2019; and Plan DA07 Ground Floor Plan Issue 1, as amended by Council 25 September 2019 – submit amended plans indicating, a lift and stair exit shall be provided from basement 2 to ground level between Building A and Building B. This shall directly adjoin the pedestrian path to Heathcote Hall, and shall not encroach in the Heritage Curtilage or Heritage Buffer as per the endorsed CMP.~~

iv. — Adaptable townhouses

~~As per Plan DA06 Basement Floor Plan – B1 Issue 1, as amended by Council 25 September 2019; and Plan DA07 Ground Floor Plan Issue 1, as amended by Council 25 September 2019; submit amended plans indicating:~~

- ~~a) — Townhouses 7, 8, 11, 12, 13, 14 and 22 shall be dedicated as adaptable townhouses.~~
- ~~b) — Stair 04 shall be reconfigured so as to provide lift access in addition to stair access from the basement level 1, to provide access to Adaptable Townhouses 7 and 8 from the pedestrian path at ground level.~~

- ~~c) — A gate providing rear access directly to the rear private open space of Adaptable Townhouses 7 and 8 shall be provided from the pedestrian path at ground level.~~
- ~~d) — Direct and separate lift access from Basement Level 1 garages of Townhouses 11 and 12 shall be provided to each of these dwellings.~~
- ~~e) — Townhouses 13, 14 and 22 are to be provided direct access from basement 1 via the lift adjacent to Stair 06, to the rear Private Open Space of these dwellings, or each dwelling shall be allocated an individual lift from each respective basement level 1 garage.~~

~~v. — Livable Townhouses~~

~~As per Plan DA07 Ground Floor Plan Issue 1, as amended by Council 25 September 2019 and Plan DA06 Basement Floor Plan B1 Issue 1, as amended by Council 25 September 2019:~~

- ~~a) — Townhouse 27 shall be a livable dwelling, with a lift provided from the basement level 1 garage of this dwelling, the garage shall be a tandem garage.~~
- ~~b) — Townhouse 20 is not allocated as a livable dwelling as appropriate access cannot be provided.~~

~~vi. — Reconfiguration of Townhouses 11 and 12~~

~~— As per Plan DA07 Ground Floor Plan Issue 1, as amended by Council 25 September 2019, the areas highlighted in Yellow (Townhouse 11) and highlighted Blue (Townhouse 12) shall be allocated as gross floor area for each dwelling with a common party wall dividing each dwelling.~~

~~vii. — Landscaping General~~

~~All landscape plans shall be updated to reflect all approved built form as per the architectural plans prepared by Ink Architects, as per **Condition 1 Approved Plans and Documents**, and as amended by all other relevant conditions in this determination.~~

viii. Fire Hydrant Booster Assembly

The fire hydrant booster assembly shall be provided in accordance with the approved Architectural Plans and in consultation with a fire engineer and hydraulic engineer to the satisfaction of Fire and Rescue NSW and the Heritage Council of NSW.

In the event that design changes are required (including to the size, type of the booster assembly, the requirements for a freestanding wall / radiant heat shield, FRNSW emergency vehicle hardstand etc) these plans shall be submitted for approval by the Director, Shire Planning prior to the issue of the relevant Construction Certificate.

~~As per Plan DA05 Lower Basement Floor Plan – B2 Issue 1, as amended by Council 25 September 2019; Plan DA07 Ground Floor Plan Issue 1, as amended by Council 25 September 2019; and Plan DA06 Basement Floor Plan – B1 Issue 1, as amended by Council 25 September 2019, the fire hydrant booster assembly as indicated adjacent to townhouse 2 shall be relocated to minimise the visual impact upon the streetscape of Boronia Grove. Amended Plans shall be submitted for approval by the Director, Shire Planning prior to the issue of **the relevant** Construction Certificate, and as per the following:~~

~~(Modified – Error! Reference source not found.)~~

- ~~a) The fire hydrant booster assembly shall be relocated, and designed in consultation with a fire engineer and hydraulic engineer; and to the satisfaction of Fire and Rescue NSW and the Heritage Council of NSW, in order to erect a hydrant booster without the need for a detached radiant heat shield as required by E1.3 of the BCA or AS2419.1-2005 or AS2419.1-2017.~~
- ~~b) The fire hydrant booster assembly shall be located parallel to Boronia Grove, fully contained within the site, and at the property boundary.~~

- ~~c) — The location of the fire hydrant booster assembly shall be erected in a location adjacent to the Communal Pedestrian entry stair adjacent to Townhouse 3 and Stair 01 of Basement Level 1 and Basement level 2. And shall be fully recessed into and under any stair/landing/structure. The fire hydrant booster assembly alcove shall be screened by non-lockable gates.~~
- ~~d) — The fire hydrant booster assembly will require an adjacent fire rated free standing wall with an FRL not less than 90/90/90 and extend not less than 1m each side of the outermost hydrant booster riser (a minimum of 3m wide) and extend to a height not less than 2m above the finished ground level.~~
- ~~e) — The communal pedestrian entry stair is to be relocated or reoriented to accommodate the relocated fire hydrant booster assembly and contained wholly within the site, without reducing the deep soil area, or impacting upon trees in the vicinity of the stairs.~~
- ~~f) — The relocation of the fire hydrant booster assembly may require the reorientation of Stair 01 of Basement Level 1 and Basement Level 2.~~
- ~~g) — As a result of the relocation of the fire hydrant booster assembly, the north facing courtyard of townhouse 3 shall be reduced in depth to be setback a minimum of 3.5m from the fire hydrant booster assembly, resulting in a reduction in the depth of this courtyard by a minimum of 1.5m in depth as shown in black hatching on *Plan DA07 Ground Floor Plan Issue 1, as amended by Council 25 September 2019.*~~
- ~~— The north facing elevated Courtyards of Townhouses 2 and 3 shall have a minimum setback of 4m from the Boronia Grove boundary.~~

~~The existing ground levels in this front setback along shall remain as per the existing natural ground levels, no cut and fill shall occur in the areas outside the building foot print. No reshaping, battering,~~

~~excavating or filling of the original ground surface is permitted within this area. Where building edges or feature walls are required adjoining/adjacent to the trees on Council verge or within the site; they must be constructed so as to minimise impact upon the adjoining landscape, and present a vertical face to the street, as per Plan DA10 Issue 1, East, North, West and South Elevations, as amended by Council 30 October 2019.~~

~~The resulting landscaped area to the north of the paved private open space of townhouse 3 shall be appropriately landscaped to screen the retaining wall of townhouse three (3). As the subject site is identified as being within a Greenweb Core area, all new plantings in this increased setback must be indigenous species selected from Council's 'Native Plant Selector' available on Council's website (www.sutherlandshire.nsw.gov.au and search for Native Plant Selector).~~

- ~~h) — All other fire hydrant boosters and meters must be fully enclosed and incorporated within the building fabric associated with the townhouses and residential flat buildings.~~

~~ix. — Stair on the east-west carriage way~~

- ~~a) — As per the General Terms of Approval issued by the Heritage Council (10 October 2019), and as per Plan DA07 Ground Floor Plan Issue 1, as amended by Council 25 September 2019; the stair associated with the east-west carriage way in front of townhouses 29-31 inclusive, shall be deleted and the carriageway designed in accordance with the requirements of the Heritage Council.~~
- ~~b) — Any additional stairs required to townhouses 29-31 (inclusive), as a result of the deletion of the stairs on the east-west carriageway required by condition (ix)(a) above, are to be incorporated into the individual paths leading from the carriageway to the front entries of the townhouses, and shall not encroach into the east-west carriageway.~~

~~c) The finished levels of the east-west carriageway must be determined in consultation with the Heritage Council.~~

~~x. Dwelling 28~~

~~A laundry is required to be provided within the approved footprint of dwelling 28.~~

~~**Details of these design changes must be included in documentation submitted with the application for the relevant Construction Certificate.**~~

~~(Modified – Error! Reference source not found.)~~

4. Integrated Development Approval - Requirement of Approval Bodies

A. General Terms of Approval from Other Approval Bodies

The development must be undertaken in accordance with all General Terms of Approval (GTA) of the following approval bodies under Section 91A of the Environmental Planning and Assessment Act 1979:

- (i) NSW Heritage Council (dated 10 October 2019 **25 August 2021**)
- (ii) NSW Rural Fire Service (dated 27 April 2018)

A copy of the GTAs and any further requirements of the approval body/bodies are attached to this development consent. These requirements must be incorporated in the application for **the relevant** Construction Certificate.

10. Lift Design to accommodate stretchers

~~All lifts to be installed as part of this development~~ **The lifts servicing Apartment Buildings A and B** must be designed to accommodate stretchers to be used by the NSW Ambulance Service.

Approval of lifts ~~to be used~~ **servicing Apartment Buildings A and B** must be gained by the NSW Ambulance Service prior to the issue of any Construction Certificate.

18. Internal Driveway, Parking and Manoeuvring

A. Design

The internal driveway profile, parking and manoeuvring areas must be designed in accordance with the approved architectural plans except where modified by the following:

- i. Align with Access and Alignment levels issued by Council's Public Domain Unit.
- ii. The proposed loading and delivery area must be clearly defined with suitable signposting and pavement markings.
- iii. The car park must be able to accommodate a minimum 128 vehicles.
- iv. Provide adequate sight distance for the safety of pedestrians using the footpath area.
- v. ~~Provide a maximum grade of 5% for the length required to accommodate the waste collection vehicle.~~
- vi. The maximum longitudinal grade of the driveway must not exceed 25%.
- vii. The crest for the driveways providing access to the basement car parks should be a minimum of the kerb level.
- viii. ~~Comply with AS2890.1(2004) in relation to the design of vehicular access, parking and general manoeuvring for the B85 vehicle. This will require amending the widths, lengths, column location and location of some of the parking spaces, as per the **Condition 2 - Design Changes**.~~

B. Construction

Certification from an appropriately qualified engineer to the effect that the design requirements of "A" above have been met must accompany the **relevant** Construction Certificate.

C. Occupation

Prior to the occupation of the development or the issue of any occupation certificate a suitably qualified engineer must certify that the works required in "A" above were undertaken and completed to their satisfaction and in accordance with the requirements of this Development Consent. This certification must be provided to the PCA and a copy also provided to Council.

D. On-going

The approved parking must be used exclusively for car parking as approved for the life of the development.

30. Landscaping Works

A. Design

The landscaping works must be designed in accordance with the approved Landscape Plan, except where modified by the following, and submitted to the Director of Shire Planning for approval prior to the issue of **the relevant** Construction Certificate: **(Modified – Error! Reference source not found.)**

- i. All approved landscape plans shall be in accordance with the approved architectural and stormwater plans.
- ii. Amend the Existing Trees Plan, if required, in accordance with findings by Council's Arborist and the supervising Consulting Arborist following a site inspection carried out prior to any demolition works on site. The purpose of the inspection is to physically mark existing trees that are to be removed or pruned.
- iii. Show on plan Tree Protection Zones (TPZ) and the outline of protective fencing for all existing trees and heritage site features to be retained and protected.
- iv. Provide detailed planting plans for all landscaped areas showing plant locations, species and numbers that achieve a minimum plant density of 4 plants per sqm to ensure good coverage and to inhibit weed growth.
- v. Where building edges or feature walls are required adjoining/adjacent to the trees on Council verge or within the site; they must be constructed so as to minimise impact upon the adjoining landscape, and present a vertical face to the street.
- vi. No reshaping, battering, excavating or filling of the original ground surface outside the building footprint, is permitted. Where building edges or feature walls are required adjoining/adjacent to the trees on Council verge or within the site; they must be constructed so as to minimise impact upon the adjoining landscape, and present a vertical face to the street.

- vii. The existing soil profile and ground levels must be retained around the ALL existing trees to the north of townhouses 1 to 17 inclusive along Boronia Grove, and townhouses 18 to 21 on Tecoma Street, both on the Council verge and within the site. No reshaping, battering, excavating or filling of the original ground surface is permitted within this area.
- viii. Ensure that new plantings satisfy the RFS bushfire code, heritage view corridors and STIF revegetation requirements.
- ix. Provide detailed hardworks details including all paving, ramps, stepping stones, walls, steps, edgings, fencing, gates and furniture. Note that all landscape retaining walls and planter boxes must be constructed in masonry, stone or gabions. Timber is not acceptable.
- x. Provide detail levels of all courtyards and hardworks to confirm the protection of all existing trees to be retained.
- xi. Clarify the location and extent of fencing around the heritage compound and kitchen gardens and orchard. Ensure that fencing is located a minimum distance of 600mm away from the trunks of Trees 99, 99D, 112, 113, 114 and 124.
- xii. In the heritage kitchen gardens and orchard delete the section of raised planting bed within the TPZs of Trees 99, 99B and 99C.
- xiii. Provide minimum soil depths in planter boxes as follows:
 - 1200mm for large trees.
 - 900mm for small trees and tall shrubs.
 - 600mm low shrubs.
 - 450mm grass and ground covers.
- xiv. To improve coverage and reduce weeds and maintenance, planting densities in all planting areas must achieve a minimum of 4 plants per square metre.
- xv. To reduce long term maintenance of planting beds turf species must be native grass such as Zoysia 'Nara' or Buffalo varieties.
- ~~xvi. Each townhouse and ground floor unit must be provided with a clothes line in the rear garden easily accessible from the laundry. Each unit above the ground floor must be provided with a clothes line on a balcony. Ensure that clothes lines are not visible above the balustrade.~~

- xvii. The communal open space areas and all planter boxes on slab must be provided with a water-efficient irrigation system and taps at 25m centres, connected to a pump and the rainwater tank, to enable effective landscape maintenance.
- xviii. Each area of private open space for townhouses and ground floor units must be provided with a tap, connected to mains water. In townhouses provide one tap in front garden and one tap in the rear garden.
- xix. As the subject site is identified as being within a Greenweb Core area, all new plantings around the perimeter of the site and along the public pathways must be indigenous species selected from Council's 'Native Plant Selector' available on Council's website (www.sutherlandshire.nsw.gov.au and search for Native Plant Selector). Within the Private Open Space of the townhouses at least 50% of tree and understorey species must be indigenous species. Within the Heritage Precinct exotic species are permitted in accordance with the Heritage Landscape Architect's plans except for the perimeter area bounded by the driveway and Dilwynnia Grove and Tecoma Street where indigenous species should predominate. **The *Pittosporum undulatum* & *Pittosporum revolutum* species shall be substituted with an alternate species in accordance with the above.**
- xx. *Eucalyptus saligna x botryoides* is not generally available from Council's or other nurseries. Seed for this species must be collected from the site and the trees propagated in advance of planting.

The applicant must engage a suitably qualified Landscape Designer or Landscape Architect to oversee any design changes to the approved Landscape Plan and amendments required above. Details of these design changes must be included in the documentation submitted with the application for **the relevant** Construction Certificate. **(Modified – Error! Reference source not found.)**

Notes:

A Landscape Designer is a person eligible for membership of the Australian Landscape Designers and Managers and a Landscape Architect is a person

eligible for membership of the Australian Institute of Landscape Architects as a Registered Landscape Architect.

If demolition works to occur prior to the **relevant** Construction Certificate being issued, tree protection measures must be installed prior to commencement of demolition. **(Modified – Error! Reference source not found.)**

B. Prior to Occupation/Occupation Certificate

The landscape works must be completed in accordance with the approved Landscape Plan and amendments required by 'A' above. A Final Landscape Inspection must be carried out and a certificate issued by Council's landscape officer prior to occupation or the issue of an Occupation Certificate (interim or final). This certificate is required to ensure that all tree protection measures, landscaping works, replacement tree planting and the deep soil percentage requirements have been carried out in accordance with 'A' above and other conditions within this consent, and that all new indigenous plants on the site and within the road reserve are the correct species.

To arrange a Final Landscape Inspection please phone 9710-0333 48 hours prior to the required inspection date. An inspection fee of \$230 is required to be paid, prior to the inspection. Additional inspections will be charged at a rate of \$103 each.

C. Ongoing

All landscaping works required by 'A' above must be maintained for 12 months following the final landscape inspection date. Trees required by this condition must be maintained and protected until they are covered by Council's Controls for Preservation of Trees and Bushland Vegetation (SSCDCP 2015 Chapter 38).

Any plants found faulty, damaged, diseased or dead shall be replaced with the same species in the same sized container within one month with all costs borne by the owner.

Note: If difficulty is experienced sourcing suitable indigenous plants from other suppliers, plants grown from locally provenance seed may be available from:

Sutherland Shire Council Nursery
345 The Boulevard, Gympie
Ph: 02 9524 5672

31. Tree Removal on Private and Council Land

The removal of the following trees is approved:

- i) Trees identified on the approved Landscape Plan as “existing tree to be removed” and in accordance with the findings by Council’s Arborist and the supervising Consulting Arborist following a site inspection carried out prior to any demolition works on site.
- ii) Any declared noxious plant. The applicant is to ensure that all noxious plants are properly identified and controlled/removed.
- iii) Any tree species exempted by the Sutherland Shire Local Environmental Plan 2015.

All other vegetation that would require approval to be removed must be protected.

A. Tree Replacement

- i) Approximately ~~46~~ **47** trees within the site and 8 street trees covered by the TPO (excluding trees in very poor health) are approved for removal as part of this consent. Where trees are proposed to be removed Sutherland Shire Council requires indigenous replacement canopy tree planting at a ratio of 8:1 on private land and 4:1 on Council land (Council Resolution EHR003-17 of 18 July 2016).
- ii) Approximately ~~400~~ **408** replacement trees are required to be planted.
In determining this application, the extent of compensatory planting has been reduced as the development has been sensitively designed to maintain existing bush land or trees such that it makes a positive contribution to the local landscape character.

- iii) The final number of replacement trees to be planted on the site and the street will be determined once the detailed landscape plans have been approved by Council, the RFS and the Heritage Office prior to the issue of the Construction Certificate. Replacement trees within the site must be planted within 3m of the front or rear setback of the subject property and not within 4m of an existing or approved building or structure.
- iv) Trees must have a minimum container size of 5 litres.

Note: Where replacement trees required by “B ii)” above are unable to be planted on the site or in the street, Council offers offsite planting under a ‘Deed of Agreement’ as an alternative to on site planting, at a cost of \$100 per tree. Offsite planting will be undertaken as part of Council’s Green Street Program. ‘Deed of Agreement’ forms can be downloaded from Council’s website at www.sutherlandshire.nsw.gov.au/Development/Development-Applications/Off-Site-Tree-Replacement-and-Deed-of-Agreement. A completed form and payment must be submitted to Council prior to the release of the Construction Certificate.

B. Tree Removal on Council Land

Council has preferred supplier agreements in place with arborists who are approved to carry out arbor works on Council land. Removal / pruning of the tree/s listed below must only be undertaken using Council’s preferred supplier at the applicant’s expense. The applicant is responsible for contract management and payment of the arborist prior to works being undertaken.

Select from Council's list of preferred suppliers listed on Council’s website: <http://www.sutherlandshire.nsw.gov.au/Residents/Trees/Trees-on-Council-or-Public-Land>. Payment of the quoted amount provided must be made prior to any works commencing on site.

C. Prior to Occupation/Occupation Certificate

The replacement tree planting must be completed in accordance with the approved Landscape Plan/ required street tree planting. Certification will be provided as part of the Final Landscape Inspection by Council’s landscape

officer (refer Condition - Approved Landscape Plan).

D. Ongoing

Trees required by this condition must be maintained and protected until they are covered by Council's Controls for Preservation of Trees and Bushland Vegetation (SSCDCP2015 Chapter 38). Any replacement trees found damaged, dying or dead must be replaced with the same species in the same container size within one month with all costs to be borne by the owner.

Note: If you have difficulty sourcing suitable indigenous plants from other suppliers, plants grown from local provenance seed may be available from:

Sutherland Shire Council Nursery

345 The Boulevarde, Gymea

Ph: 02 9524 5672

Opening hours - Monday to Friday 7.00am-3.00pm (excluding public holidays).

45. Photographic Archival Recording

a) A photographic archival recording of the place is to be undertaken prior to the commencement of works and submitted to Council's Heritage Officer for assessment and approval. The recording should capture the heritage site generally but focus on the cottage. The archival recording must be prepared in accordance with the Heritage Council of NSW guidelines, in particular Photographic Recording of Heritage Items Using Film or Digital Capture; and the General Terms of Approval dated 10 October 2019, issued by the Heritage Council. A minimum of three copies are to be produced: one for Council, the second for the local council's local studies library and the third to be retained by the owner; and any other copies as required by the Heritage Council of NSW.

68. Car parking Areas

A. Ongoing

To ensure that the car parking area satisfies the demands of the development:

- i) it must be made available on an unrestricted basis and free of charge at all times for ~~employees' and~~ visitors' vehicles
- ii) any parking nominated as visitor parking or common property must be continually available as common property.

69. Car Parking Allocation

A. Before Subdivision

Residential car parking must be allocated to individual strata lots as part of their unit entitlement.

Visitor parking facilities and/or car wash bays must be designated as common property on any strata plan.

Parking must be allocated on the following basis:

- ☐ Residential dwellings: a minimum of 1 space per one bedroom dwelling; 1.5 spaces per two bedroom dwelling; and 2 spaces per three bedroom dwelling.
- ☐ Residential visitors: a minimum of 1 space per 4 dwellings
- ☐ Car wash bay(s): 3 spaces total
- ☐ Bicycle bays: 10 spaces total
- ☐ ~~Retail/commercial: minimum of 12 spaces, including a minimum of eight spaces to be provided in the separate basement level 2 commercial parking.~~
- ☐ ~~Loading/servicing: wholly within the site and within the driveway waste collection/ loading area~~

B. Ongoing

The car-parking provided must only be used in conjunction with the dwellings and/or tenancies contained within the development and not for any other purpose.

Note: This condition has been imposed to ensure that the car parking spaces are only used for car parking by the unit that it has been allocated to. It is intended to restrict the sale or subleasing of car parking to parties unrelated to each strata entitlement. Council's condition is a "restrictive use condition" pursuant to the Strata Schemes Development Act 2015 and should be noted as such on any future the Strata Certificate.

New Condition 72 ~ Waste Collection (Kerbside Collection)

A. Design

To ensure the proper storage of waste from the premises:

- i) The temporary bin holding areas within the Dillwynnia Grove and Boronia Grove frontages shall be deleted and the areas maintained as landscaping.**
- ii) The permanent garbage and recycling storage bin store areas must have sufficient space for the storage of all bins required for the development**
 - a. 28 x 240L garbage bins**
 - b. 56 x 240L co-mingled recycling bins.**

B. Before Construction

Details of compliance with 'A' above must form part of the documentation accompanying the applications for a Construction Certificate.

A. Before Occupation

The works must be completed prior to the issue of any Occupation Certificate.

C. On-going

- i) All ongoing management, maintenance and cleaning of all waste and recycling management facilities is to be carried out in accordance with the approved Waste Management Plan for the development.**
- ii) All waste and recycling bins must be stored wholly within the approved waste storage areas. The bins must only be put out for**

kerbside collection in the evening prior to pick-up and returned to the storage area as soon as possible after pick-up.

Submissions

	Address	Date of Submission	Summary of Issues Raised
1	9 Woodford Cres Heathcote	11 March 2021 (2 Submissions)	<p>Opposed to the development</p> <p>Increased Traffic congestion</p> <p>Bushfire Safety Concerns</p> <p>“Incongruous nature of apartments in Heathcote east” = Out of character</p> <p>Evacuations/traffic safety concerns.</p> <p>Opposed to the removing of basement parking</p> <p>Commercial parking’s removal will impact upon street parking</p> <p>Traffic congestion</p> <p>Bushfire safety concerns</p> <p>Out of character</p> <p>Safety concerns</p> <p>No indication as to the use for the hall itself</p>
2	27 Boronia Grove Heathcote	11 March 2021	<p>Opposed to demolition of the commercial carpark</p> <p>Concerns that a retrofit of the commercial carpark would not be easy if the use of the hall was to change in the future.</p>
3	44 Dillwynia Grove Heathcote	12 March 2021	<p>Out of character</p> <p>Opposed to the development</p> <p>Increased Traffic congestion</p> <p>Bushfire Safety Concerns</p> <p>Evacuations/traffic safety concerns.</p> <p>Supportive of the commercial removal – pending “execution”</p> <p>Concerns about transparency and the developer removing the carpark for cost cutting to then revert back to another design</p> <p>Objector proposes that the hall should be restored prior to any construction of residential accommodation</p>
4	39 Boronia Grove 11 March 2021	13 March 2021	<p>Disappointed in the result of the approval of the DA</p> <p>Opposed to the removal of commercial carpark as this will increase the demand on street parking</p>
5	DPIE – Royal National Park	20 March 2021	<p>Asked Council to review and consider <i>Guidelines for developments adjoining land managed by the Office of Environment and Heritage</i> (DPIE guidelines)</p> <p>Whilst the actual development is off park, there are potential impacts on Royal National Park from additional stormwater occurrence. Thus in addition to the requirements in the guidelines above, DPIE provide the following comment. DPIE refer Council to Section 2.2 of the above OEH guidelines which relate to storm water runoff. The developer must consider</p>

			not to direct stormwater to park where possible. The above guidelines recommend the development proponent ensure all storm water storage areas and associated infrastructure are appropriately sized and maintained to ensure that there is no unauthorised overflow onto DPIE land. The proponent should consider stormwater retention on site and utilising existing council drainage structures rather than diverting flows into Royal National Park.
6	38 Tecoma Street Heathcote	2 April 2021	<p>Opposed to the reduction in car parking spaces Extra cars on the street will impact the ability to access fire supplies/hose etc Pedestrian Safety Evacuations/traffic safety concerns. Doesn't comply with the E4 provisions Amenity impacts on the community Should have a new DA for such major changes Increase in traffic Noise Requests more time for submissions to be lodged Modification reduces parking and quality of the development</p>
7	4 Dillwynnia Grove Heathcote	2 April 2021	<p>Opposed to the original assessment / approval and proposed changes including removal of commercial parking Heathcote Hall should be fully restored and habitable before being sold as a residence Future use of Heathcote Hall into commercial and inability to provide parking at a later stage Traffic congestion and parking including resident / visitors to Heathcote Hall Bushfire safety, risk, evacuation, design and compliance with planning requirements including E4 zoning Protection of historic carriageway and restoration of Heathcote Hall Undesirable visual aesthetic of development and BCA compliance Land contamination Power supply</p>
8	No Address	13 April 2021	<p>Opposed to the changes Concerned about more cars on local roads reducing local amenity</p>
9	28 Dillwynnia Grove	13 April 2021	<p>Opposed to the development generally Not enough parking for the proposed residents Street parking will be crowded Traffic increase Amenity impacts Changes should require a new DA</p>

			Supportive of private residence Concerned about transparency of process
10	No Address	13 April 2021	Community not pleased with the approval of the DA Opposed to the deletion of the parking spaces due to the impact this will have on street parking
11	No Address	13 April 2021	Opposed to the modification Narrow roads can't cope with more cars. Traffic/street parking Cost to the community as a result of the developer trying to save money
12	44 Dillwynnia Grove Heathcote	13 April 2021	Frustration with the process surrounding the approval Risk to the community Parking and pedestrian safety as a result of extra traffic Amenity impact – need to the road widening Should keep the commercial parking as visitor parking Concerns about timing – wants a DA for the use of the hall Wants Council to confirm what the road works will look like Wants confirmation that the hall is fully restored before the town houses are built
13	14A Bottle Forrest Road Heathcote	16 April 2021	Opposed to the modification Frustrated with lack of consultation with modifications Question about OC separate CC's Private ownership of the Hall is not what was agreed to by the planning panel-the approval of this contentious development was in part dependent on the public use of the redeveloped hall.
14	14A Bottle Forest Road Heathcote	16 April 2021	Opposed to the modification Frustrated with lack of consultation with modifications Concerned about splitting the development into two construction certificates Concerns about the hall being maintained if private ownership is exercised Private ownership is only to reduce costs
15	Councillors D Steinwall and G McLean	19 April 2021	Concerns stem from what we believe was the above SSPP approval, which included an additional weighting (the height, number of apartments, dimensions, foot print etc) for the construction scope based upon, a degree of consideration, of Heathcote Hall being repurposed for a use which would include a degree of public access

			<p>Concerned about demands placed on street parking as a result of the removal of the commercial parking</p> <p>Concerned about how the staging of the construction will be undertaken</p> <p>Request for the email to be listed as an objection</p>
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Mr Evan Phillips
Sutherland Shire Council
Locked Bag 17
SUTHERLAND NSW 1499

By email: Evan Phillips EPhillips@ssc.nsw.gov.au

Dear Mr Phillips

**HERITAGE COUNCIL OF NSW – GENERAL TERMS OF APPROVAL
s.4.55 MODIFICATION (s.4.55/2021/10)**

Site: 1-21 Dillwynnia Grove, Heathcote Hall (SHR No 00191)

Proposal: This modification application seeks approval to remove commercial car parking within basement Level 2, respond to the conditions of consent which require changes to the design, improve the overall design and functionality of the development and improve the residential amenity of the development

IDA application no: IDA/2017/55 (DA17/0467)

s.4.55 application no: s.4.55/2021/10

Information received with the s.4.55 application: As listed below.

As delegate of the Heritage Council of NSW (the Heritage Council), I have considered the above integrated development application. In accordance with Section 4.47 of the *Environmental Planning and Assessment Act 1979*, the following general terms of approval are granted: (A copy of the original terms of approval are included below with modifications shown by striking through text, and additions in ***bold italics***)

APPROVED DEVELOPMENT

1. Development must be in accordance with:
 - a) Architectural drawings, prepared by Tropman and Tropman Architects as listed below:

Drawing No.	Title	Date	Rev
Project Name: Heathcote Hall			
Ex100	Existing Site Plan	23/11/17	A
Ex101	Ground Floor	23/11/17	A
Ex102	Existing First Floor	23/11/17	A
Ex110	Existing Elevation S-W	23/11/17	B
Ex111	Existing Elevation S-E	23/11/17	A
Ex112	Existing Elevation N-W	23/11/17	A
Ex113	Existing Elevation N-E	23/11/17	A
PR.200	Existing Roof Plan	23/11/17	F

PR.201	Proposed Ground Floor Plan	23/11/17	F
PR.202	Proposed First Floor Plan	23/11/17	F
PR.210	Proposed Elevation S-W	23/11/17	F
PR.211	Proposed Elevation N-W	23/11/17	F
PR.212	Proposed Elevation N-E	23/11/17	F
PR.213	Proposed Elevation S-E	23/11/17	A

b) Architectural drawings, prepared by Ink Architects, as listed below:

Dwg No	Dwg Title	Date	Rev
Project Name: Historic Heathcote Hall – 1-21 Dillwynnia Grove, Heathcote, Sutherland			
DA00	Cover Sheet	27/08/19	↓
DA04	Site Plan Roof Plan	17/09/19	↓
DA02	Demolition Plan	5/12/17	A
DA05	Lower Basement B2	27/08/19	↓
DA06	Basement Floor Plan – B1	27/08/19	↓
DA07	Ground Floor Plan	27/08/19	↓
DA07-CMP	Ground Floor Plan CMP	27/08/19	↓
DA08	First Floor Plan	27/08/19	↓
DA08-CMP	First Floor Plan CMP	27/08/19	↓
DA09	Second Floor Plan	27/08/19	↓
DA09-CMP	Second Floor Plan CMP	27/08/19	↓
DA10	East, North, West & South Elevations	27/08/19	↓
DA11	Sections A-A, B-B, C-C & D-D	27/08/19	↓
DA12	Sections E-E, F-F, G-G, H-H, & I-I	27/08/19	↓
DA13	Sections H-H, J-J, K-K	27/08/19	↓
DA15	FSR Calculations	27/08/19	↓
DA16	Adaptable and Liveable Dwellings	27/08/19	↓
DA24	Building A Area Over 8.5m	27/08/19	↓
DA20	Material Finishes Board	27/08/19	↓
DA21	Material Finishes	20/03/19	↓
DA29	Wayfinding	27/08/19	↓

Architectural drawings, prepared by DesignInc, as listed below:

Dwg No	Dwg Title	Date	Rev
Project Name:			
MOD00	Cover Sheet	15/01/2021	A
MOD01	Site Plan Roof Plan	15/01/2021	A
MOD05	Lower Basement B2	15/01/2021	A

MOD06	Basement Floor Plan - B1	15/01/2021	A
MOD07	Ground Floor Plan	15/01/2021	A
MOD08	First Floor Plan	15/01/2021	A
MOD09	Second Floor Plan	15/01/2021	A
DA10	East, North, West & South Elevations	15/01/2021	A
MOD11	Sections A-A, B-B, C-C & D-D	15/01/2021	A
MOD12	Sections E-E, F-F, G-G, H-H, & I-I	15/01/2021	A
MOD13	Sections H-H, J-J, K-K	15/01/2021	A
MOD15	FSR Calculations	15/01/2021	A
MOD16	Adaptable Townhouse 7, 8, 11 & 12	15/01/2021	A
MOD17	Adaptable Townhouse 13, 14, 22 & Apartment B101, B103, B201, B203	15/01/2021	A
MOD20	Material Finishes Board	15/01/2021	A
Project No P20-056 A2050	External Details - Substation	Unknown	
Project No P20-056 A2051	External Details – Hydrant Booster	19/01/2021	A

- e) ~~Landscape drawings, prepared by Site Design + Studios and Michael Lehany, as listed below:~~

Dwg No	Dwg Title	Date	Rev
Project Name: Heathcote Hall, 1-21 Dillwynnia Grove, Heathcote NSW			
L-06	Heritage Concept Plans-Italianate	11/12/17	C
L-07	Heritage Garden/ CMP Reference	11/12/17	D
L-7A	Heritage-CMP	11/12/17	D
L-09	Site Analysis	19/3/18	E
L-10	Interpretation	19/3/18	E
L-11	Landscape Masterplan	19/3/18	E
L-12	Landscape Plans – Levels	11/12/17	D
L-12A	Landscape Plans – Hydraulics	19/3/18	E
L-13	Landscape Plans – details	19/3/17	E
L-14	Existing Trees Plan	19/3/17	E
L-14A	Existing Trees Plan	19/3/17	E
L-15	Existing Tree Report – Draft	19/3/17	E
L-16	Incursions	19/3/17	E
L-17	Planting Areas Plan	19/3/17	E
L-18	Plant List	19/3/17	E

L-19	Landscape Plans – Materials	19/3/17	E
L-20	Details	19/3/17	E
L-21	Sections	19/3/17	E

c) Landscape drawings, prepared by DesignInc, as listed below:

Dwg No	Dwg Title	Date	Rev
Project Name: Heathcote Hall, 1-21 Dillwynnia Grove, Heathcote NSW			
LA-01	Cover Sheet	15/01/2021	A
LA-02	Site Calculations	15/01/2021	A
LA-04	Landscape Master Plan	15/01/2021	A
LA-05	Proposed Levels	15/01/2021	A
LA-06	Detail Design Concepts	15/01/2021	A
LA-07	Proposed Materials	15/01/2021	A
LA-08	Trees to be Removal and Retained	15/01/2021	A
LA-09	Trees to be retained with TPZ and SRZ	15/01/2021	A
LA-10	Planting Areas	15/01/2021	A
LA-12	Landscape Sections	15/01/2021	A
LA-13	Landscape Sections	15/01/2021	A
LA-14	Landscape Sections	15/01/2021	A
Fencing	Fencing	15/01/2021	A
LA-15	Fencing Details Sheet One	15/01/2021	A
LA-17	Fencing Details Sheet Two	15/01/2021	A
LA-18	Fencing Details Sheet Three	15/01/2021	A
LA-19	Fencing Details Sheet Four	15/01/2021	A
LA-20	Fencing Details Sheet Five	15/01/2021	A
LA-21	Fencing Details Sheet Six	15/01/2021	A

Landscape drawings, prepared by DesignInc, as listed below:

Dwg No	Dwg Title	Date	Rev
Project Name: Heathcote Hall, 1-21 Dillwynnia Grove, Heathcote NSW			
LAH-00	Heritage Landscape Cover Sheet	18/03/2021	A
LAH-08	Heritage Landscape Heritage Fencing Plan	18/03/2021	A

Civil Drawings, prepared by SCP Consulting, as listed below:

Dwg No	Dwg Title	Date	Rev
Project Name: Heathcote Grounds Historic Heathcote Hall Civil Works S4.55 Package			
C-01-01	Drawing Schedule, Legend and Locality Plan	16/12/20	4
C-01-02	Specification Notes	16/12/20	4
C-03-01	Siteworks and Grading Plan	16/12/20	4
C-03-11	Pavement Plan	16/12/20	4
C-03-51	Siteworks Details	16/12/20	3
C-04-11	Typical Sections	16/12/20	3
C-04-21	Driveway Long Sections – Sheet 01 of 03	16/12/20	3
C-04-22	Driveway Long Sections – Sheet 02 of 03	16/12/20	3
C-04-23	Driveway Long Sections – Sheet 03 of 03	16/12/20	3
C-05-01	Stormwater Drainage Layout Plan	16/12/20	4
C-05-21	Stormwater Catchment Plan	16/12/20	3
C-05-61	Stormwater Details	16/12/20	3
C-06-01	Sediment and Erosion Control Plan	16/12/20	4
C-06-11	Sediment and Erosion Control Details	16/12/20	4

- d) ~~Heathcote Hall, 1-21 Dilwynnia Grove, Heathcote, NSW – Revised Heritage Impact Statement, prepared by Tropman and Tropman Architects, dated December 2017, as amended by Condition 1 b) above.~~
- e) *Heathcote Hall, 1-21 Dilwynnia Grove, Heathcote, NSW - Schedule of Works, prepared by Tropman and Tropman Architects, dated April 2017.*
- f) *Heathcote Hall, 1-21 Dillwynnia Grove, Heathcote NSW – Conservation Management Plan, prepared by Anne Warr Heritage Consulting, dated 18 July 2017.*
- g) ~~Statement of Environmental Effects: Proposed restoration of the State Significant Historic Heathcote Hall and Gardens Incorporating the Development of 36 Town Houses and 21 Units Including Basement Parking, prepared by HGPS, dated 12 April 2017, as amended by Condition 1 b) above.~~
- h) ~~Addendum to the Statement of Environmental Effects – 1-21 Dillwynnia Grove, Heathcote, prepared by HGPS, dated 11 December 2017, as amended by Condition 1 b) above.~~
- i) *Heritage Landscape Assessment by the Expert Michael Lehany, prepared by Michael Lehany, dated 9 March 2017 (included as Appendix to HIS.*
- j) *Report titled RE: Addendum Arborist Report at Heathcote Hall, 1-21 Dillwynnia Grove, Heathcote (The Site) – DA 17/1467 with Sutherland Shire Council (Council), prepared by Jacksons Nature Works, dated 8 March 2018.*

- k) *Flora and Fauna Report: Heathcote Hall Residential Development*, prepared by Eco Logical Australia, dated 8 March 2018 (refer to DOC17/636504-26).
- l) *Quantity Surveyors Construction Cost Report – Historic Heathcote Hall, 1-21 Dillwynnia Grove, Heathcote NSW*, prepared by Mitchell Brandtman, dated April 2017, as amended by Condition 1 b) above.
- m) *Re: Proposed Re-Development of ‘Heathcote Hall’ 1-24 (sic) Dillwynnia Grove – Quantity Surveyors Construction Cost Report*, prepared by Mitchell Brandtman, dated 1 May 2017, as amended by Condition 1 b) above.
- n) *Heathcote Hall – Buffer Zone Planting Report*, prepared by Tropman and Tropman Architects, dated 9 April 2019.

EXCEPT AS AMENDED by the following conditions of this approval:

DEFERRED COMMENCEMENT - HERITAGE AGREEMENT

2. The approval for refurbishment and restoration of Heathcote Hall, construction of 35 townhouses and 20 apartments, extensive landscape works, and 56 lot strata subdivision is subject to Deferred Commencement in accordance with s63A of the Heritage Act 1977. This approval is subject to the following condition:

- a) The applicant is to enter into a heritage agreement with the Minister for Heritage – and have it registered on the title of the property – to ensure:
 - i. the appropriate conservation works are undertaken prior to the issue of an Occupation Certificate for any new residential development within the curtilage;
 - ii. development and implementation of a comprehensive maintenance plan which identifies urgent, short, medium and long-term maintenance works in perpetuity;
 - iii. appropriate interpretation in accordance with an approved interpretation strategy, implemented prior to the issue of an Occupation Certificate for any new residential development within the curtilage;
 - iv. an annual open day to allow public access to Heathcote Hall;
 - v. no new structures to be constructed within the reduced landscape setting of Heathcote Hall; and
 - vi. funding to implement conservation and maintenance works as well as interpretation.

Reason: Despite the adverse heritage impact on the setting of the place, the proposed development is considered the only viable means of funding the required works to conserve the place in perpetuity.

FUTURE WORKS APPLICATION

3. ***The historic use of the Heathcote Hall as a single dwelling shall be retained. A restriction-to-user under the provisions of Section 88B of the Conveyance Act shall be created over Lots 1-2 in DP725184 to prohibit the use of Heathcote Hall for any***

other use other than for single dwelling. The document shall be submitted to both Sutherland Shire Council and the Heritage Council of New South Wales for endorsement prior to lodgement with Land Titles Office for registration. Proof of lodgement with and registration by the Land Titles Office of the endorsed instrument shall be lodged with Sutherland Shire Council prior to issue of any occupation certificate or any subdivision certificate. The only authorities authorised to alter, amend, remove, rescind or otherwise vary the restriction shall be Sutherland Shire Council and the Heritage Council of New South Wales with both authorities being required to concur.

Reason: Removal of the basement parking is approved on the basis the future use of Heathcote Hall will remain as a single dwelling. It is noted a separate Development Application (DA21/0393) has been submitted to demonstrate the applicant's commitment to retain the historic use of Heathcote Hall as a single dwelling.

4. Conservation works set out in the Schedule of Works are approved. However, works relating to the service upgrade and adaptive reuse of Heathcote Hall are not approved, including:
 - a) kitchen exhaust;
 - b) WCs (A12, B11);
 - c) widening of door (D15);
 - d) removal of dividing wall (between B8 and B11);
 - e) air-conditioning; and
 - f) flat roofed structure (A14).

The use and fitout of the place is to form a separate, future application.

Reason: Modifications for a potential future use is premature and could unnecessarily impact significant fabric. Whilst sympathetic adaptive reuse is encouraged, and the proposed modifications may be acceptable, without more detail and a definitive use it is not possible to undertake a thorough heritage impact assessment.

ADDITIONAL INFORMATION

5. ***Landscape Drawings no's LA-03, LA-11, and LAH-01-07, all prepared by DesignInc, submitted with this Section 4.55 application are not satisfactory and therefore, not approved. Amended landscape plans and supporting information shall be submitted with the section 60 application for approval by the Heritage Council of NSW (or delegate), to address the following:***
 - a) ***Drawing LA03 needs better justification as to how subsidiary paths relate to known 19th century layout, path dimensions and materials, in relation to now-proposed widths, materials and treatment.***
 - b) ***Removal of all proposed Buxus (box) hedging, lining driveway, paths and garden bed edgings. There is no precedent on this site for box or other hedges, even if used in Victorian gardens, elsewhere.***
 - c) ***Demonstrating in more detail how these plans and documents comply with and implement requirements of the CMP policies as included in Attachment A.***

6. In order to clarify issues and enable a thorough impact assessment, the following information is to be submitted with the section 60 application for assessment **approval** by the Heritage Council of NSW (or delegate):

a) **Revised, more detailed** ~~Detailed~~ planting plans are required and are to include proposed revegetation areas, particularly those to the main hall's south and east. Detailed management strategies to retain significant views to Dillwynia Grove from Heathcote Hall and views from its remnant and recreated drive, paths, pleasure gardens by:

- i. controlling shrub heights;
- ii. only planting new native trees under or near mature existing ones to bolster groves and elsewhere in the hall's south;
- iii. removing new tree seedlings in most of the southern 'fringe';
- iv. **pruning new tree plantings further in from the boundary where lower branches may block significant views.**

Reason: Remaining or recoverable views to and from Heathcote Hall, its remnant and recreated drive, paths, pleasure gardens have higher cultural heritage value relative to that of the site's natural heritage value and should be favoured over the latter. Additional detail has been provided which appears to control shrub height to retain/ reinstate views, however further assessment of the information is required at s60 stage, in conjunction with detailing of the pleasure garden, to ensure appropriate landscaping.

b) Detailed **revised** information on the proposed design of the pleasure garden based on further site investigation **addressing the following:**

- i. **Drawings LAH-05 and LAH-06, submitted with this Section 4.55 application, require further revision to specify existing , as well as new, plantings - i.e. picking these out in differing colours, to clarify both.**
- ii. **Drawings LAH-05 and LAH-06, submitted with this Section 4.55 application, require further revision to specify reinstated plantings, where previously lost, in the planting scheme .**
- iii. **Strategies to tend, maintain and replant propagated, lost plant material, back in the garden, stake, water, tend and monitor successful establishment of new and reinstated plantings, into the future.**
- iv. **Preparation and submission of detailed future management and maintenance strategies including a Garden Maintenance Strategy (GMS) and Grounds Maintenance Plan (GMP), to prune and manage existing and new plantings, going forward. These strategies must be informed by CMP policies as included in Attachment A.**

Reason: To enable investigation of the historical garden and appropriate conservation and reconstruction of this significant garden setting. Drawings LAH-5 and LAH-06 require further revisions to remove all proposed Buxus (box) hedging, lining driveway, paths and garden bed edgings as there is no precedent on this site for box hedging. The submission does not meet the requirements of the CMP policies as included in Attachment A.

c) ~~Amended plans showing the detail and location of all fences.~~

~~Reason: Insufficient information has been provided to enable a thorough impact assessment of this element. The location of the 1200mm picket fence appears at odds with the existing landscape plan, crossing paths at unusual angles. The location of this fence is to be carefully reconsidered in light of the future investigations which are required to aid the detailed design of the pleasure garden.~~

- d) The landscape plans prepared by Tropman and Tropman Architects titled Proposed Buffer Zone Planting plans (L100 – L106, dated 9 April 2019) are not approved. The Buffer Zone Planting Report is approved in principle and is to be considered and incorporated where relevant in the development of the detailed design of the pleasure garden, planting plans, and fencing. ~~The stairs proposed in the 'Old Carriageway Interpretation' are to be removed and the path graded to accommodate the change in levels.~~

~~Reason: The Buffer Zone Planting Report provides an appropriate means of mitigating the potential adverse impacts on the setting of Heathcote Hall of private open space encroachment into the buffer zone. The approach detailed in the report should be integrated into the detailed design of the pleasure garden. The associated plans are generally supported but are not approved as they encroach into the pleasure garden and do not reflect the detailed investigation required for the final design. The stairs in the interpreted drive within the buffer zone would impede the interpretive potential of this element.~~

- e) Internal and external paint scrapes are to be taken at Heathcote Hall to determine the early decoration schemes. New paint schemes are to be based on the findings of this investigation.

Reason: No detailed information on the internal or external paint scheme for Heathcote Hall has been provided to enable a thorough heritage impact assessment. To ensure compliance with CMP policy 5.2.27.

- f) Amended plans and supporting documentation showing inconsistencies have been rectified. The duplication in numbering of building spaces on the ground floor of Heathcote Hall and ancillary structures is to be removed; ancillary structures are to be renumbered from A1 to C1, etc.

Reason: To ensure there is no confusion over proposed works.

- g) Detailed information addressing fire protection of the historic elements of the place.

Reason: No provision for fire protection of the historic dwelling, associated landscaped setting and elements has been indicated. Considering the local bushfire threat, and the significance of the place, means to address this issue should be installed.

DESIGN MODIFICATIONS

7. Repainting of the stair dado (A6) is not approved. Preservation of this significant decoration is required.

Reason: Repaint of this element is contrary to CMP policy 5.2.28. Preservation is preferred and must be investigated.

8. Replacement light fittings in Heathcote Hall are to be appropriate to the character of Heathcote Hall and approved by the nominated heritage consultant.

Reason: To ensure replacement fittings are sympathetic to the aesthetic significance of the place.

9. Ancillary structure A5 (WC) is to be retained and conserved.

Reason: This structure is identified as being of exceptional-high significance in the CMP and should be conserved.

10. **The Waste Pick-Up area at the Dillwynia Grove vehicle entry is not approved. Amended plans shall be submitted with the section 60 application for approval.**

Reason: To minimise impact on significant sloping embankment in this part of the site and to be consistent with the CMP policies.

11. **The new sub-station structure and fencing at the Dillwynia Grove vehicle entry is to be screened by appropriate new planting. The landscape plan shall be amended to include the new plantings and submitted with the section 60 application for approval.**

Reason: To minimise impact on significant sloping embankment in this part of the site and to be consistent with the CMP policies.

HISTORICAL ARCHAEOLOGY

12. The applicant shall submit an Archaeological Research Design and Excavation Methodology undertaken by a suitably qualified and experienced historical archaeologist as part of the section 60 application.

Reason: To appropriately manage archaeological resources on the site.

13. The name of a nominated excavation director suitable to satisfy the Excavation Director Criteria of the Heritage Council of NSW for the proposed activity and significance level is submitted with the section 60 application.

Reason: To ensure that archaeological excavation at the site is managed by a suitably qualified excavation director.

14. Following the receipt of the Archaeological Research Design and Excavation Methodology as part of the section 60 application, the Heritage Council of NSW reserves the right to issue Archaeological Conditions as part of the section 60 approval to manage the archaeology. Matters such as (but not limited to) fieldwork methodology, artefact analysis, and final reporting may be included as part of these archaeological conditions.

Reason: To ensure that archaeological resources are managed in accordance with the approved research design and methodology.

15. This archaeological approval does not cover the removal of any State significant relics. This approval covers the archaeological monitoring of works which may disturb or expose relics. Only relics of local heritage significance can be removed.

Reason: To ensure that locally significant relics are appropriately managed, and State significant relics are not removed.

UNEXPECTED HISTORICAL ARCHAEOLOGICAL RELICS

16. The applicant must ensure that if unexpected archaeological deposits or relics not identified and considered in the supporting documents for this approval are discovered, work must cease in the affected area(s) and the Heritage Council of NSW must be notified. Additional assessment and approval may be required prior to works continuing in the affected area(s) based on the nature of the discovery.

Reason: This is a standard condition to identify to the Applicant how to proceed if unexpected historical archaeological relics are discovered on site.

ABORIGINAL OBJECTS

17. Should any Aboriginal 'objects' be uncovered by the work, excavation or disturbance of the area is to stop immediately and the Office of Environment & Heritage is to be informed in accordance with Section 89A of the National Parks and Wildlife Act, 1974 (as amended). Works affecting Aboriginal 'objects' on the site must not continue until the Office of Environment and Heritage has been informed. Aboriginal 'objects' must be managed in accordance with the National Parks and Wildlife Act, 1974.

Reason: This is a standard condition to identify to the Applicant how to proceed if Aboriginal objects are unexpectedly identified during works.

HERITAGE CONSULTANT

18. A suitably qualified and experienced heritage consultant must be nominated for this project. The nominated heritage consultant must provide input into the detailed design, provide heritage information to be imparted to all tradespeople during site inductions, and oversee the works to minimise impacts to heritage values. The nominated heritage consultant must be involved in the selection of appropriate tradespersons and must be satisfied that all work has been carried out in accordance with the conditions of this consent.

Reason: So that appropriate heritage advice is provided to support best practice conservation and ensure works are undertaken in accordance with this approval.

HERITAGE INTERPRETATION STRATEGY

19. An interpretation plan must be prepared in accordance with the NSW Heritage Division publication Interpreting Heritage Places and Items Guidelines and submitted for approval to the Heritage Council of NSW (or delegate) prior to the issue of any Construction Certificate.
20. The interpretation plan must detail how information on the history and significance of name of item will be provided for the public, and make recommendations regarding public accessibility, signage and lighting. The plan must identify the types, locations, materials, colours, dimensions, fixings and text of interpretive devices that will be installed as part of this project.
21. The approved interpretation plan must be implemented prior to the issue of an occupation certificate for any residential development within the curtilage of Heathcote Hall.

Reason: Whilst interpretation is generally encouraged, the proposal should be informed by an interpretation strategy to ensure that interpretation is cohesive and appropriate to convey the significance of the site. Interpretation is an important part of every proposal for works at heritage places.

SITE PROTECTION

22. Significant built and landscape elements are to be protected during site preparation and the works from potential damage. Protection systems must ensure significant fabric, including landscape elements, is not damaged or removed.

Reason: To ensure significant fabric including vegetation is protected during construction.

PHOTOGRAPHIC ARCHIVAL RECORDING

23. A photographic archival recording of Heathcote Hall (including built and landscape elements and the setting) must be prepared prior to the commencement of works. This recording must be in accordance with the NSW Heritage Division publication Photographic Recording of Heritage Items using Film or Digital Capture (2006). The digital copy of the archival record must be provided to the Heritage Division, Office of Environment and Heritage.

Reason: To capture the condition and appearance of the place prior to modification of the site which impacts significant fabric.

COMPLIANCE

24. If requested, the applicant and any nominated heritage consultant may be required to participate in audits of Heritage Council of NSW approvals to confirm compliance with conditions of consent.

Reason: To ensure that the proposed works are completed as approved.

SECTION 60 APPLICATION

25. An application under section 60 of the Heritage Act 1977 must be submitted to, and approved by, the Heritage Council of NSW (or delegate) prior to work commencing.

Reason: To meet legislative requirements.

ADVICE

Section 148 of the *Heritage Act 1977* (the *Act*), allows people authorised by the Minister to enter and inspect, for the purposes of the Act, with respect to buildings, works, relics, moveable objects, places or items that is or contains an item of environmental heritage. Reasonable notice must be given for the inspection.

If you have any questions regarding the above approval, please contact Shikha Jhaldiyal, Senior Heritage Assessments Officer at Heritage, Department of Premier and Cabinet, on 9873 8545 or shikha.jhaldiyal@environment.nsw.gov.au or Stuart Read, Senior Heritage Operations Officer, Metro South Team, on 9873 8554 or stuart.read@environment.nsw.gov.au

Yours sincerely



BARRINA SOUTH

Acting Regional Manager Southern
Heritage NSW, Department of Premier and Cabinet
As Delegate of the Heritage Council of NSW

Date: 25 August 2021

ATTACHMENT A

Conservation Management Plan Policies

- **5.2.5 Cyclical maintenance schedule for the grounds**
- **5.2.6 Cyclical maintenance plan for the grounds and garden**
- **5.2.10 Recording existing layout and key elements prior to works and change**
- **5.2.12 conservation treatment of elements ranked exceptional and high (e.g. path system around house)**
- **5.2.13 garden and landscape conservation according to ranking levels**
- **5.3.1 conservation treatment of garden elements according to ranking levels**
- **5.3.4 conservation of layout and fabric ranked high (including drives, garden bed layout), not adaptation**
- **5.3.12 conservation of external layout and original features (not adaptation).**
- **5.3.13 & 14 detailed survey & archaeological testing of original carriage drive.**
- **5.3.16 no new introduction of additional layout in immediate vicinity of the house.**
- **5.3.23 (encouraging Kitchen Garden reinstatement, specifying that cuttings taken will be replanted, show where on plan(s), and when this will be done.)**
- **5.3.24 (reinstating lost plantings with precedent on site, or surviving, ailing ones, specifying how, when, and by whom, propagation, planting, reinstatement, training, maintenance and monitoring of lost, 'to-be-reinstated' plantings will occur)**
- **5.3.25-27 original garden and drive edge glazed tiles – careful reinstatement work.**
- **5.3.31 (no hedges behind picket or other perimeter fences, control of height of existing hedging plants (*Tecomaria capensis*) to maintain views)**
- **5.3.33 (propagation and planned succession planting plans for identified older indigenous forest trees in a state of decline or needing removal)**
- **5.3.35 (a-h) (training of all grounds maintenance staff by a qualified, experienced horticulturist with experience in historic gardens, actions to specified plantings on site, propagation of *Camellia* cultivars and all significant and contributory plants on or off site before they age and die, care for sloping lawn to southwest of house, good horticultural maintenance practices. All planting plans must be reviewed and revised to specify (and on-site, label) existing, as well as new, plantings – picking these out in differing colours. And specify training, maintenance and monitoring of all plantings, including new ones, i.e. how, when, and by whom, propagation, planting, reinstatement, training, maintenance and monitoring of lost plantings will occur. All planting plans must also include,**

labelled, all existing garden plants, picked out in a different colour. Also specifying training, maintenance and monitoring of all plantings, including new ones at this time)5.3.38 (specifying where and when cuttings taken of plants on site will be planted)

- *5.3.37 (specifying propagation of Pinus radiata from seed, not cuttings)*
- *5.3.38 (specifying where and when cuttings taken of plants on site will be planted)*
- *5.3.39 (demonstrating what, where, when in terms of staged succession planting)*
- *5.3.40 (retention and pruning of more rampant species, maintenance of views)*
- *5.3.41 (specifying tree protection measures during construction, and ongoing maintenance and monitoring of all trees of high or exceptional significance)*
- *5.3.42 (specifications in the Garden Maintenance Strategy to manage nuisance plant species, prevent spread beyond intended locations, including hedge pruning)*
- *5.3.43 (Grounds Maintenance Plan, 6-monthly inspections by a qualified, experienced horticulturist with heritage gardens, re weedy species management, hedge pruning)*
- *5.3.44 (Strata Executive body's management of herbicide spray application on site)*
- *5.3.45 (ensure an appropriate restoration/reconstruction scheme for the pleasure grounds consistent with physical and archival evidence on this site)*
- *5.3.46 (ensure Strata Executive body has appropriate maintenance and monitoring program including 6-monthly inspections, staged propagation, replanting, planting and bolstering of significant and contributory plantings on site, pruning, etc)*
- *5.3.47 (ensure Strata Executive body monitors health and condition of all significant and contributory plants on site every 6 months, based on inspection and recommendations of grounds staff)*
- *5.3.48 (Strata Executive body makes annual reports on progress of garden and plantings to the Heritage Council of NSW, copies to Sutherland Shire Council)*
- *5.3.52 (further investigation of garden shed east of house, possible early coach house, proposed works, repairs and ongoing use).*



NSW RURAL FIRE SERVICE

Sutherland Shire Council
Locked Bag 17
SUTHERLAND NSW 1499

Your reference: MA21/0051 (CNR-19233)
Our reference: DA-2017-05012-S4.55-1

ATTENTION: Sutherland Shire Council

Date: Monday 7 June 2021

Dear Sir/Madam,

Development Application

s100B – Subdivision – Strata Title Subdivision

1-21 Dillwynnia Grove Heathcote NSW 2233, 2//DP725184, 1//DP725184

I refer to your correspondence regarding the above proposal which was received by the NSW Rural Fire Service on 13/04/2021.

The NSW Rural Fire Service (NSW RFS) has reviewed the amended information provided in relation to the above subdivision development in accordance with the *Environmental Planning and Assessment Act 1979* and raises no objections subject to original conditions dated 27 April 2018.

For any queries regarding this correspondence, please contact Rohini Belapurkar on 1300 NSW RFS.

Yours sincerely,

Kalpana Varghese
**Supervisor Development Assessment & Plan
Built & Natural Environment**

Postal address

NSW Rural Fire Service
Locked Bag 17
GRANVILLE NSW 2142

Street address

NSW Rural Fire Service
4 Murray Rose Ave
SYDNEY OLYMPIC PARK NSW 2127

T (02) 8741 5555
F (02) 8741 5550
www.rfs.nsw.gov.au



HEATHCOTE GROUNDS

1-21 DILLWYNNIA GROVE, HEATHCOTE 2233 NSW

LIST OF S4.55 DRAWINGS		
SHEET NO.	SHEET NAME	Current Revision
MOD00	COVER SHEET	A
MOD01	SITE PLAN ROOF PLAN	A
MOD05	LOWER BASEMENT B2	A
MOD06	BASEMENT FLOOR PLAN - B1	A
MOD07	GROUND FLOOR PLAN	A
MOD08	FIRST FLOOR PLAN	A
MOD09	SECOND FLOOR PLAN	A
MOD10	EAST, NORTH, WEST & SOUTH ELEVATIONS	A
MOD11	SECTIONS A-A, B-B, C-C & D-D	A
MOD12	SECTIONS E-E, F-F, G-G & H-H	A
MOD13	SECTIONS I-I, J-J, K-K	A
MOD15	FSR CALCULATIONS	A
MOD16	ADAPTABLE TOWNHOUSE 7, 8, 11 & 12	A
MOD17	ADAPTABLE TOWNHOUSE 13, 14, 22 & APARTMENT B101, B103, B201, B203	A
MOD20	MATERIAL FINISHES BOARD	A

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HEATHCOTE GROUND PTY LTD

CLIENT

HEATHCOTE GROUNDS

1-21 Dillwynnia Grove,
Heathcote NSW 2233

COVER SHEET

DesignInc

DesignInc Sydney Pty Ltd
Level 12, 11 Pacific Highway
North Sydney NSW 2060 Australia
+61 2 9860 7100
sydney@designinc.com.au

DATE 15/01/2021
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PROJECT N°. DRAWING N°. REVISION


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BORONIA GROVE

TECOMA STREET

DILLWYNNIA GROVE



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HEATHCOTE GROUNDS

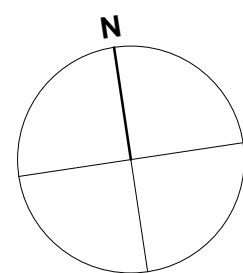1-21 Dillwynnia Grove,
Heathcote NSW 2233

SITE PLAN ROOF PLAN

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sydney@designinc.com.au

DATE 15/01/2021
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PROJECT N°

DRAWING N°

REVISION

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1) (as Amending 7200 1)
SHEET PLAN-DA

COC 3. DESIGN CHANGES iv(a)(d)(e)
TYPICAL FOR ALL ADAPTABLE TOWNHOUSES:
TOWNHOUSES NOMINATED AS ADAPTABLE TOWNHOUSES PROVIDED
WITH A PRIVATE LIFT, SUITABLE FOR WHEELCHAIR USAGE. LIFT
SERVICES BASEMENT 1, GROUND FLOOR AND FIRST FLOOR

GENERAL INTERNAL
PLANNING SOU UPDATED

OWNHOUSE 14 TO 17 LOWERED REDUCING BULK AND SCALE
OF DEVELOPMENT ON CORNER
LOWERING PROVIDES EQUITABLE DOA & BCA COMPLIANT
FRONT DOOR ACCESS PATH

WINDOWS REMOVED TO IMPROVE PRIVACY FOR TH-12 & TH-13

WINDOWS REMOVED TO IMPROVE PRIVACY FOR TH-16 & TH-17

BUILD FORM AND MASS
EGRESS STAIR 06 CONFIGURATION AMENDED

OC 3. DESIGN CHANGES v(b)
H 20 NOT ALLOCATED AS LIVABLE DWELLING AS
APPROPRIATE ACCESS CANNOT BE PROVIDED

LAYOUT UPDATED TO IMPROVE AMENITY WITH INCREASED DIRECT SOLAR LIGHT TO LIVING ROOM AND EQUITABLE ACCESS TO FRONT DOOR

OC 3. DESIGN CHANGES v(a)
TYPICAL FOR ALL LIVABLE TOWNHOUSES
OWNHOUSE DEDICATED AS LIVABLE TOWNHOUSE,
PROVIDED WITH A PRIVATE A LIFTSERVICING
ASSESSMENT , GROUND FLOOR AND FIRST FLOOR

TECOMA STREET

DILLWYNNIA GROVE

DesignInc

Designline Sydney Pty Ltd
Level 12, 77 Pacific Highway
North Sydney NSW 2060 Australia
+61 2 8905 7100
sydney@designline.com.au

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DISCUSSION

P20-056

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HEATHCOTE GROUNDS

1-21 Dillwynnia Grove,
Heathcote NSW 2233

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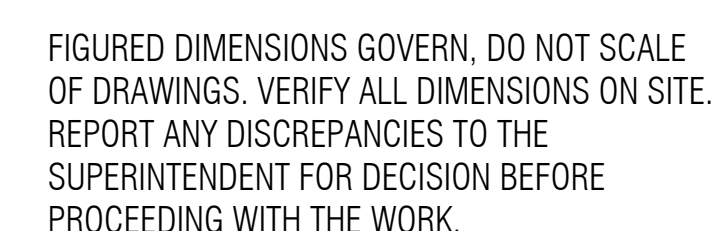
Nominated Architects
Sandep Engineering 7337 | Ian Armstrong 7260 | Richard Doss 8126 | Cathryn Drew Ercin 7269
| Mary Anne McGin 10946 |

GENERAL INTERNAL
PLANNING SOLI UPDATED

—TOWNHOUSE 14 TO 17 LOWERED REDUCING BULK AND SCALE OF DEVELOPMENT ON CORNER

— CARPARK EXHAUST RISER ADDED AND LIFT
RELOCATED WITH SMALLER AWNING TO PROVIDE LESS
BUILD FORM AND MASS

TECOMA STREET



CLIENT

1-21 Dillwynnia Grove,
Heathcote NSW 2233

DesignInc

DATE 15/01/2021
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MOD08

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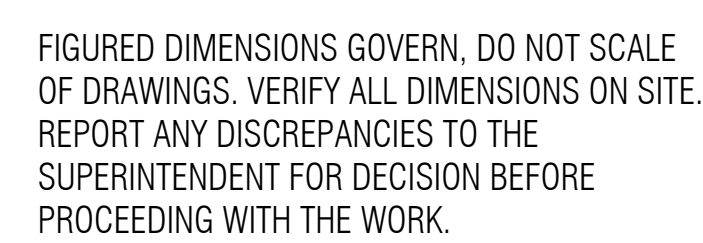
Noted Architects
Sardes Aircon /331 / Ian Armstrong 7266 / Richard Does 8126 / Cathryn Dew 6900 7269

Architectural site plan of a building complex. The plan includes various rooms, corridors, and outdoor areas. Key features include:

- Rooms:** A-301, A-302, B-301, B-302, and several smaller rooms and corridors.
- Outdoor Areas:** Multiple outdoor spaces with tables and chairs, including a large area labeled "OUTDOOR SEATING" and "OUTDOOR KITCHEN".
- Structural Elements:** A red dashed line outlines the main building footprint. A north arrow is located in the bottom right corner.
- Text:** "DILLWYNNIA GROVE" is written at the bottom of the page.

TECOMA STREET

DILLWYNNIA GROVE



CLIENT

1-21 Dillwynnia Grove,
Heathcote NSW 2233

DesignInc

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sydney@designinc.com.au

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Nominated Architects
 Sandeep Anil 7337 | Jan Armstrong 7206 | Richard Does 8126 | Catriey Dow Bredin 7206
 | Mary Ann Mc-Gee 10046 |



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PROCEEDING WITH THE WORK.

HEATHCOTE GROUND PTY LTD

CLIENT

HEATHCOTE GROUNDS

1-21 Dillwynnia Grove,
Heathcote NSW 2233


EAST, NORTH, WEST & SOUTH ELEVATIONS

DesignInc

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sales@designline.com.au

DATE 15/01/2021
SCALES 1 : 200 @A0

DRAWN	NU
CHECKED	LVE

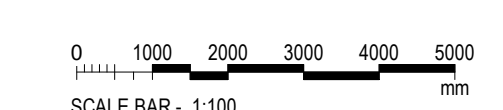PROJECT N^o.



DRAWING N°.

REVISION

P20-056

MOD10

A

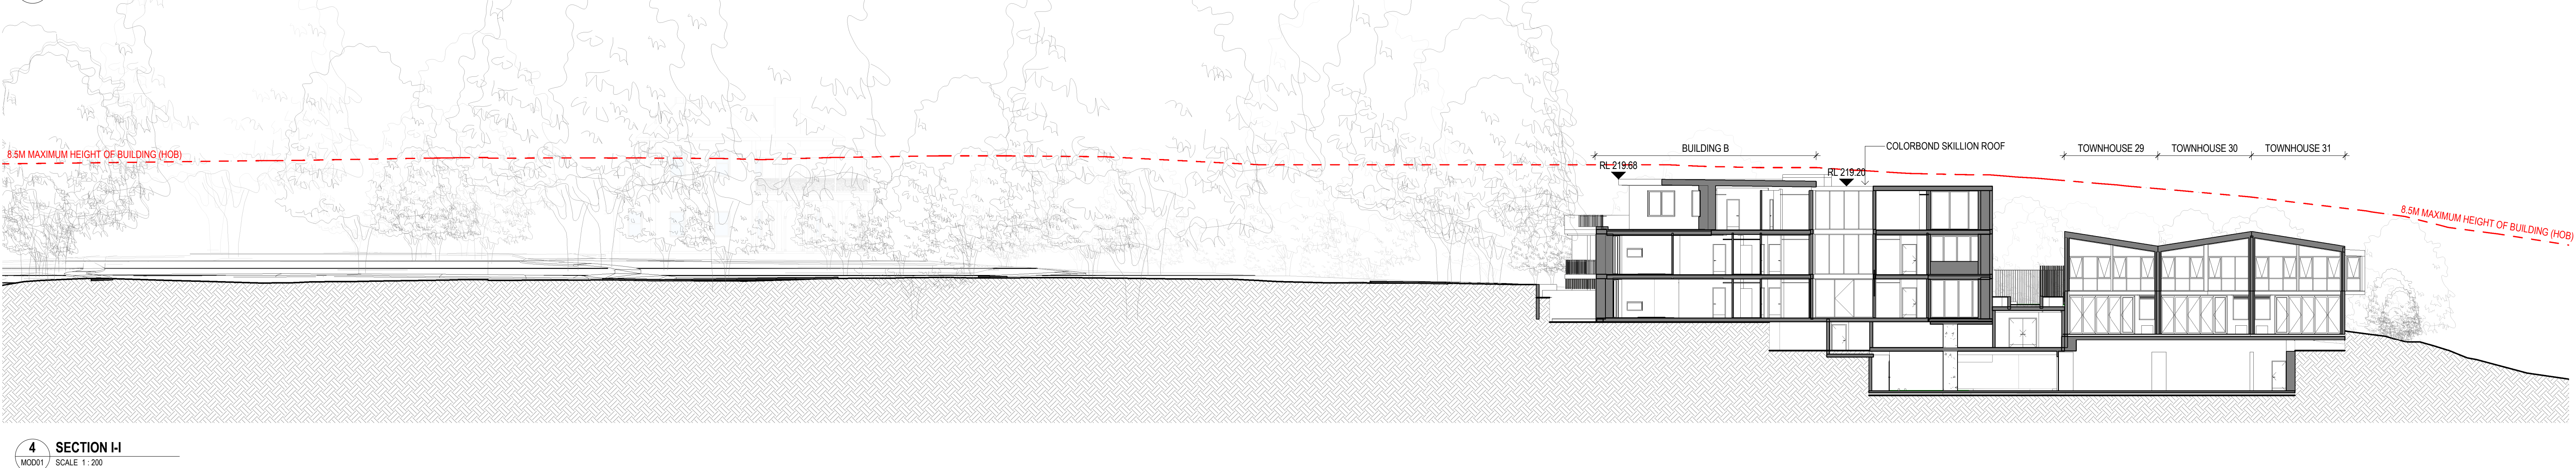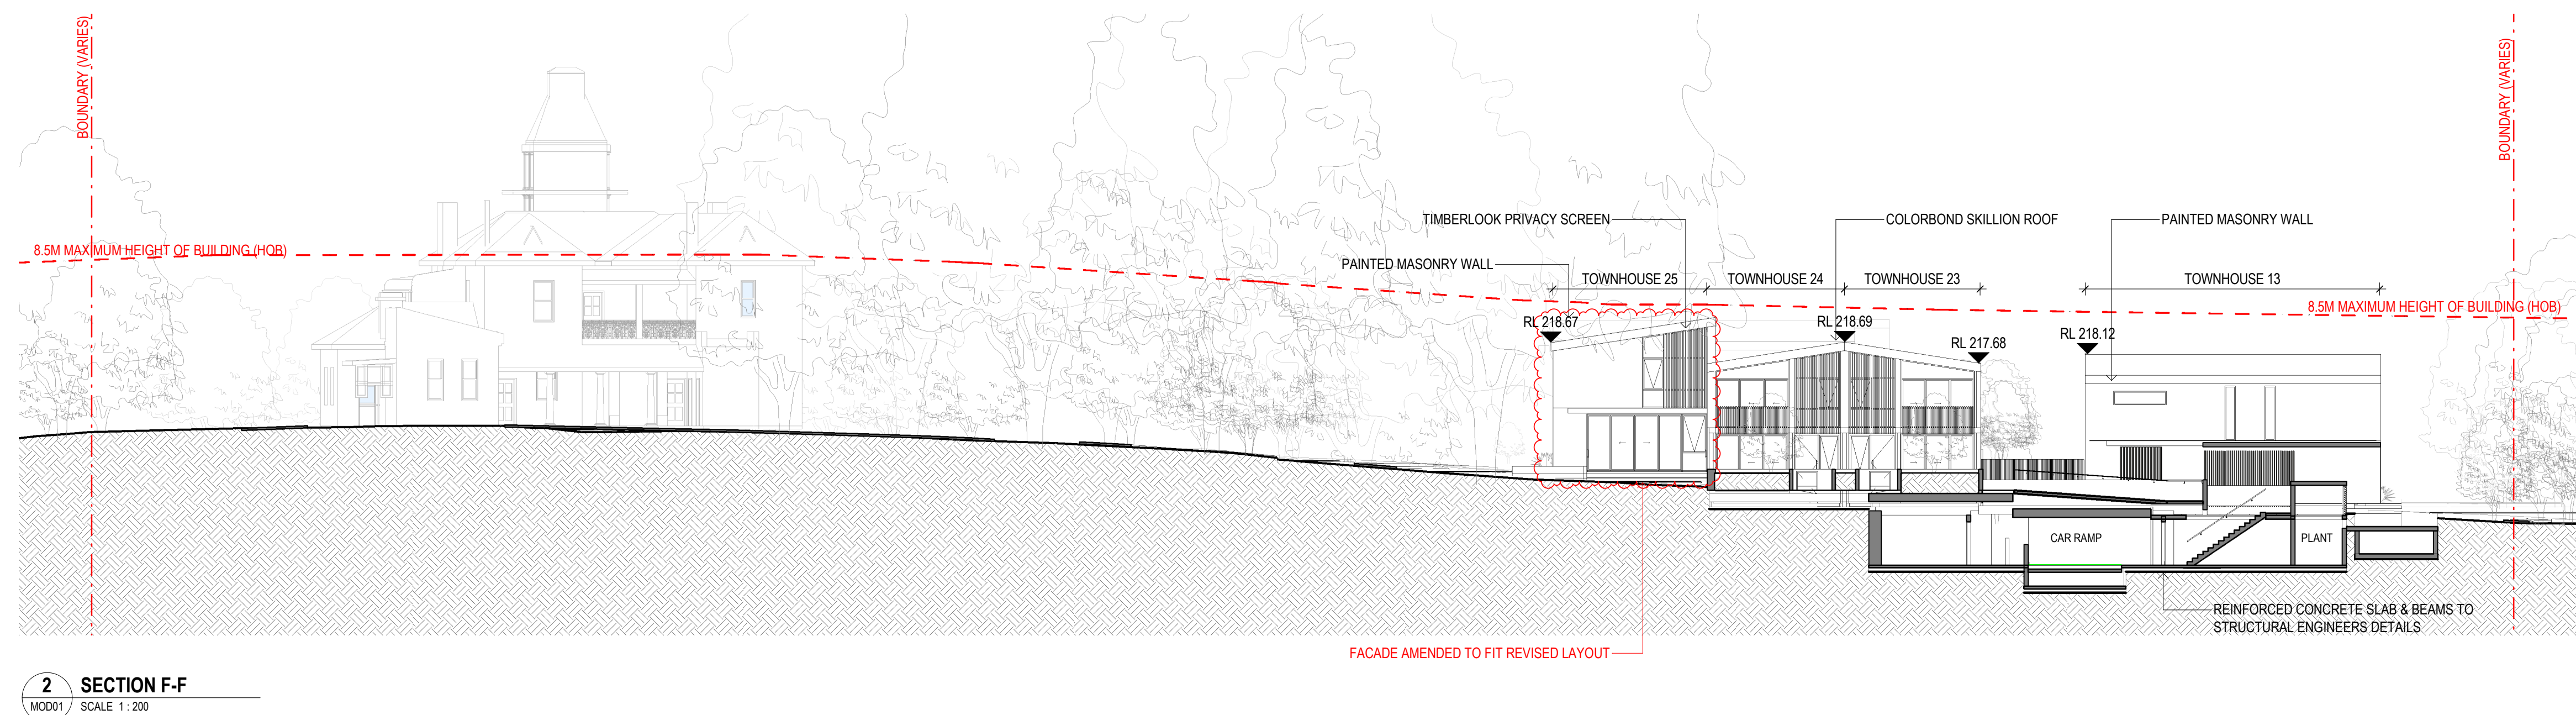

HEATHCOTE GROUNDS

1-21 Dillwynnia Grove,
Heathcote NSW 2233


DesignInc

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CHECKED	LVE




PROJECT N^o. _____ DRAWING N^o. _____ REVISION _____


P20-056	MOD12	A
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1 SECTION H-H
MOD1 SCALE 1:200

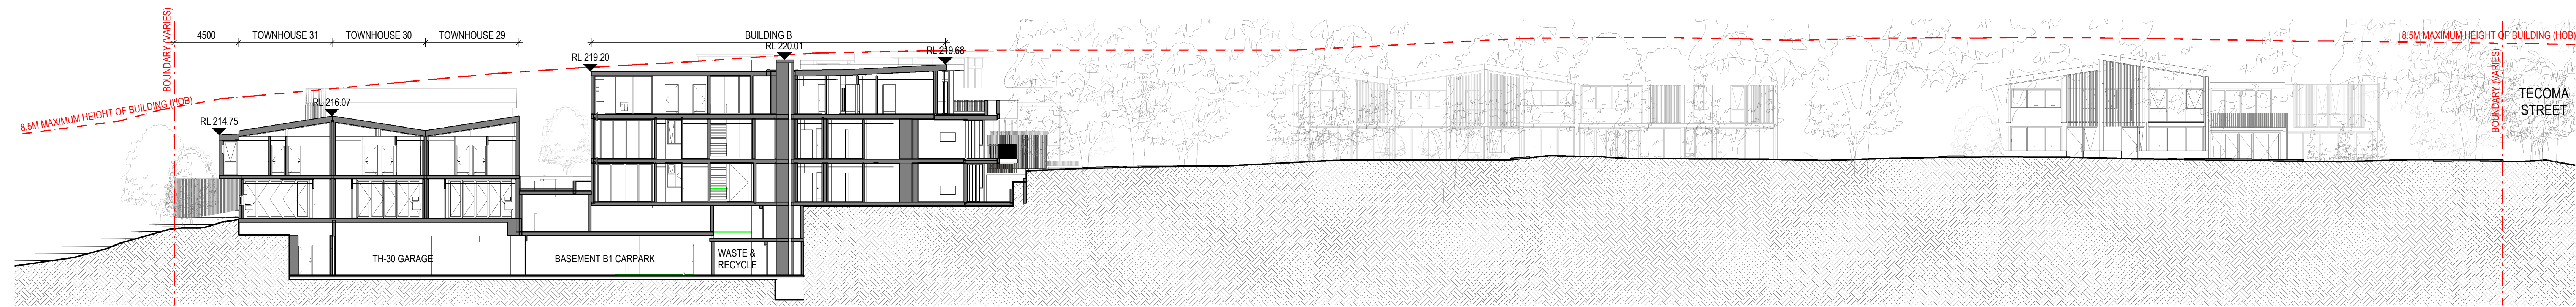

2 SECTION J-J
MOD1 SCALE 1:200

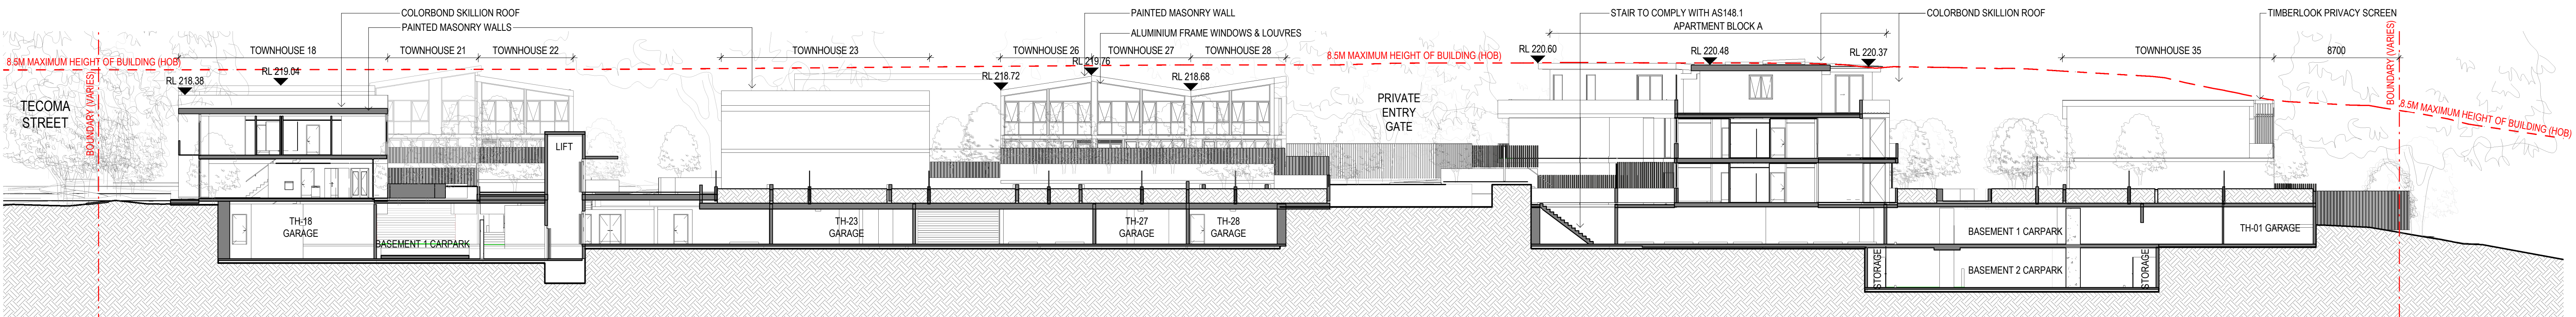

3 SECTION K-K
MOD1 SCALE 1:200

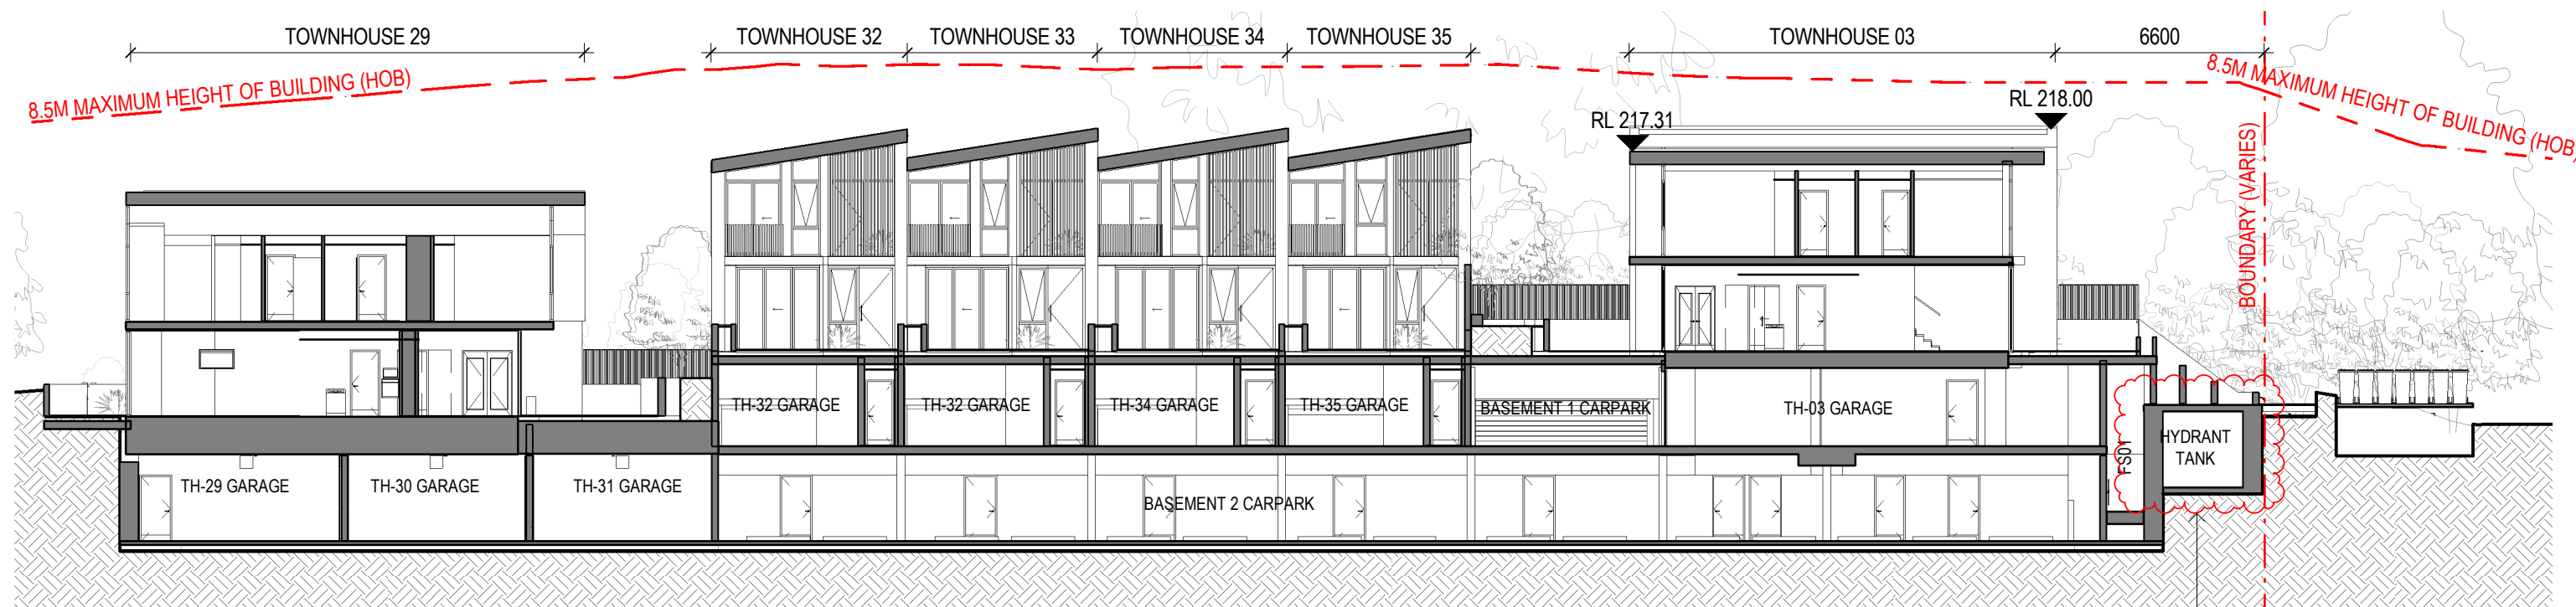HEATHCOTE GROUND PTY LTD

CLIENT

HEATHCOTE GROUNDS

1-21 Dillwynnia Grove,
Heathcote NSW 2233

SECTIONS H-H, J-J, K-K

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North Sydney NSW 2060 Australia
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sydney@designinc.com.au

DATE 15/01/2021
SCALES 1:200 @A0

DRAWN NU
CHECKED LVE

0 1000 2000 3000 4000 5000
SCALE BAR - 1:100

PROJECT N°


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REVISION


P20-056

MOD13

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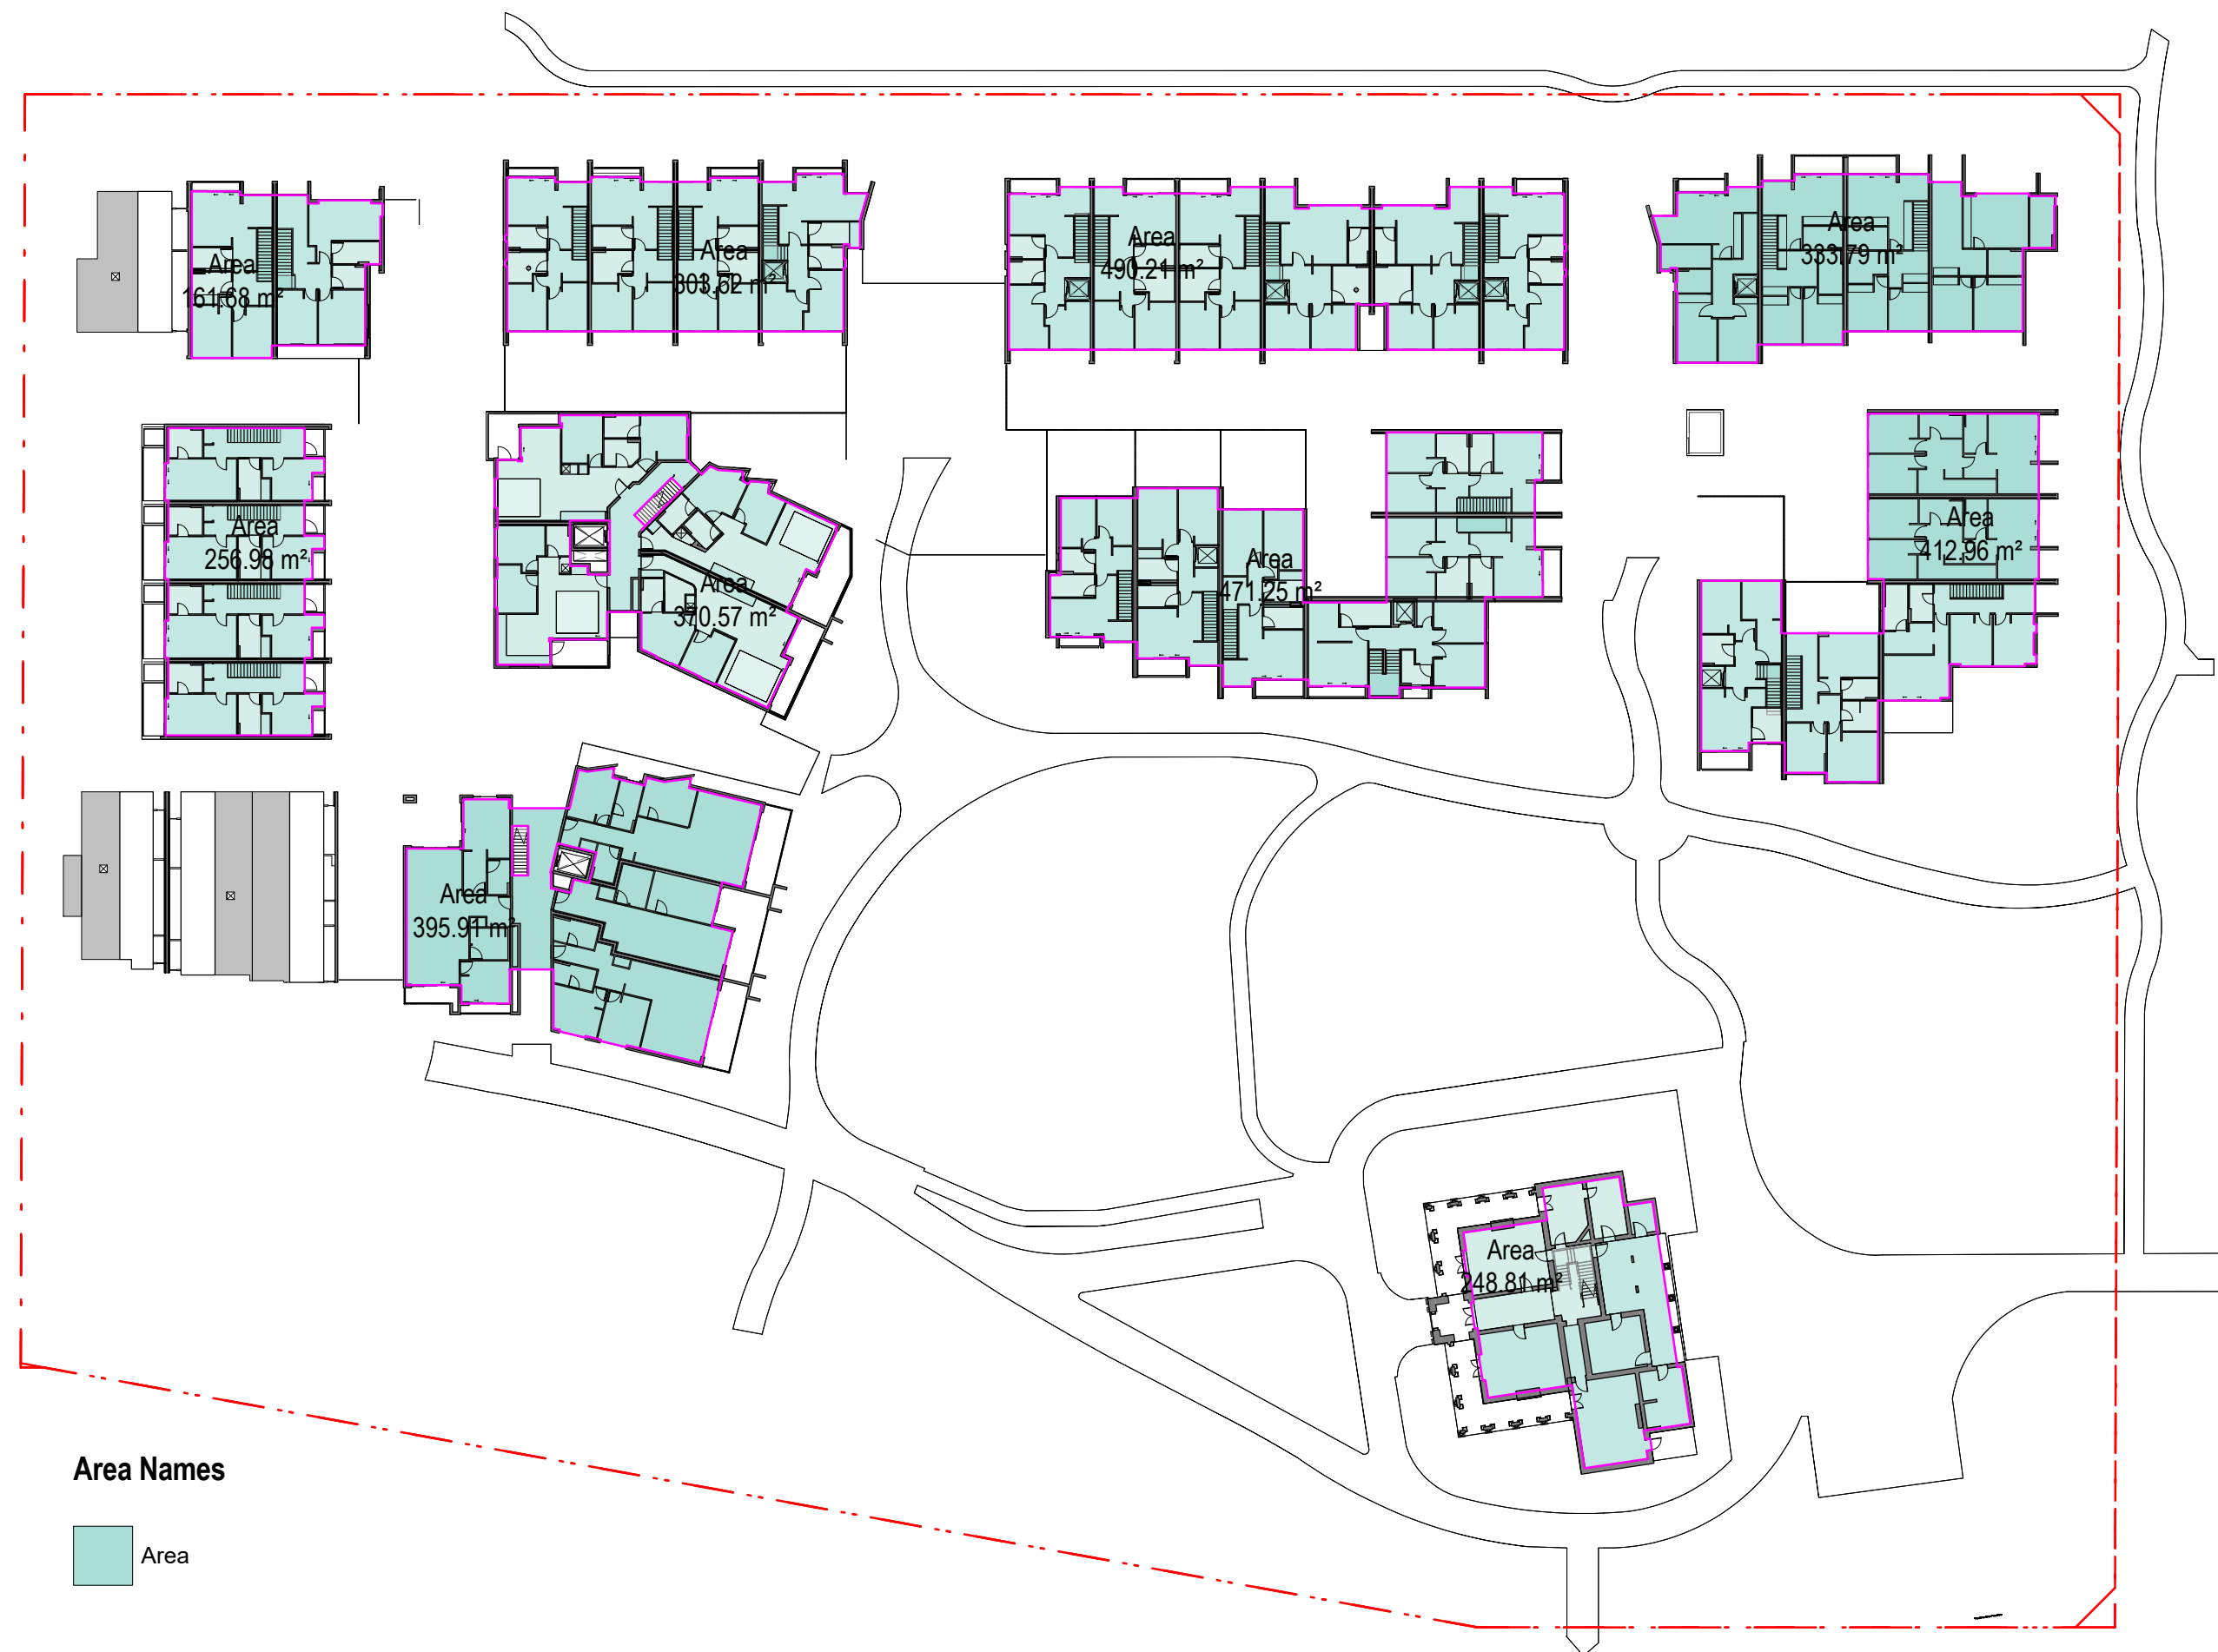
BASEMENT B2

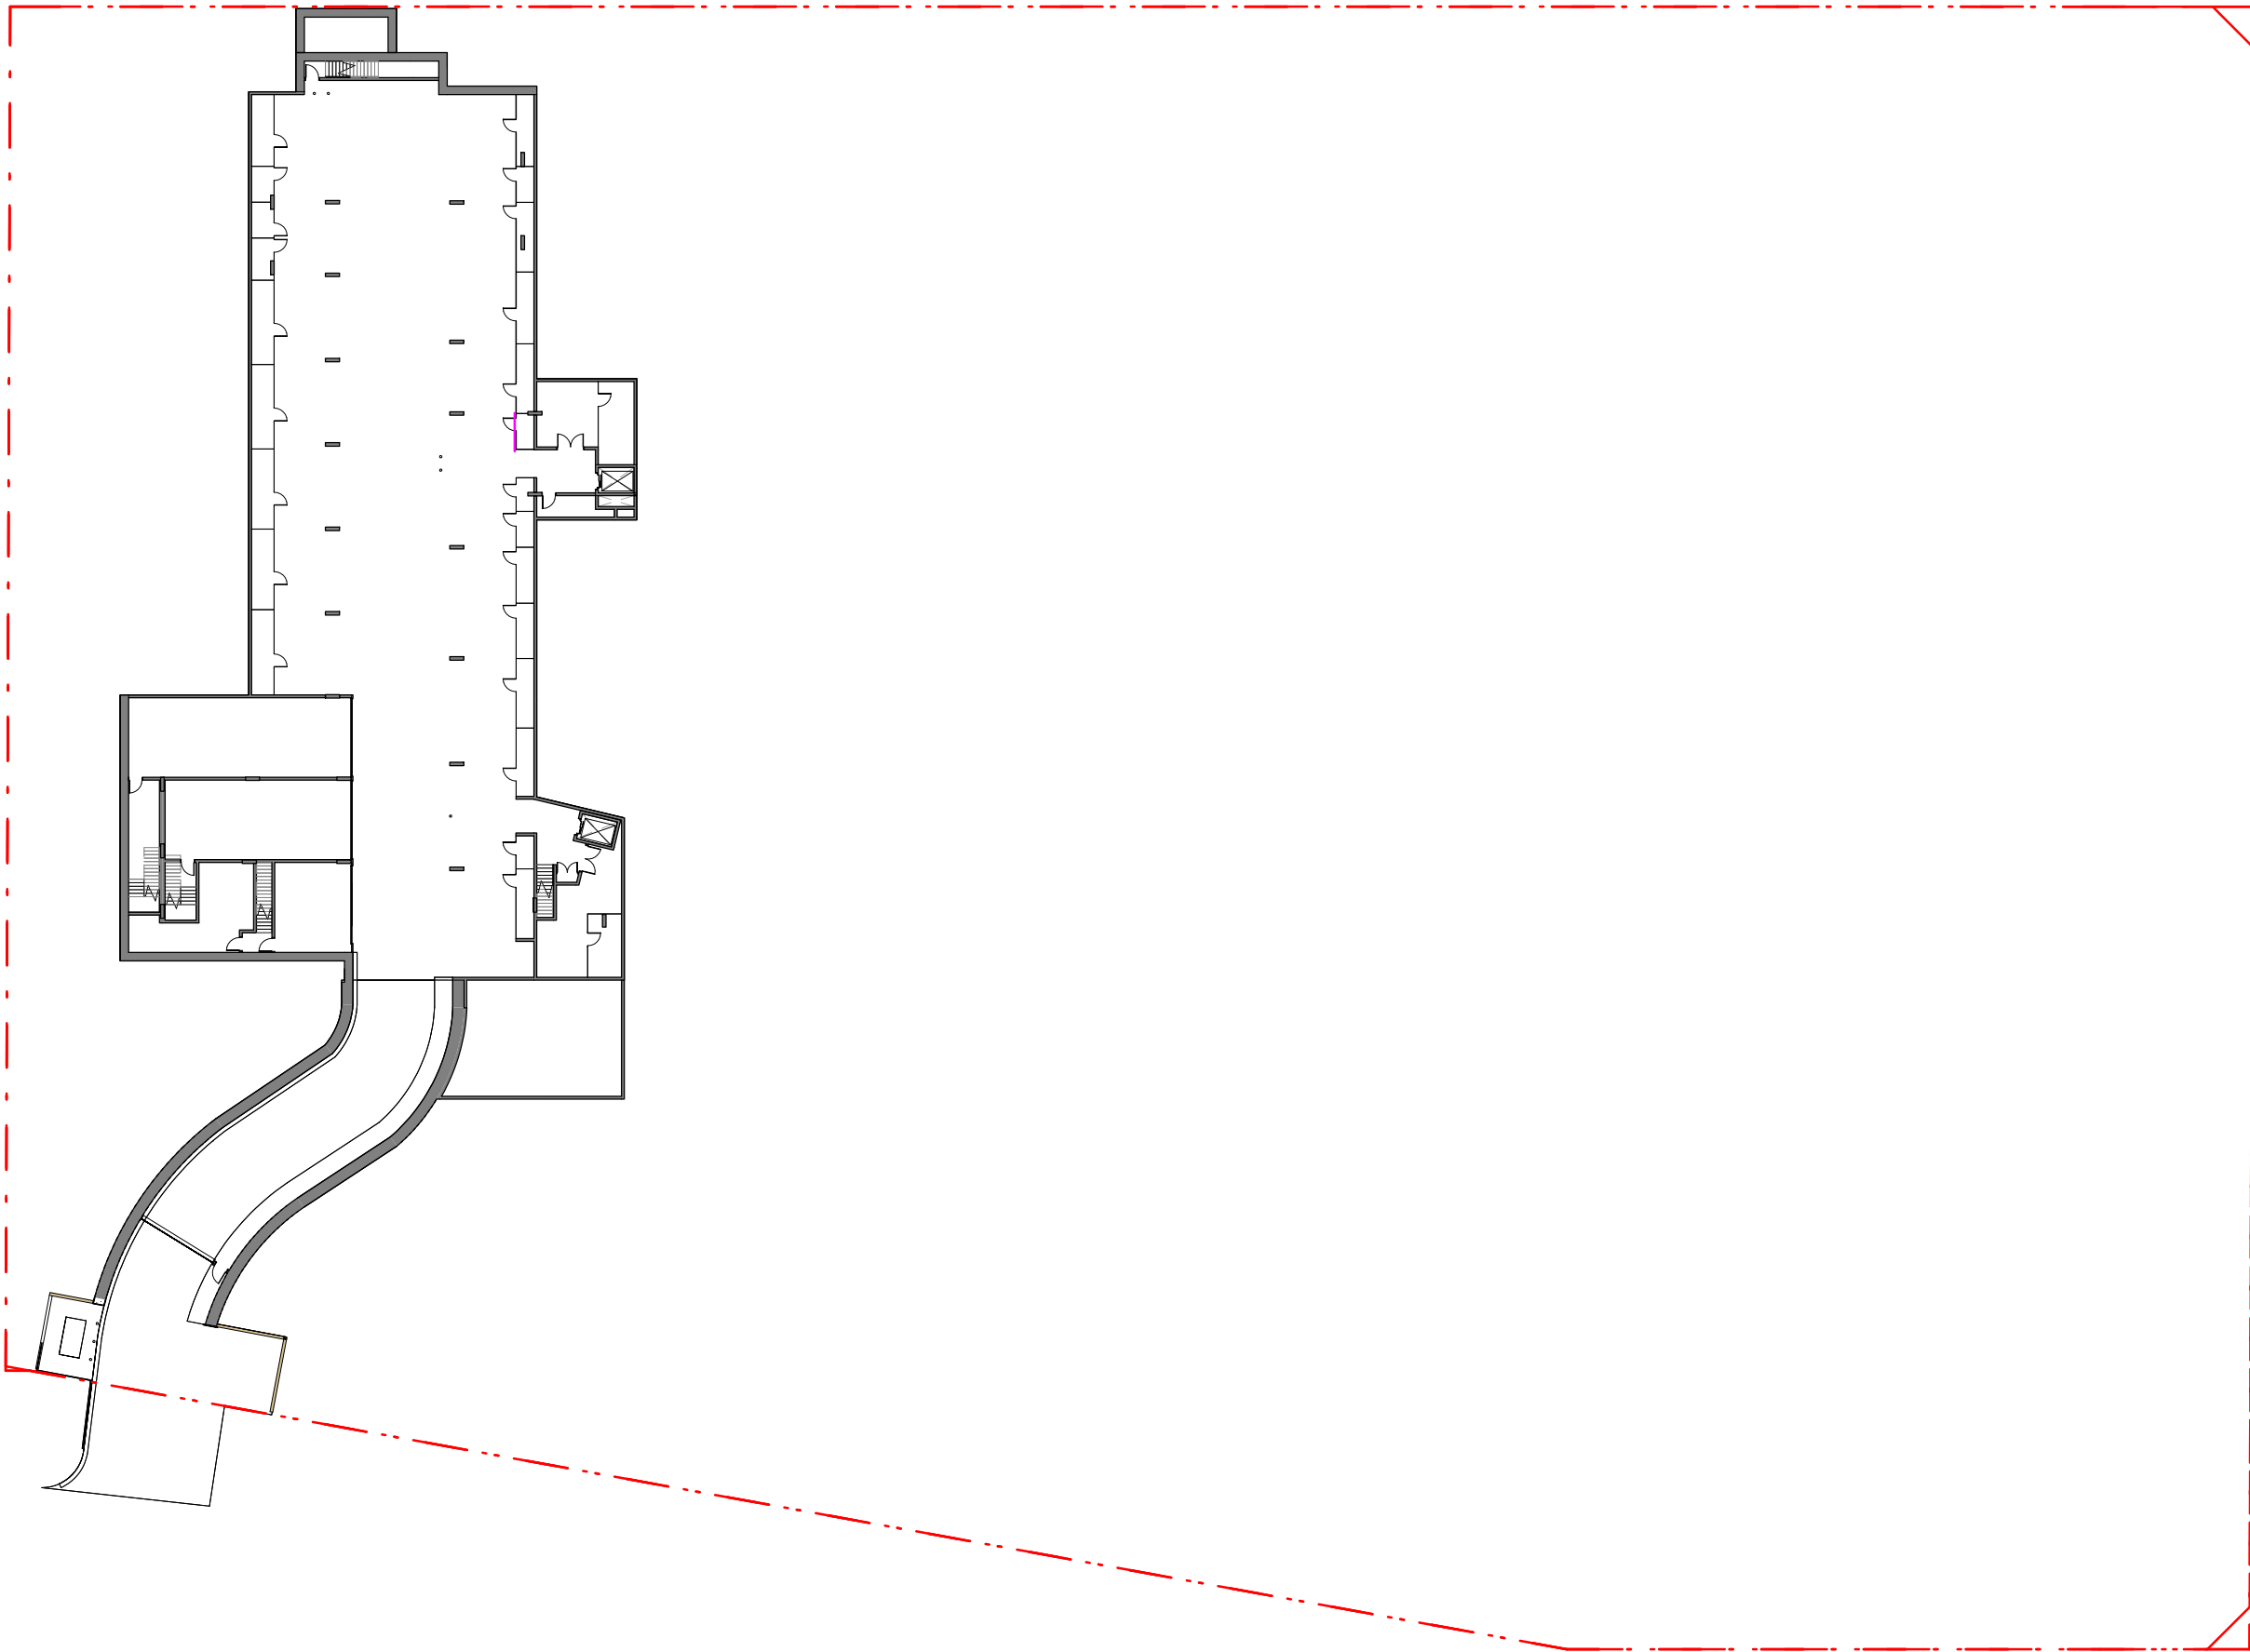


BASEMENT B1

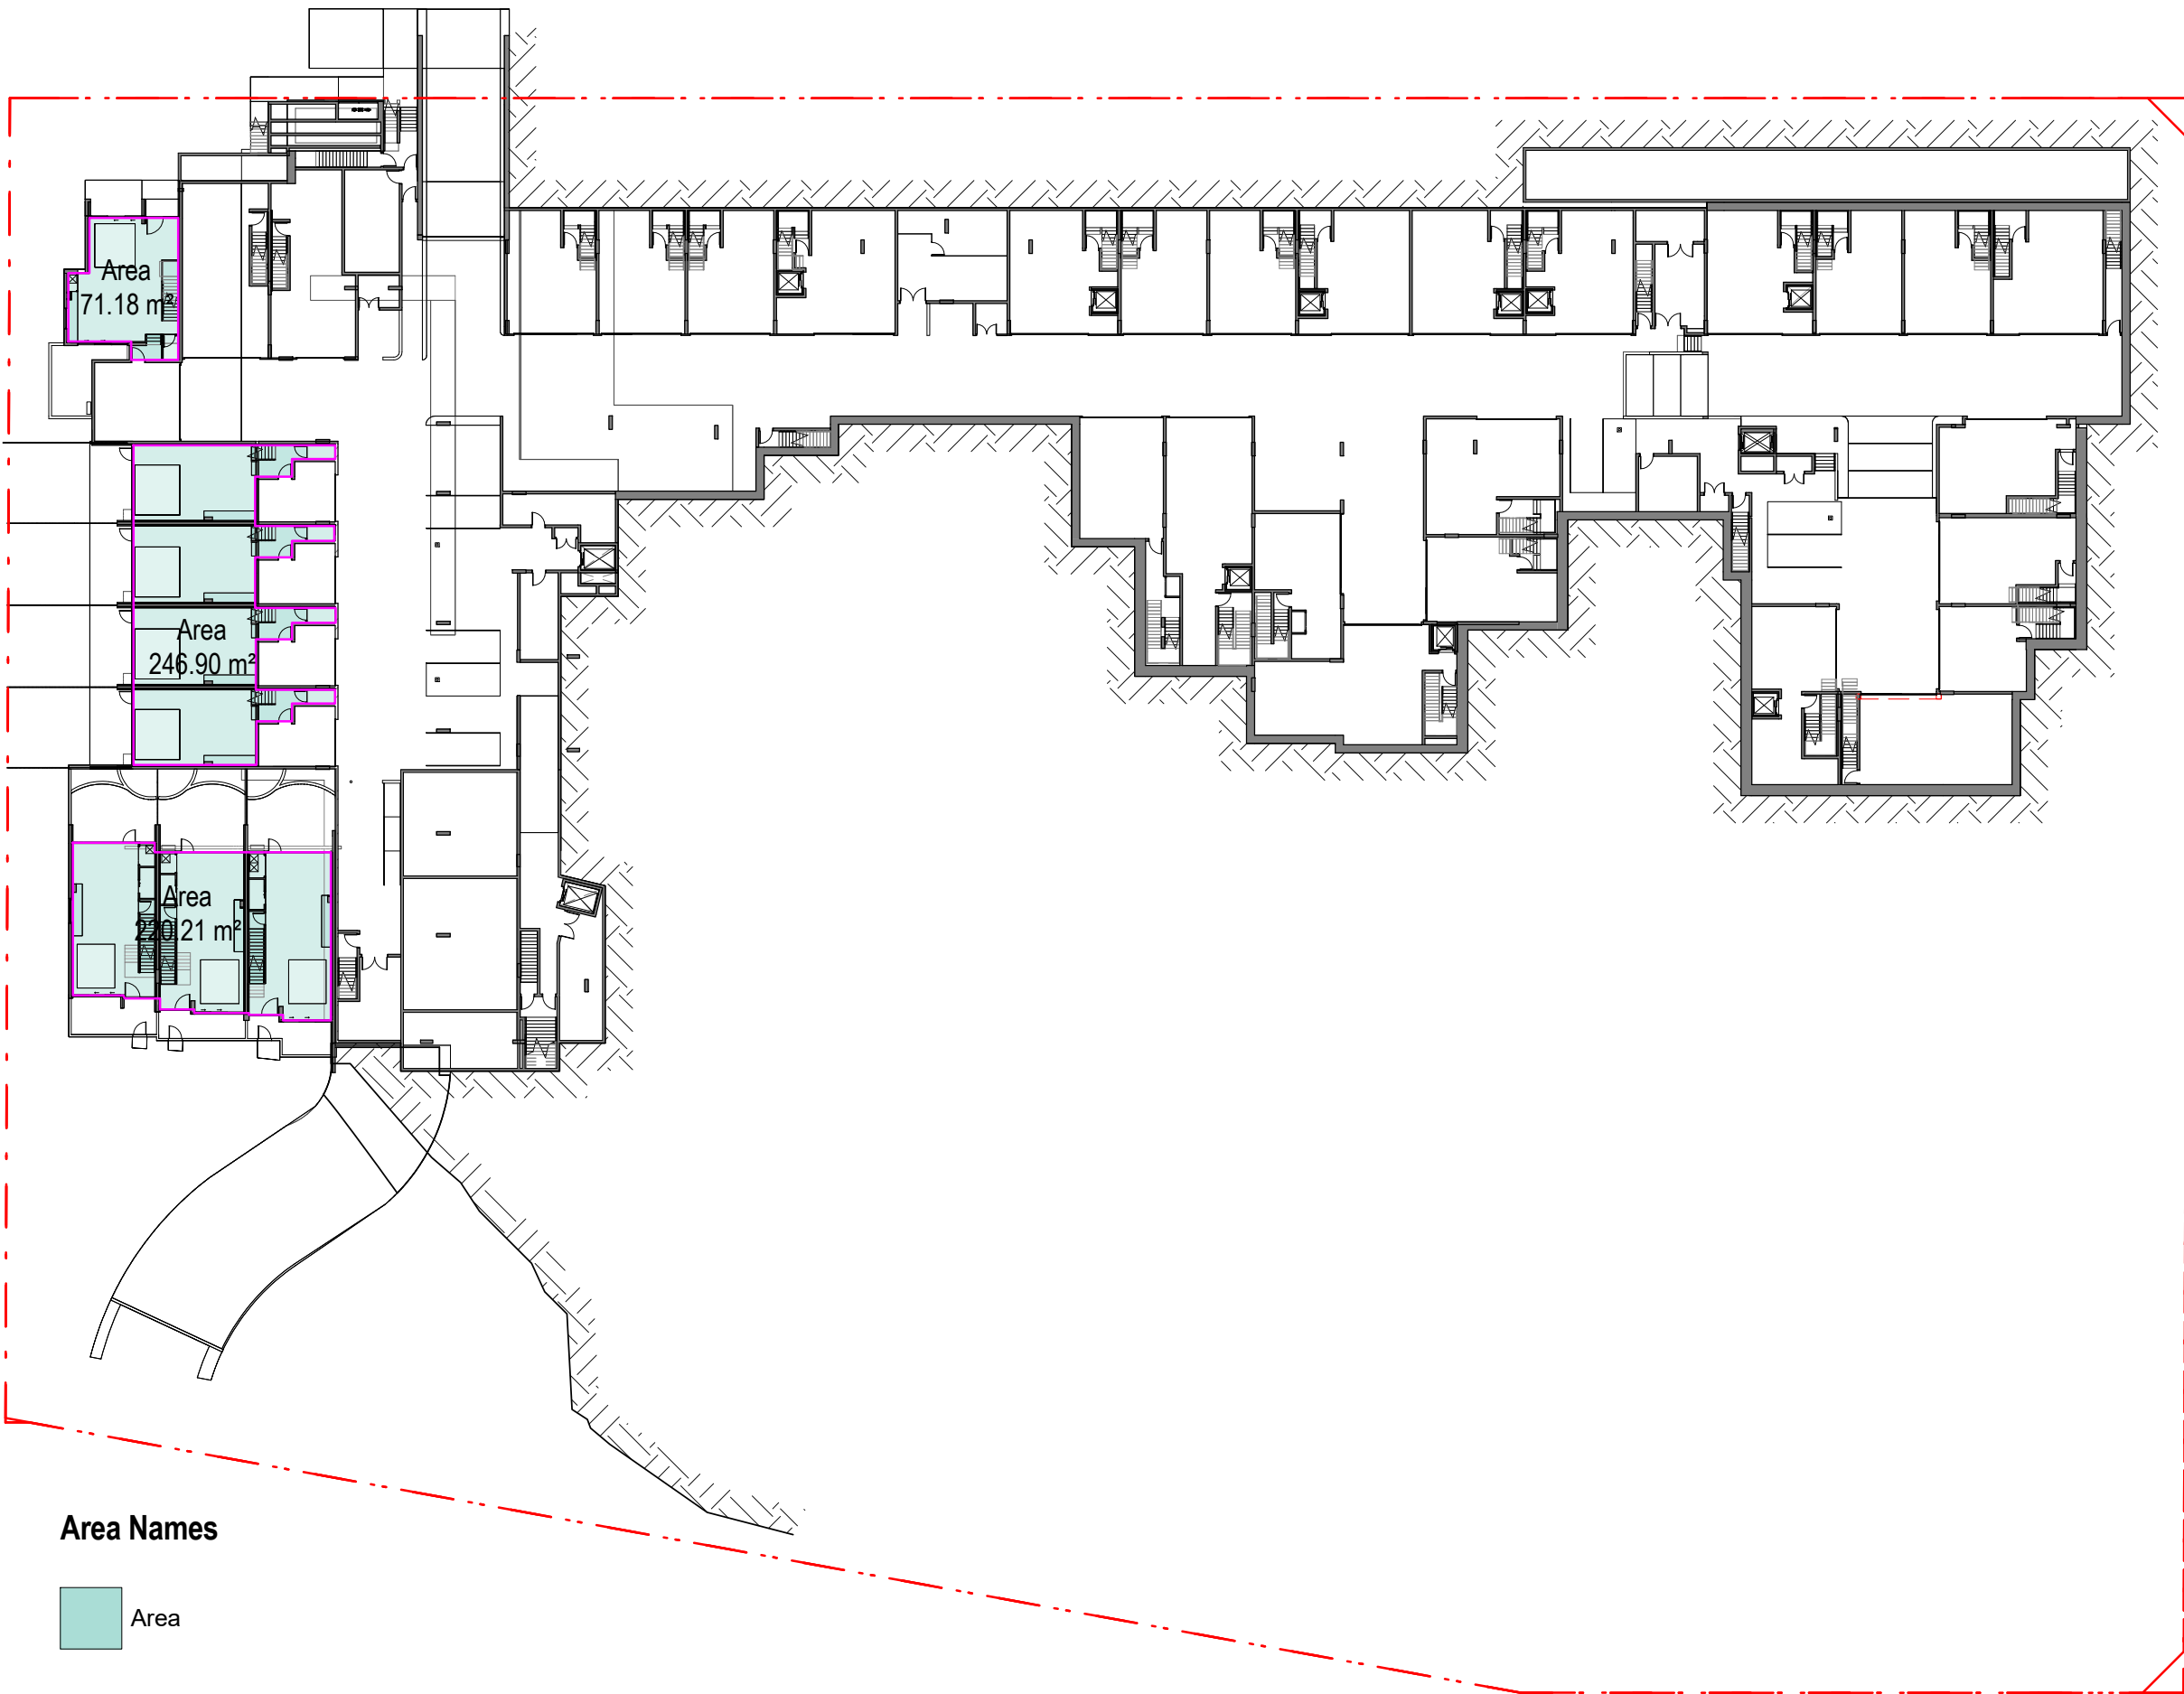

FSR-GFA_GROUND FLOOR



FSR-GFA_FIRST FLOOR

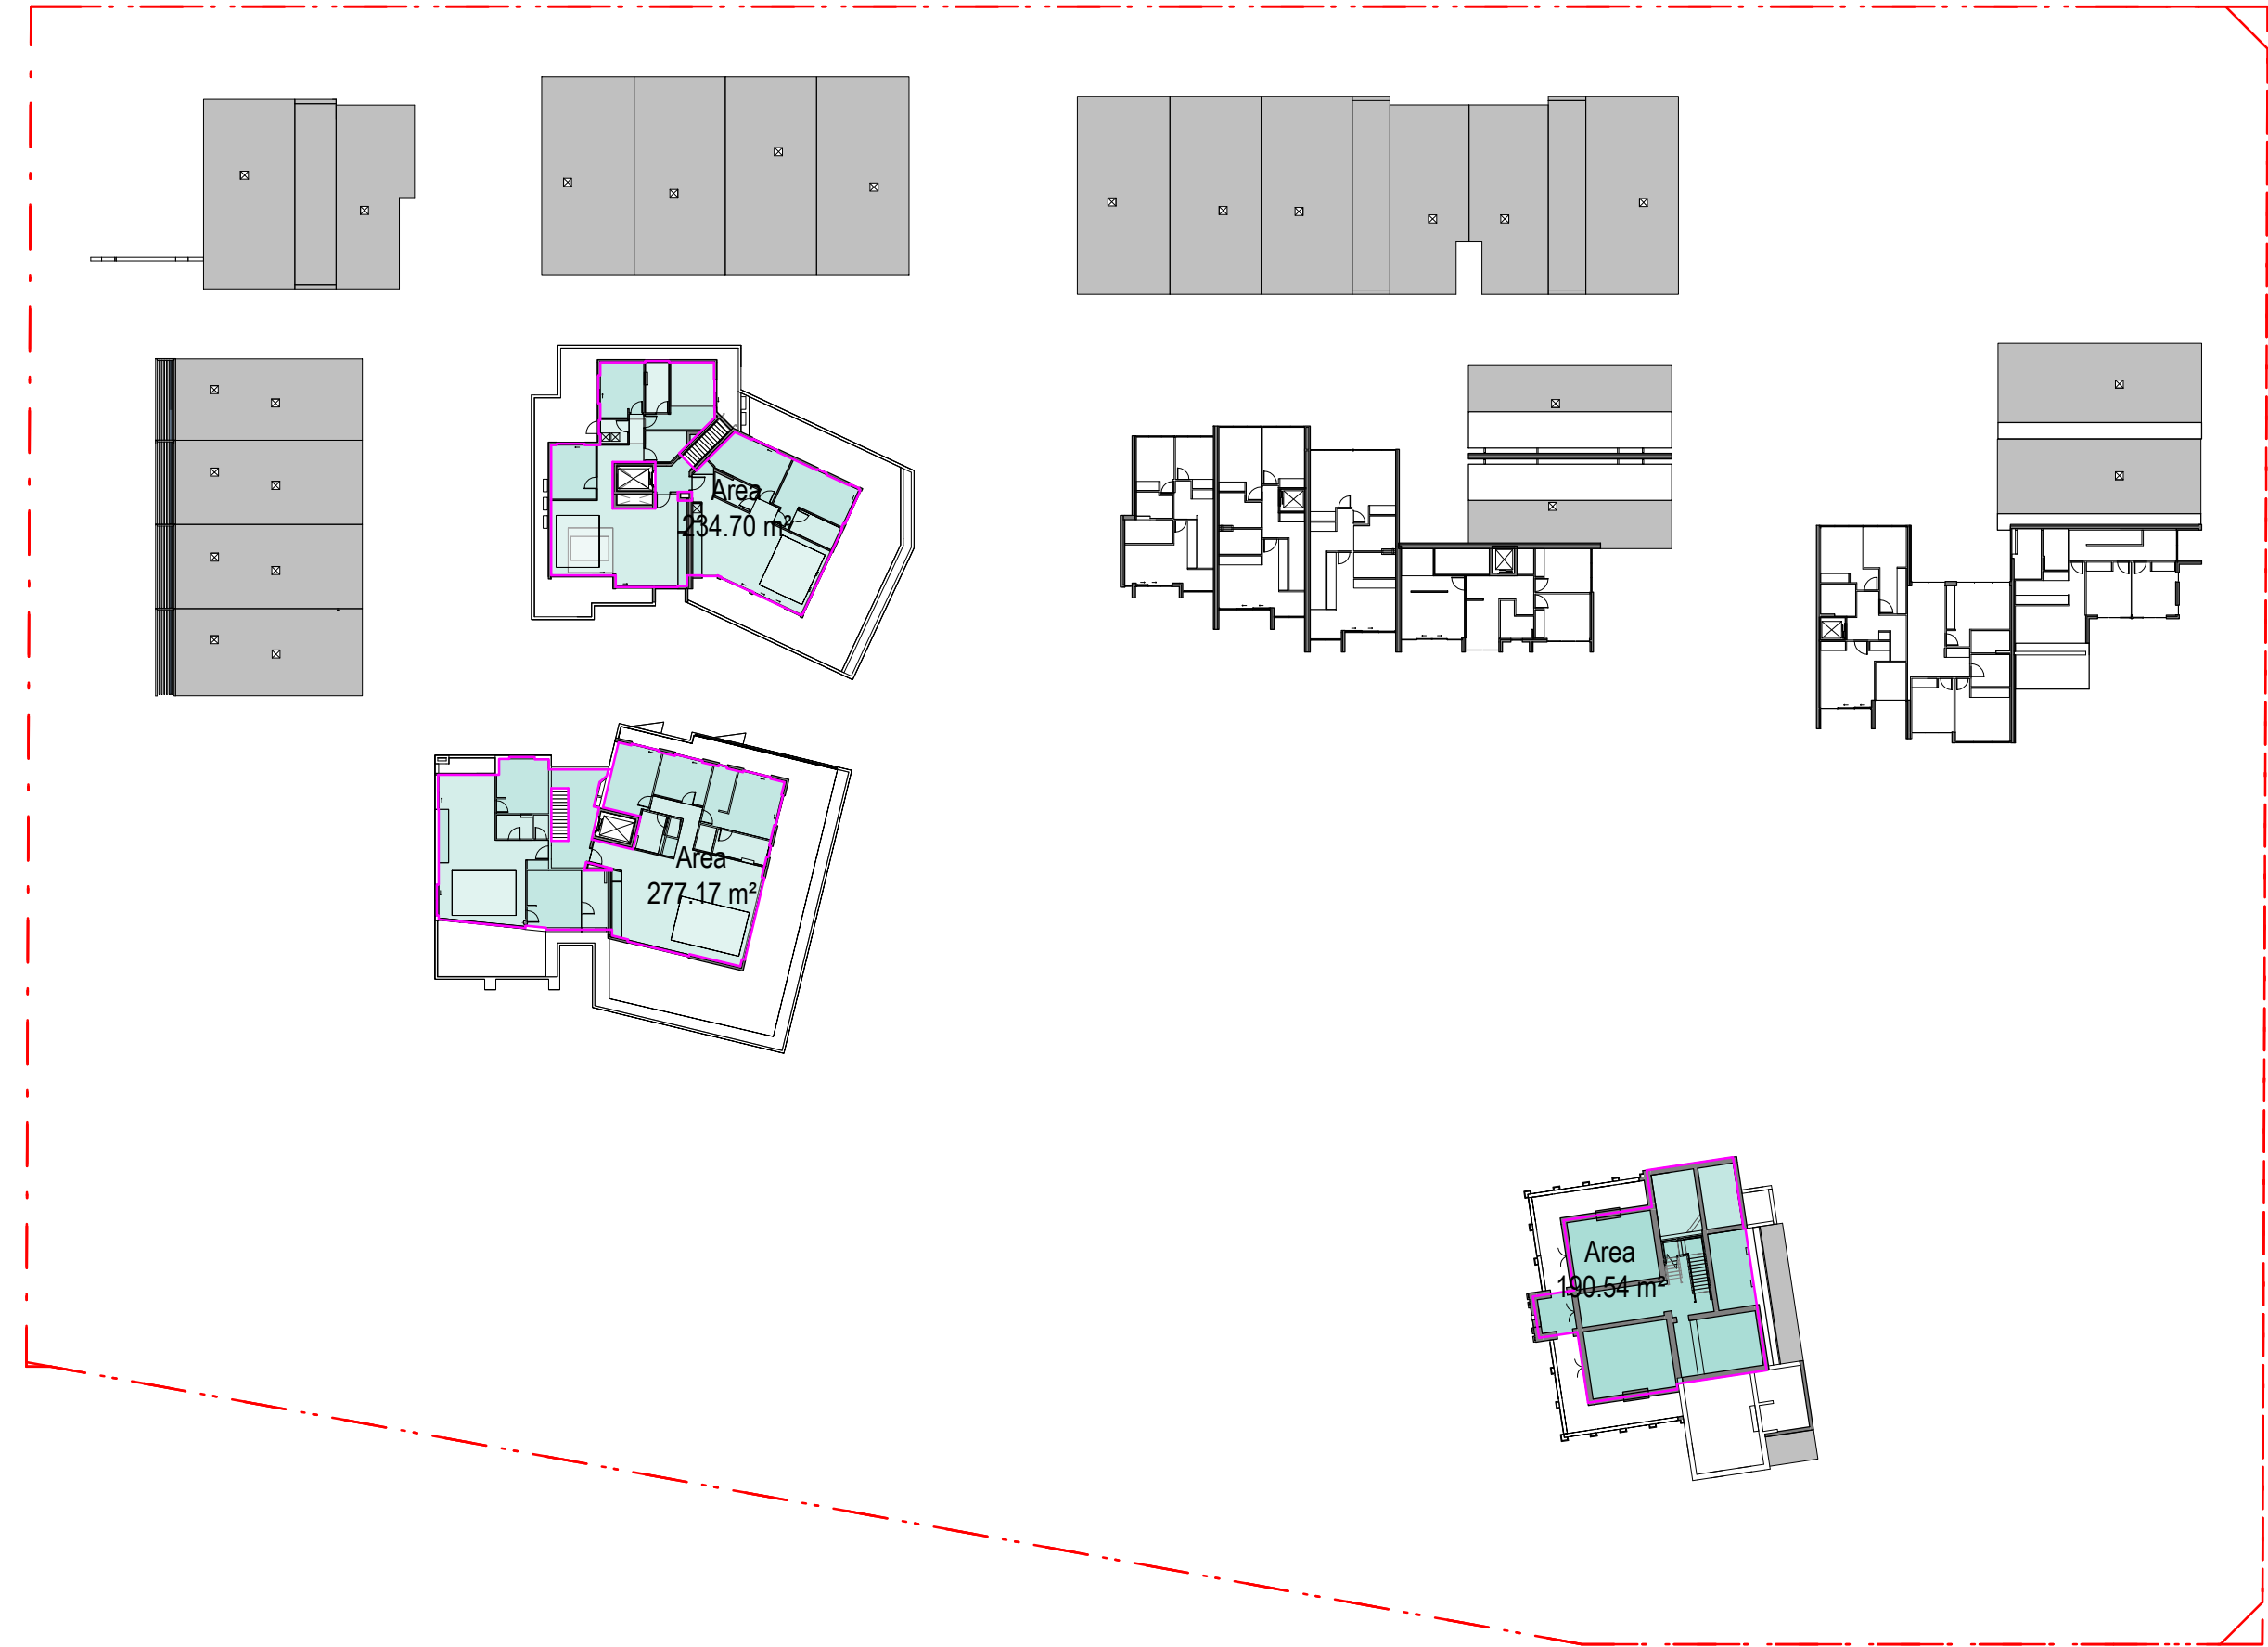

FSR-GFA_SECOND FLOOR

GFA AREA	
Level	Area
BASEMENT B1	538.28 m²
GROUND FLOOR	3384.01 m²
FIRST FLOOR	3445.78 m²
SECOND FLOOR	702.41 m²
TOTAL GFA AREA	7990.49 m²

SITE AREA: 17493.6
FSR 0.45:1
FSR MAX 0.55:1
MAX GFA 9621.48
GFA PER PLANNING REPORT 7677.67

NOTE: STAIR AND LIFT WELL CALCULATED IN ACCORDANCE WITH:
Cherry v Lane Cove Council [2015] NSWLEC 1003

FIGURED DIMENSIONS GOVERN. DO NOT SCALE
OF DRAWINGS. VERIFY ALL DIMENSIONS ON SITE.
REPORT ANY DISCREPANCIES TO THE
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HEATHCOTE GROUND PTY LTD

CLIENT

HEATHCOTE GROUNDS

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Heathcote NSW 2233

FSR CALCULATIONS

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DATE 15/01/2021
SCALES 1 : 500 @A0

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CHECKED Checker

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SCALE BAR - 1:500

PROJECT N°

DRAWING N°

REVISION



P20-056

MOD15

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Drawing Area 1237 1 (as Amending 1202 1, Pictorial Draw 8118 1, Gallery Draw 8100 1, 7/20)
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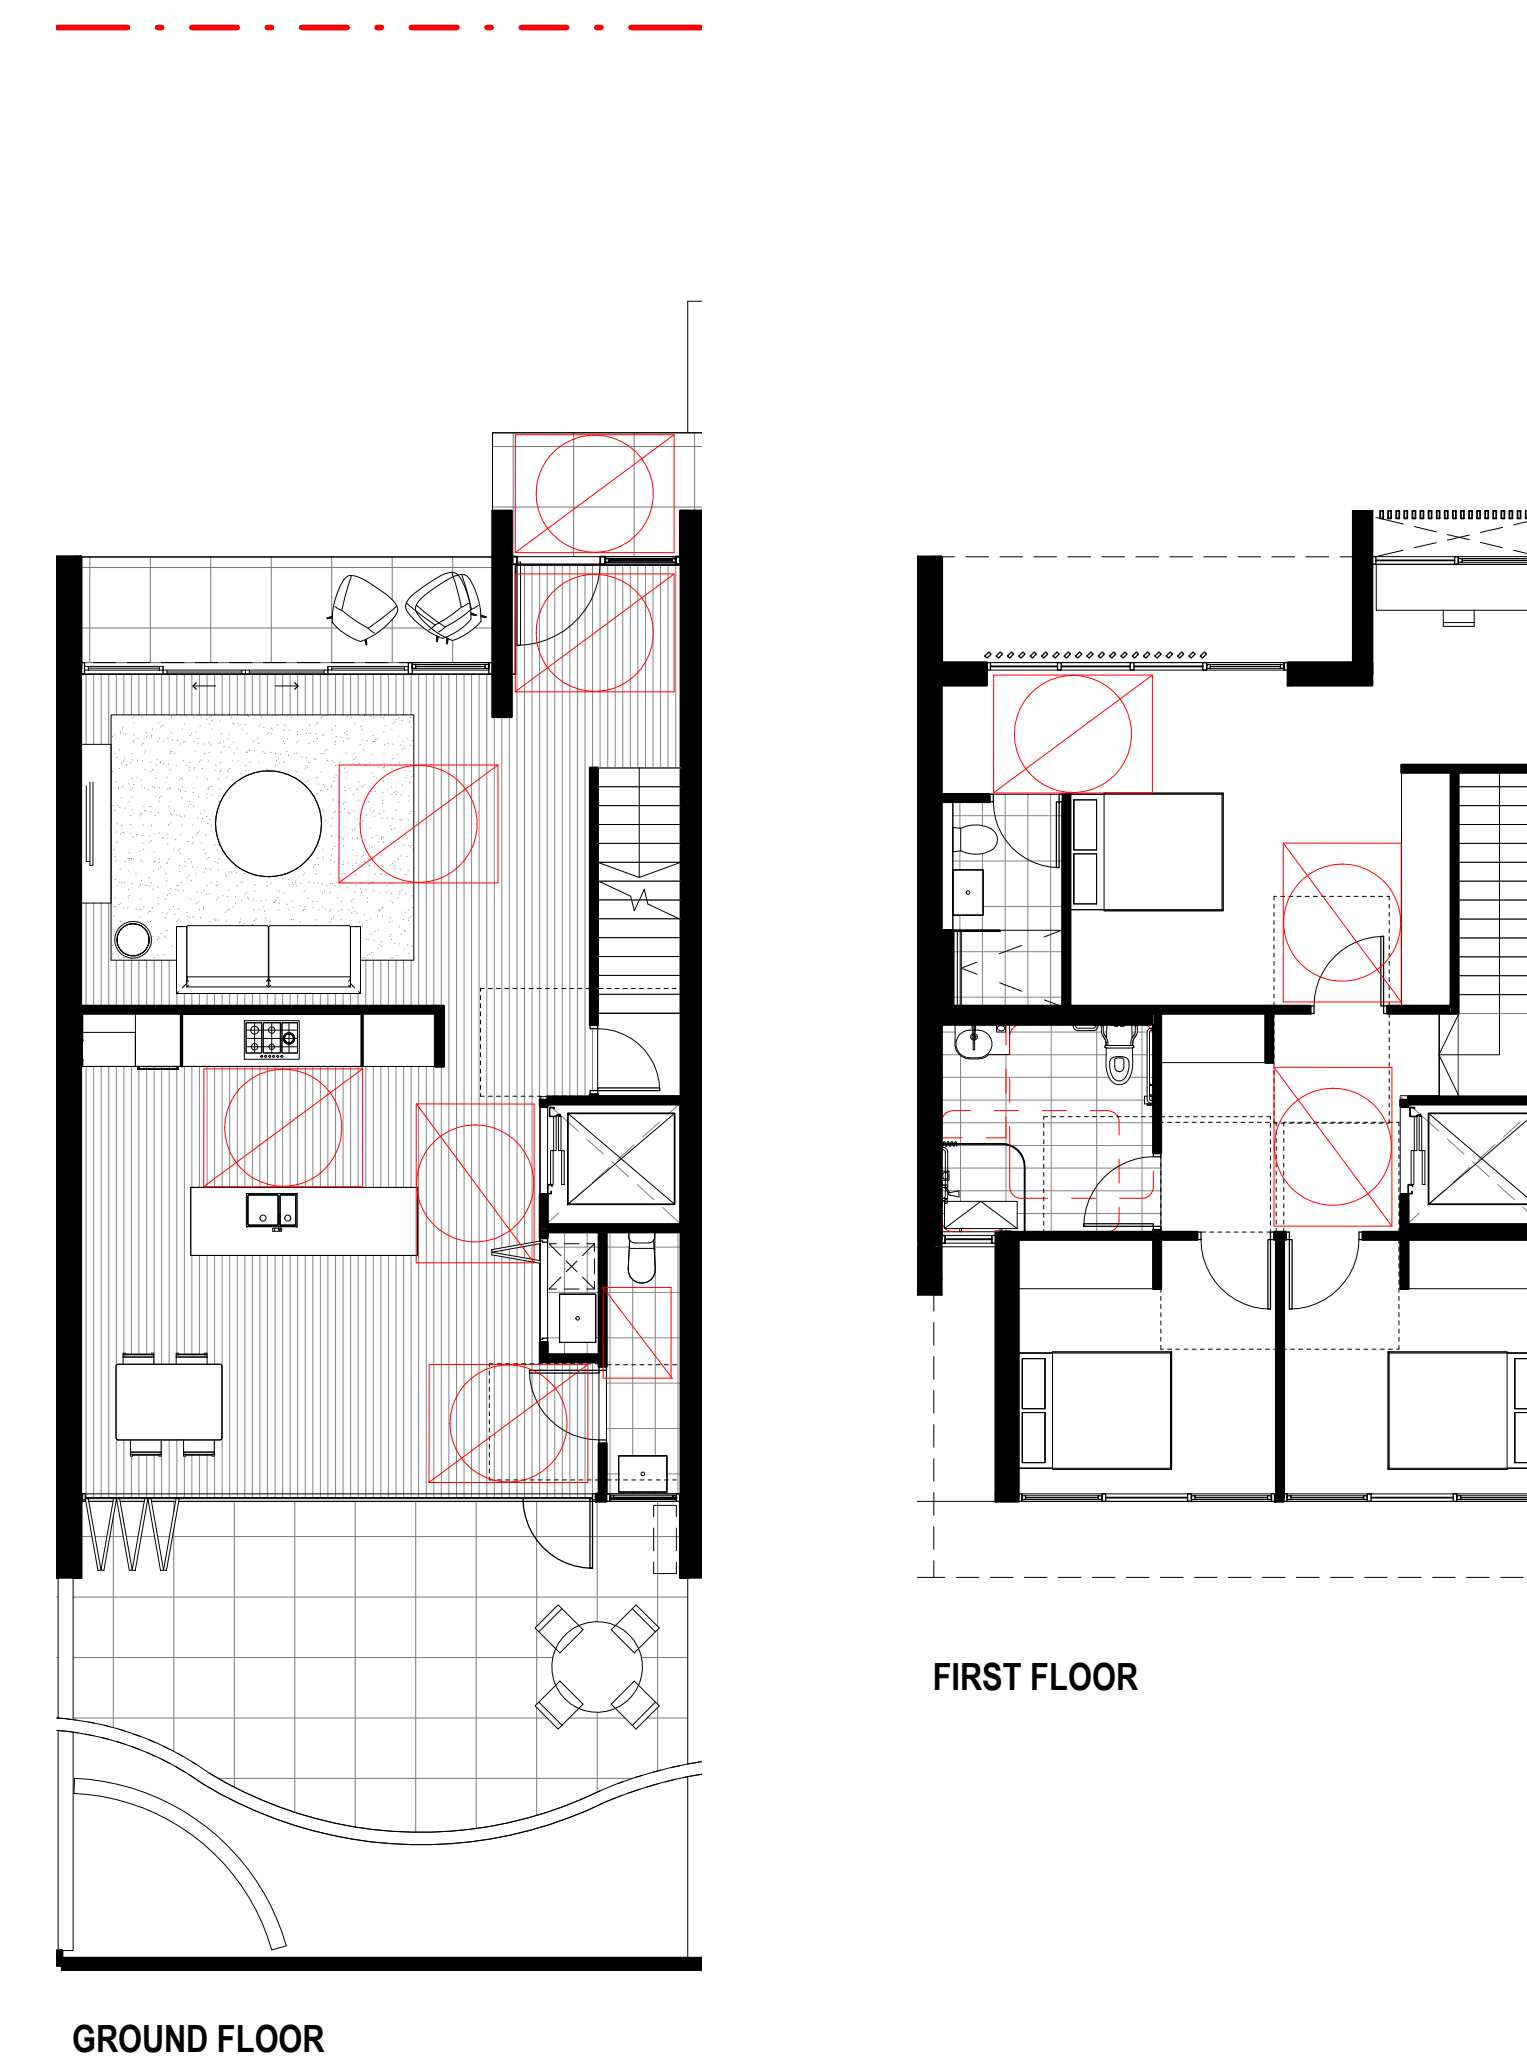
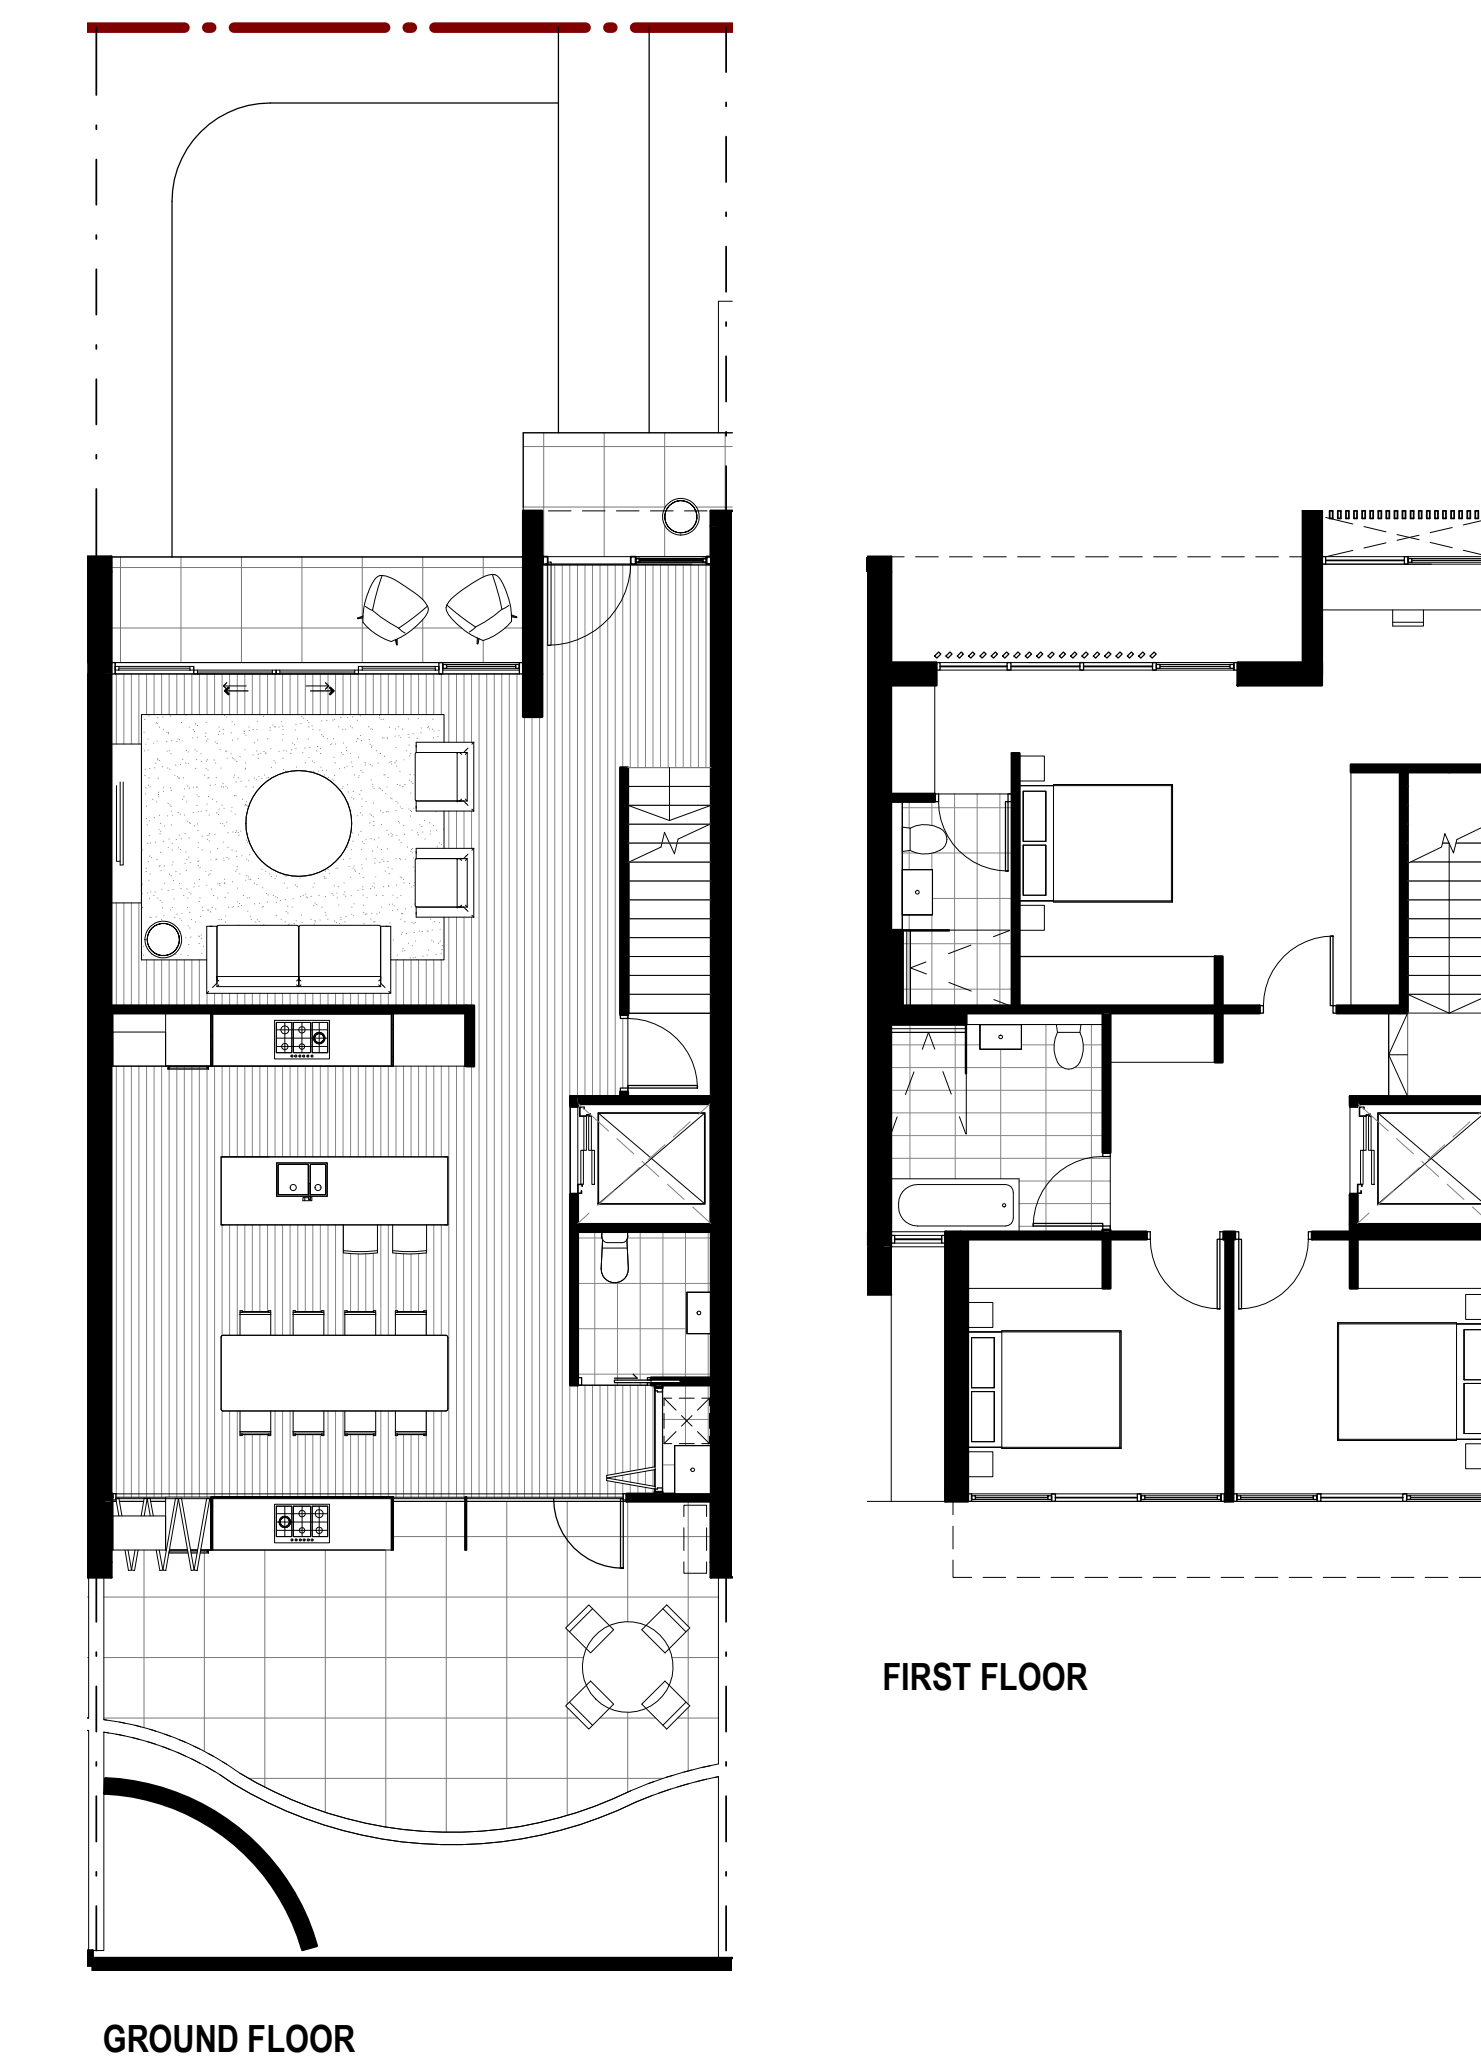
TOWNHOUSE NO 07



TOWNHOUSE NO 08

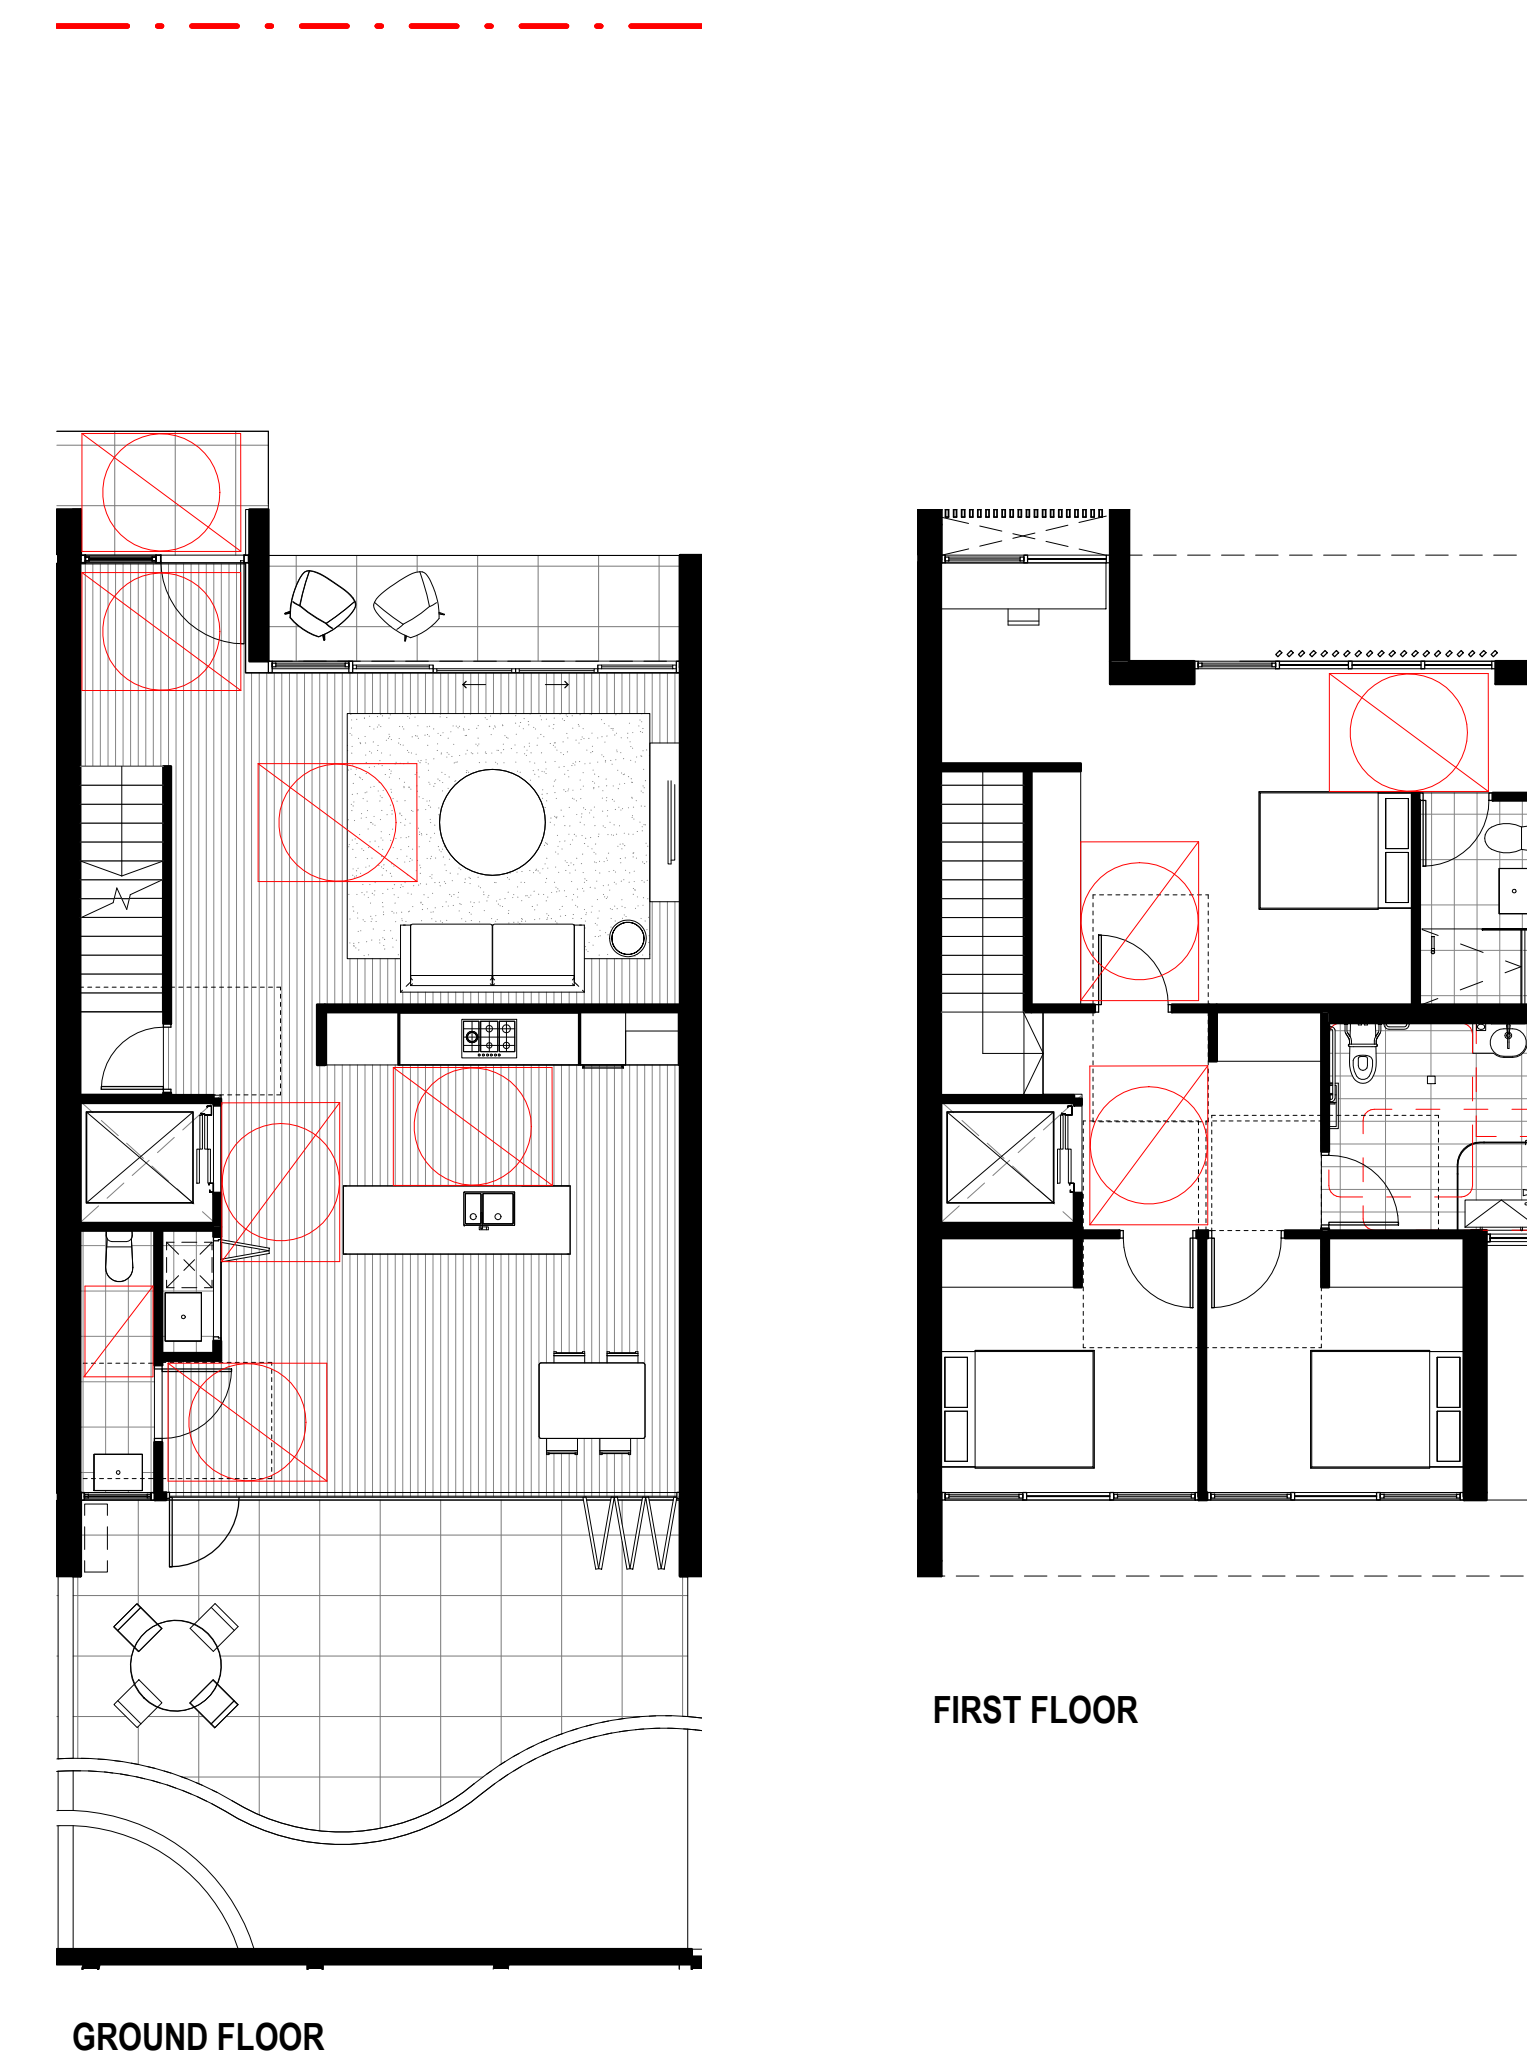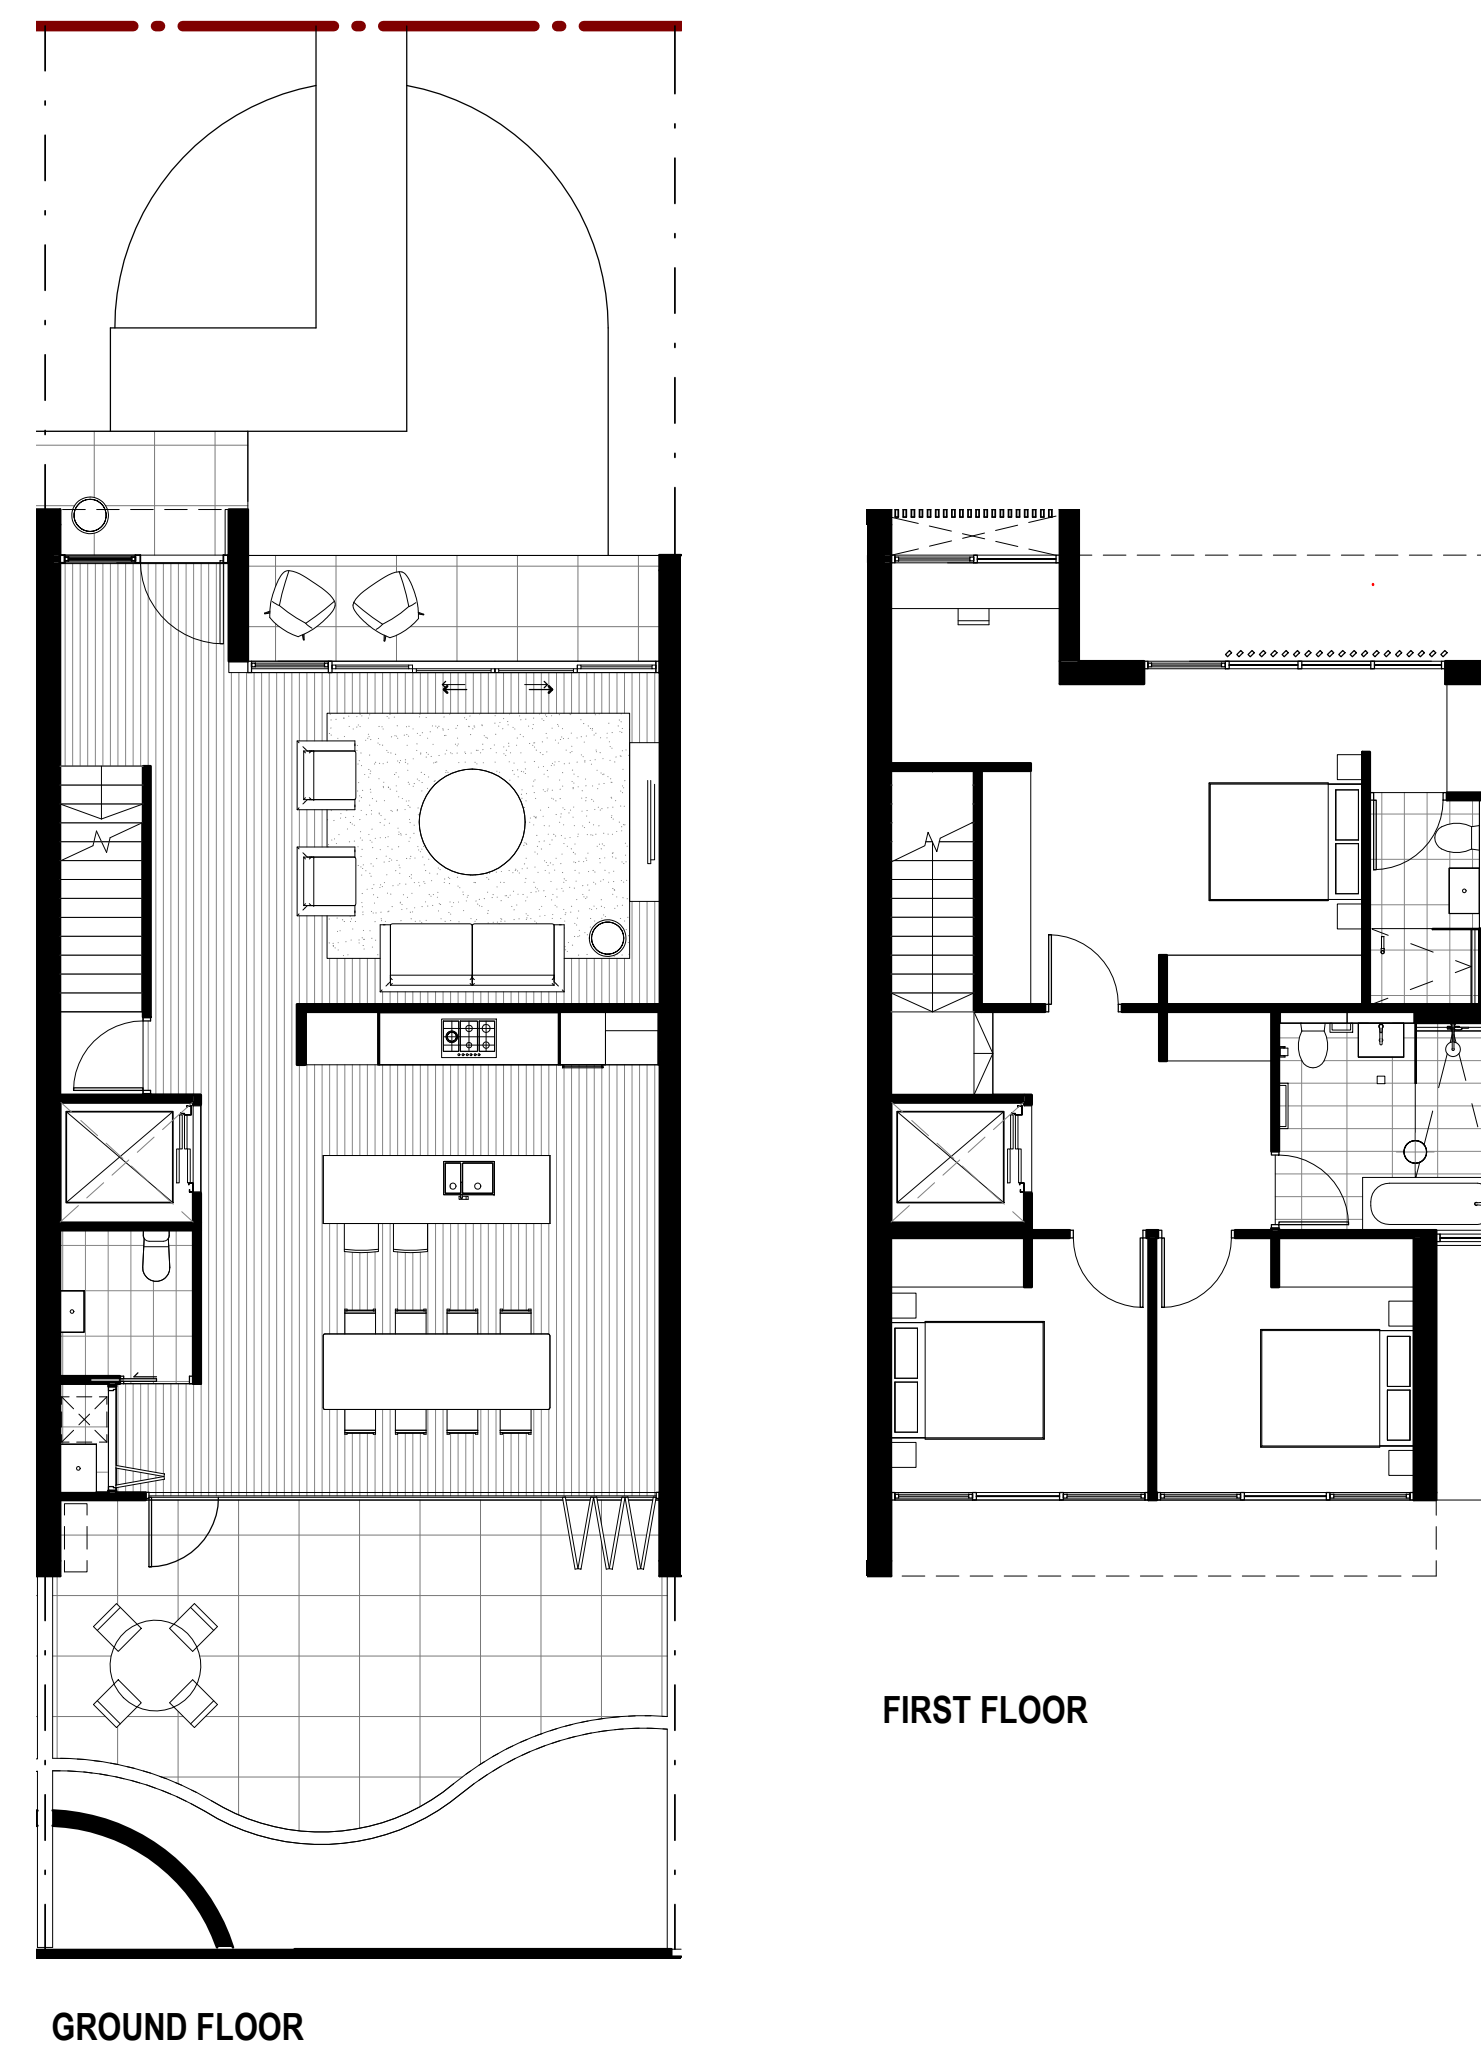

TOWNHOUSE NO 12



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HEATHCOTE GROUND PTY LTD

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HEATHCOTE GROUNDS

1-21 Dillwynnia Grove,
Heathcote NSW 2233

ADAPTABLE TOWNHOUSE 7, 8, 11 & 12

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SCALES 1 : 100 @A0

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PROJECT N°.

DRAWING N°.

REVISION

P20-056

MOD16

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Nominated Architects
Sandeep Amin 7337 | Ian Armstrong 7268 | Richard Does 8126 | Cathryn Drew-Bredin 7269
| Mary Anne McGee 10605 |

TOWNHOUSE NO 13



The image displays two architectural floor plans. The top plan is labeled 'FIRST FLOOR' and the bottom plan is labeled 'GROUND FLOOR'. Both plans show a building layout with various rooms, including a staircase, a living area with a sofa, a dining area with a table and chairs, and a kitchen area. Red circles with diagonal lines are drawn over specific areas in both plans, likely indicating points of interest or concern. The ground floor plan shows a large outdoor area with a curved path and a large table with chairs.


TOWNHOUSE NO 22




TOWNHOUSE NO 14



APARTMENT UNIT B101 & B201
(OUTDOOR AREA DIFFERS)

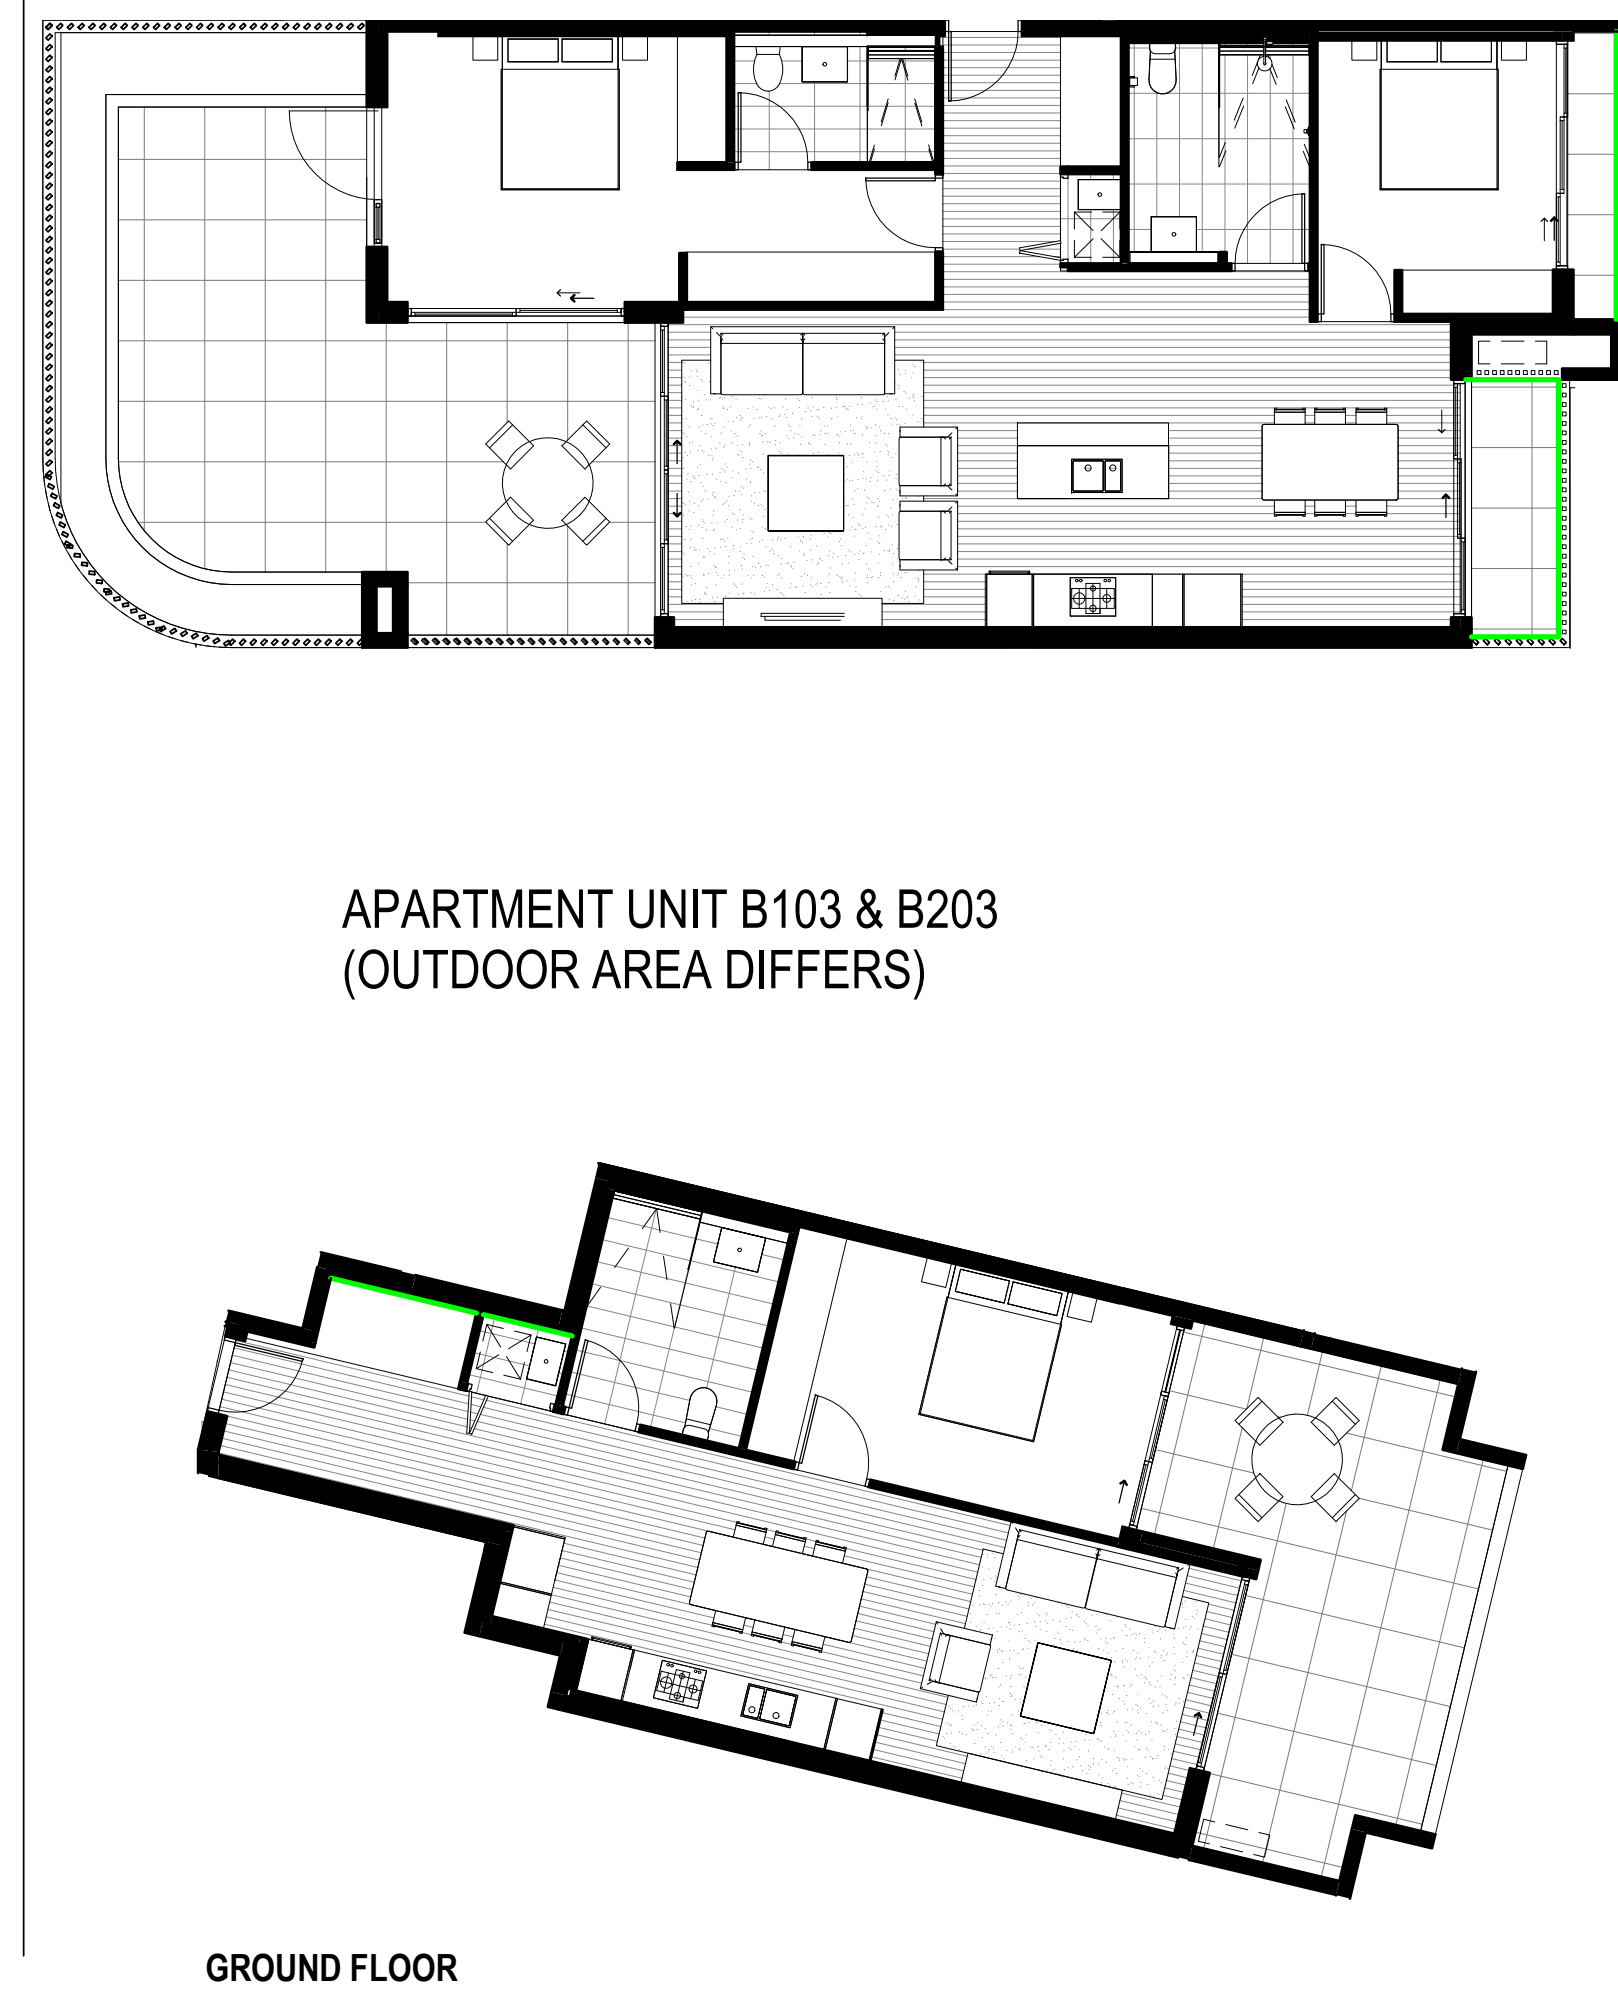

APARTMENT UNIT B103 & B203
(OUTDOOR AREA DIFFERS)

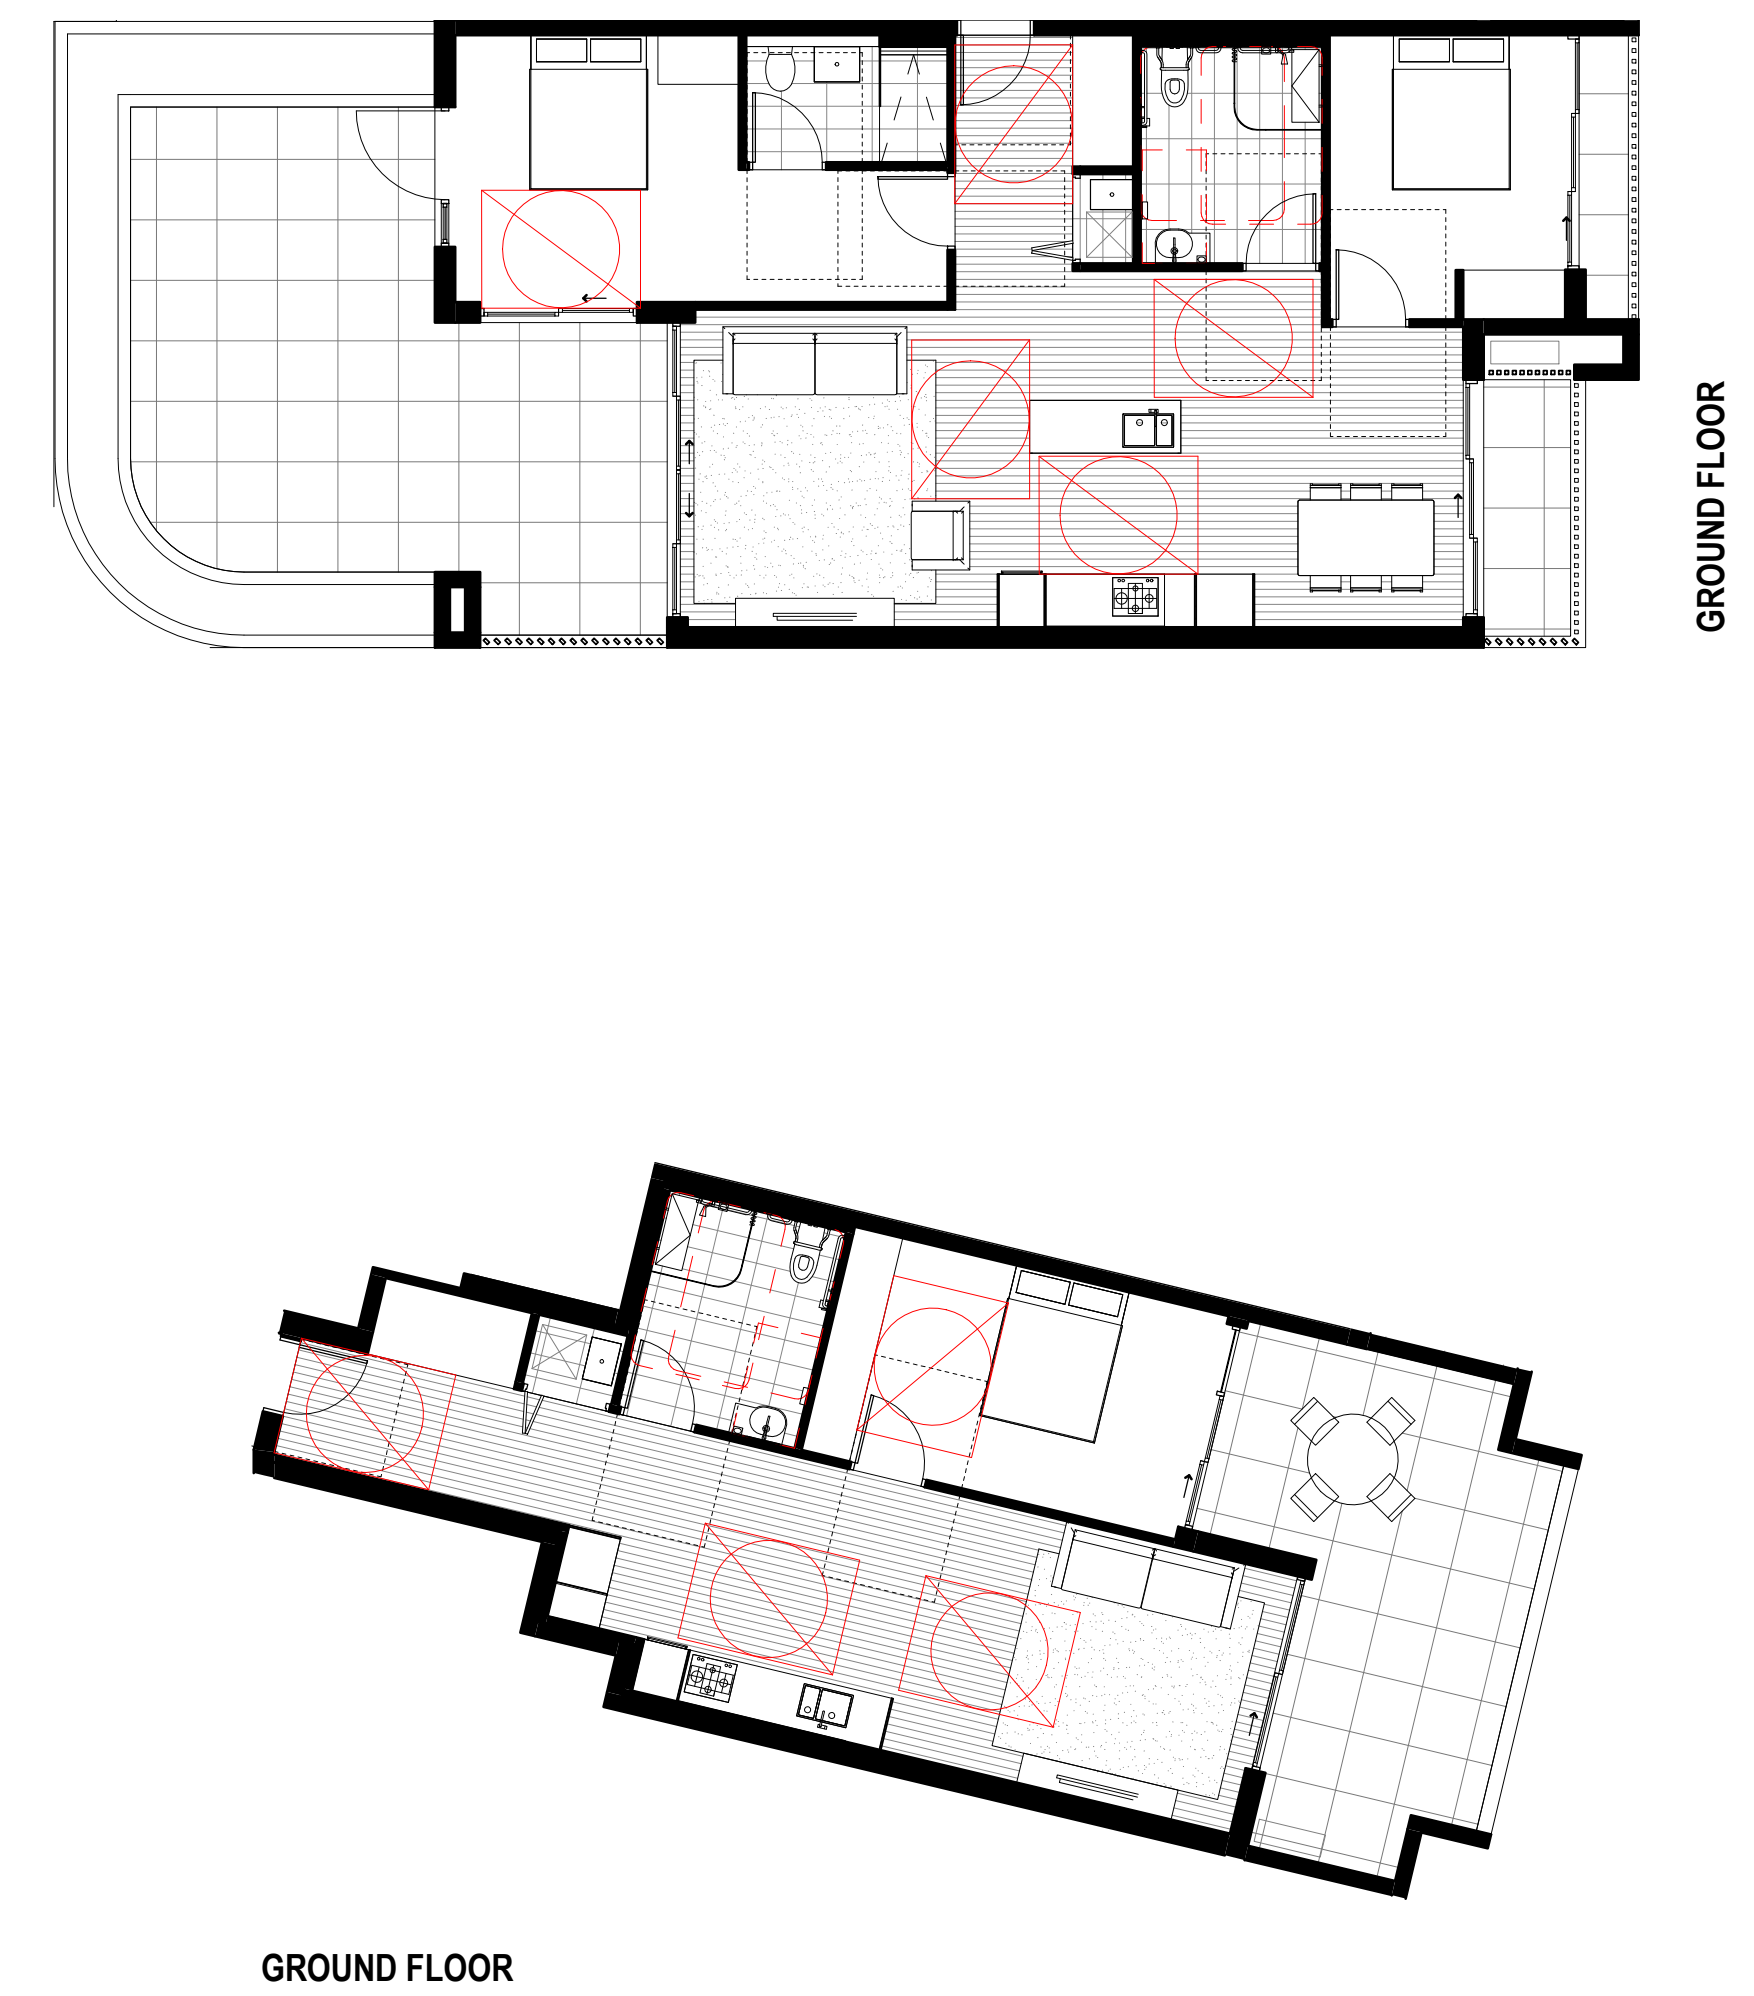

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CLIENT

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Heathcote NSW 2233

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+61 2 8905 7100
sydney@designinc.com.au

DATE 15/01/2021
SCALES 1 : 100 @A0

DRAWN Author
CHECKED Checker

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mm
SCALE BAR - 1:100

PROJECT N^o.

DRAWING N°.


REVISION

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Nominated Architects
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| Mary Ann Mc-Gee / 10046


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SCREENING


DECOWOOD CONTEMPORARY - SMOKED ASH

Continued



**BASEMENT DOORS, ALUMINIUM FRAMED
EXTERIOR DOORS, WINDOWS & LOUVRES**

**MONUMENT EB C29
TAUBMANS FINISHED**



SCREENING


DECOWOOD CONTEMPORARY - DRIFTWOOD




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Nominated Architects
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| Mary Ann Gask 10945

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sydney@designline.com.au


P20-056	MOD20	A
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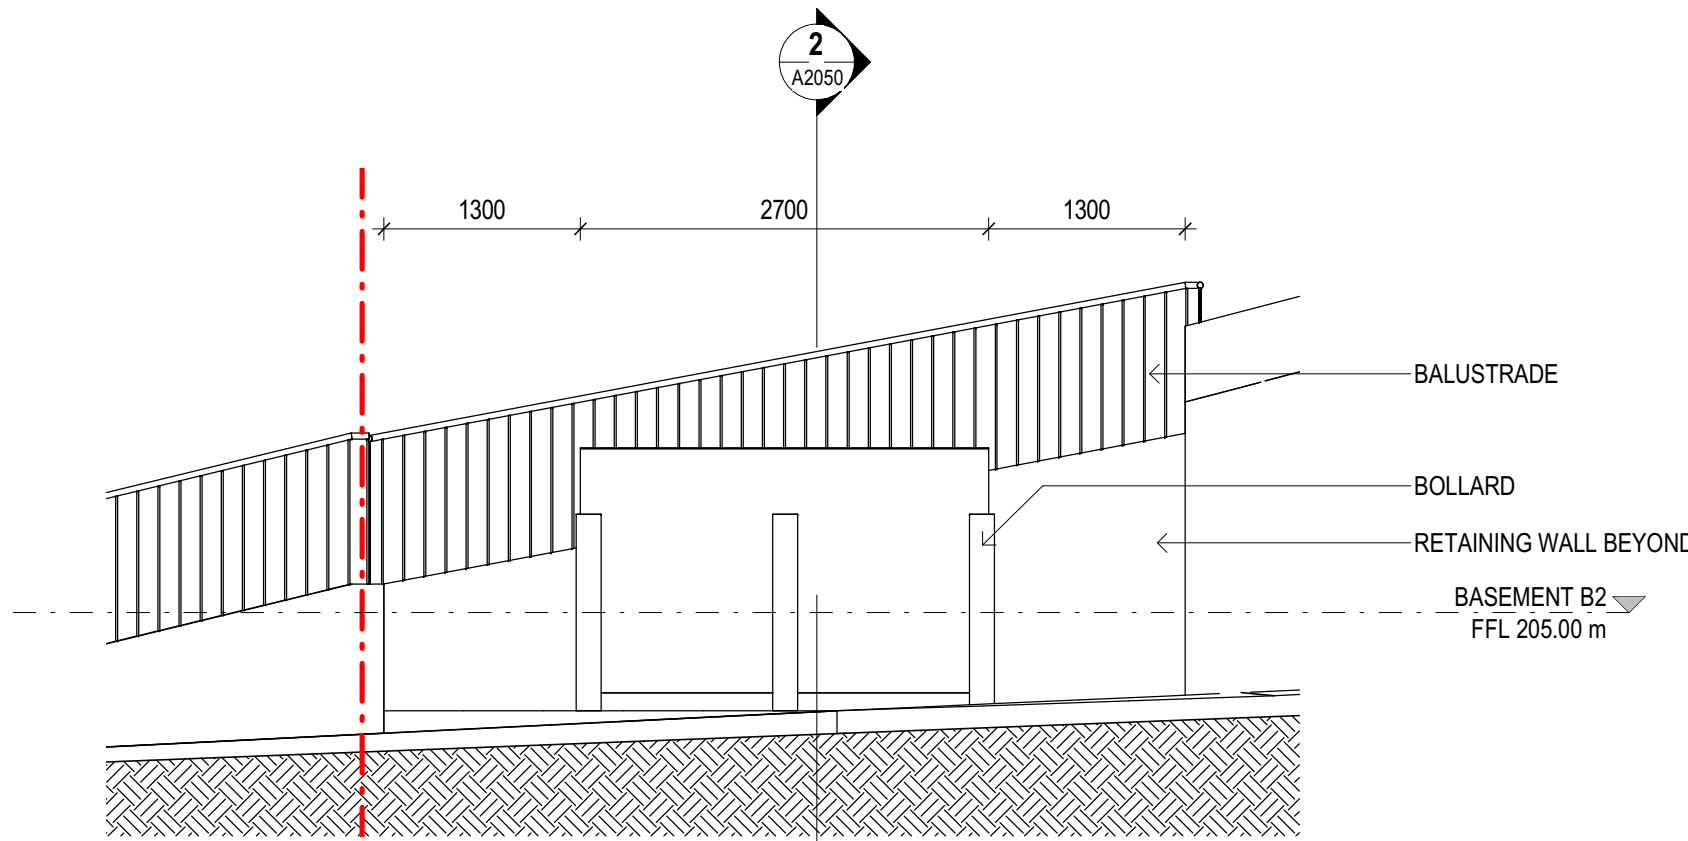
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A301 SCALE 1:50

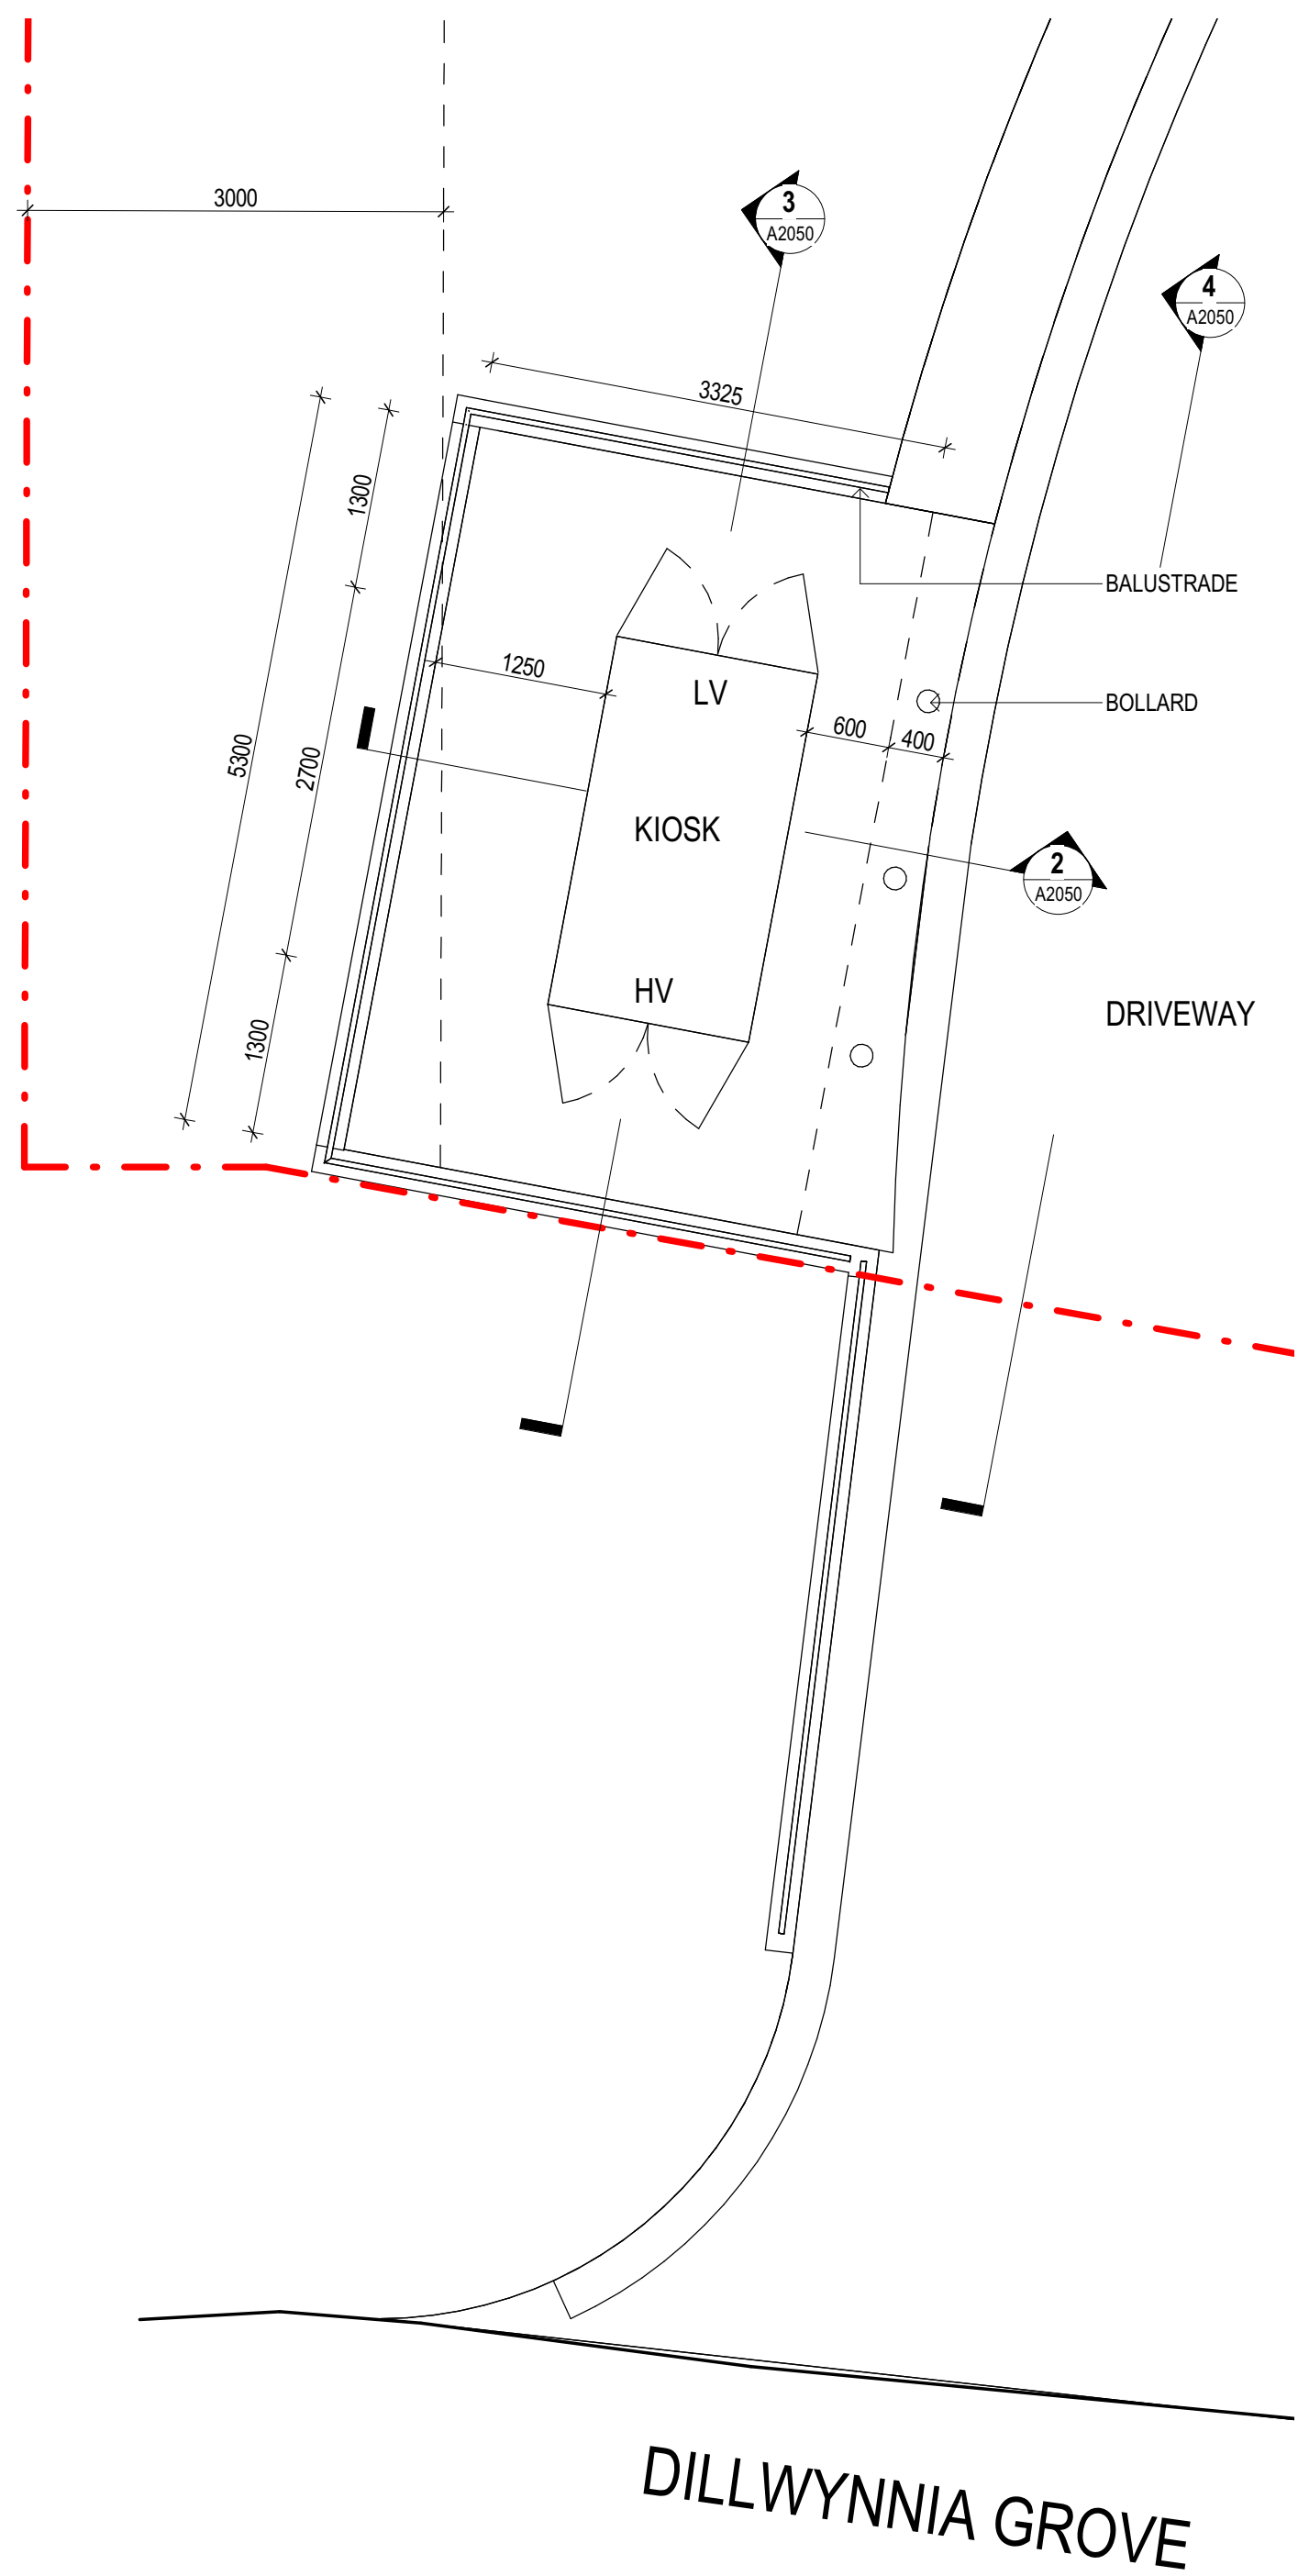


2 SUBSTATION SECTION 2
A2050 SCALE 1:50

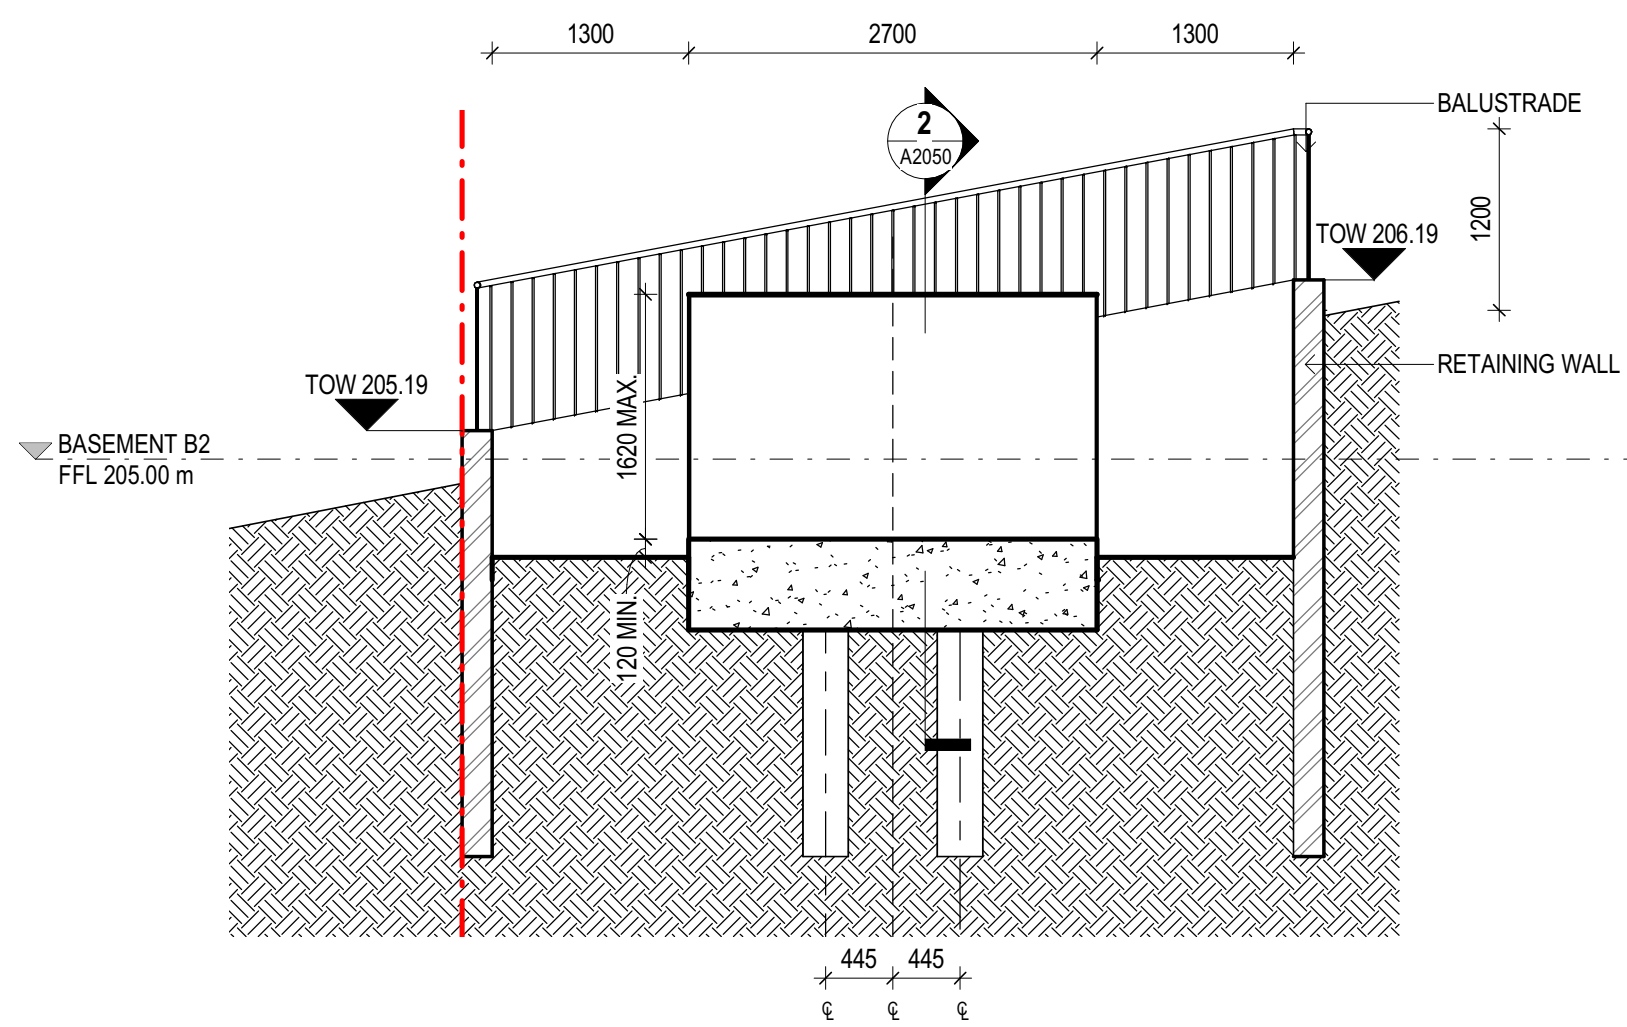

2 SUBSTATION SECTION 1
A2050 SCALE 1:50

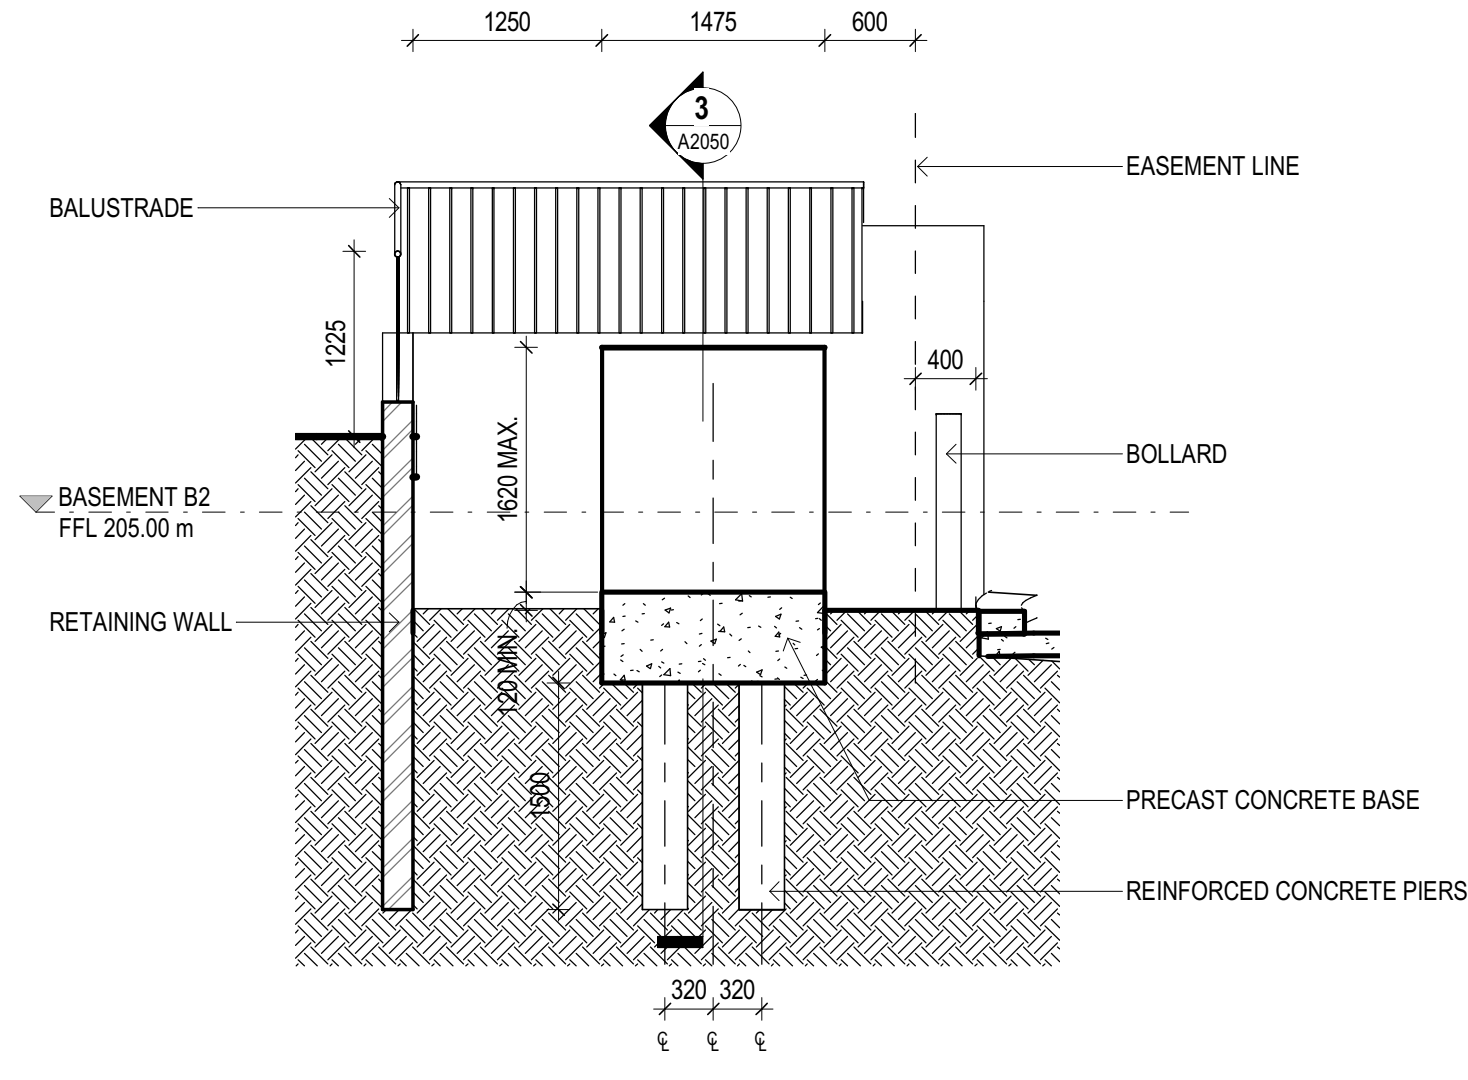

4 SUBSTATION SECTION 3
A2050 SCALE 1:50

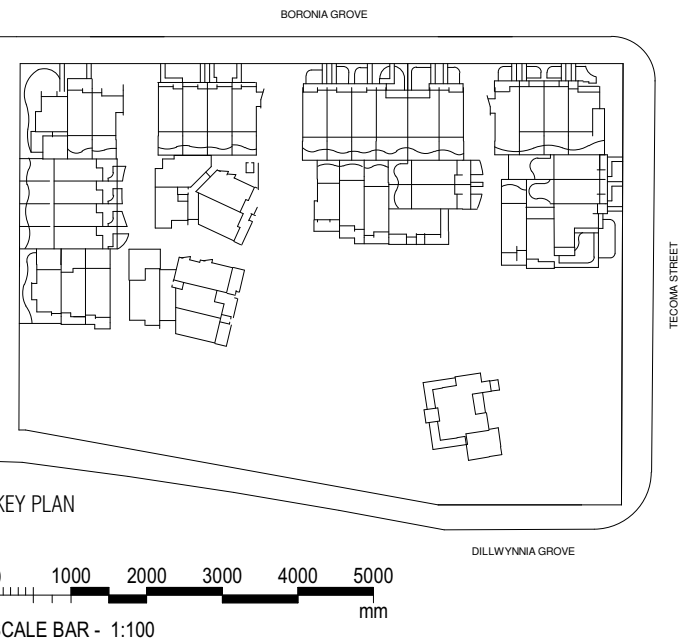

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Report any discrepancies to the Superintendent for decision before proceeding with the work.
Nominated Architects
Sydney Area 1227 1 lan Armstrong 7200 1 Richard Doss 8126 1 Cathryn Drew-Bedder 7200 1 Mary Anne McGee 10946

No	DATE	REVISIONS	BY
----	------	-----------	----

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sydney@designinc.com.au

CLIENT
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Level 23 Deutsche Bank Place,
125 Phillip Street, Sydney NSW 2000


PROJECT
HEATHCOTE GROUNDS
1-21 DILLWYNNIA GROVE,
HEATHCOTE 2233 NSW

TITLE
**EXTERNAL DETAILS -
SUBSTATION**

N	DRAWN BY	Author
PLOT DATE	SCALES	1:50 @B1
PROJECT N°	P20-056	REVISION
DRAWING N°	A2050	
DRAWING STATUS	REVIEWED BY	SIGNATURE DATE
	Checker	

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TENDER

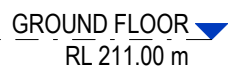

ARCHITECT		<h1>DesignInc</h1> <p>DesignInc Sydney Pty Ltd Level 14, 85 Castlereagh Street Sydney NSW 2000 Australia +61 2 6905 7100 www.designinc.com.au</p>	
CLIENT		HEATHCOTE GROUNDS PTY LTD Level 23 Deutsche Bank Place, 126 Phillip Street, Sydney NSW 2000	
PROJECT		HEATHCOTE GROUNDS 1-21 DILLWYNNIA GROVE, HEATHCOTE 2233 NSW	
TITLE		EXTERNAL DETAILS - HYDRANT BOOSTER	
DRAWN BY		NU	
PLOT DATE		1 : 20 @B1	
PROJECT NO.	P20-056	REVISION	
DRAWING NO.	A2051	A	
DRAWING STATUS	REVIEWED BY	SIGNATURE	DATE
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<h2>TENDER</h2>			

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HEATHCOTE GROUNDS

HISTORIC HEATHCOTE HALL


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DRAWING LIST	
DRAWING NO.	DRAWING TITLE
C-01-01	DRAWING SCHEDULE, LEGEND AND LOCALITY PLAN
C-01-02	SPECIFICATION NOTES
C-03-01	SITEWORKS AND GRADING PLAN
C-03-11	PAVEMENT PLAN
C-03-51	SITEWORKS DETAILS
C-04-11	TYPICAL SECTIONS
C-04-21	DRIVEWAY LONG SECTIONS - SHEET 01 OF 03
C-04-22	DRIVEWAY LONG SECTIONS - SHEET 02 OF 03
C-04-23	DRIVEWAY LONG SECTIONS - SHEET 03 OF 03
C-05-01	STORMWATER DRAINAGE LAYOUT PLAN
C-05-21	STORMWATER CATCHMENT PLAN
C-05-61	STORMWATER DRAINAGE DETAILS
C-06-01	EROSION AND SEDIMENT CONTROL PLAN
C-06-11	EROSION AND SEDIMENT CONTROL DETAILS

CIVIL LEGEND PROPOSED	
	LIMIT OF WORKS
	STORMWATER OVERLAND FLOW PATH
	• P56.20 FINISHED SURFACE LEVEL
	• EX56.20 EXISTING SURFACE LEVEL
	FINISHED FLOOR LEVEL
	EXISTING SURFACE CONTOUR
	PROPOSED SURFACE CONTOUR MINOR
	PROPOSED SURFACE CONTOUR MAJOR
	BATTER WITH SLOPES 1(VERT): 4(HORIZONTAL) UNO
	SETOUT POINT
	BOLLARD
	STORMWATER DRAINAGE STRUCTURE WITH NUMBER (REFER STORMWATER DRAINAGE STRUCTURES SCHEDULE)
	STORMWATER DRAINAGE LINE WITH DIAMETER AND FLOW DIRECTION
	SWALE
	CULVERT
	BASEMENT UPPER LEVEL
	BASEMENT LOWER LEVEL
	STRUCTURAL ROOT ZONE
	TREE PROTECTION ZONE



LOCALITY PLAN

Rev	Revision Description	Date
04	ISSUED FOR TENDER	16.12.20
03	ISSUED FOR TENDER	10.12.20
02	ISSUED FOR TENDER	27.11.20
01	ISSUED FOR INFORMATION	23.11.20

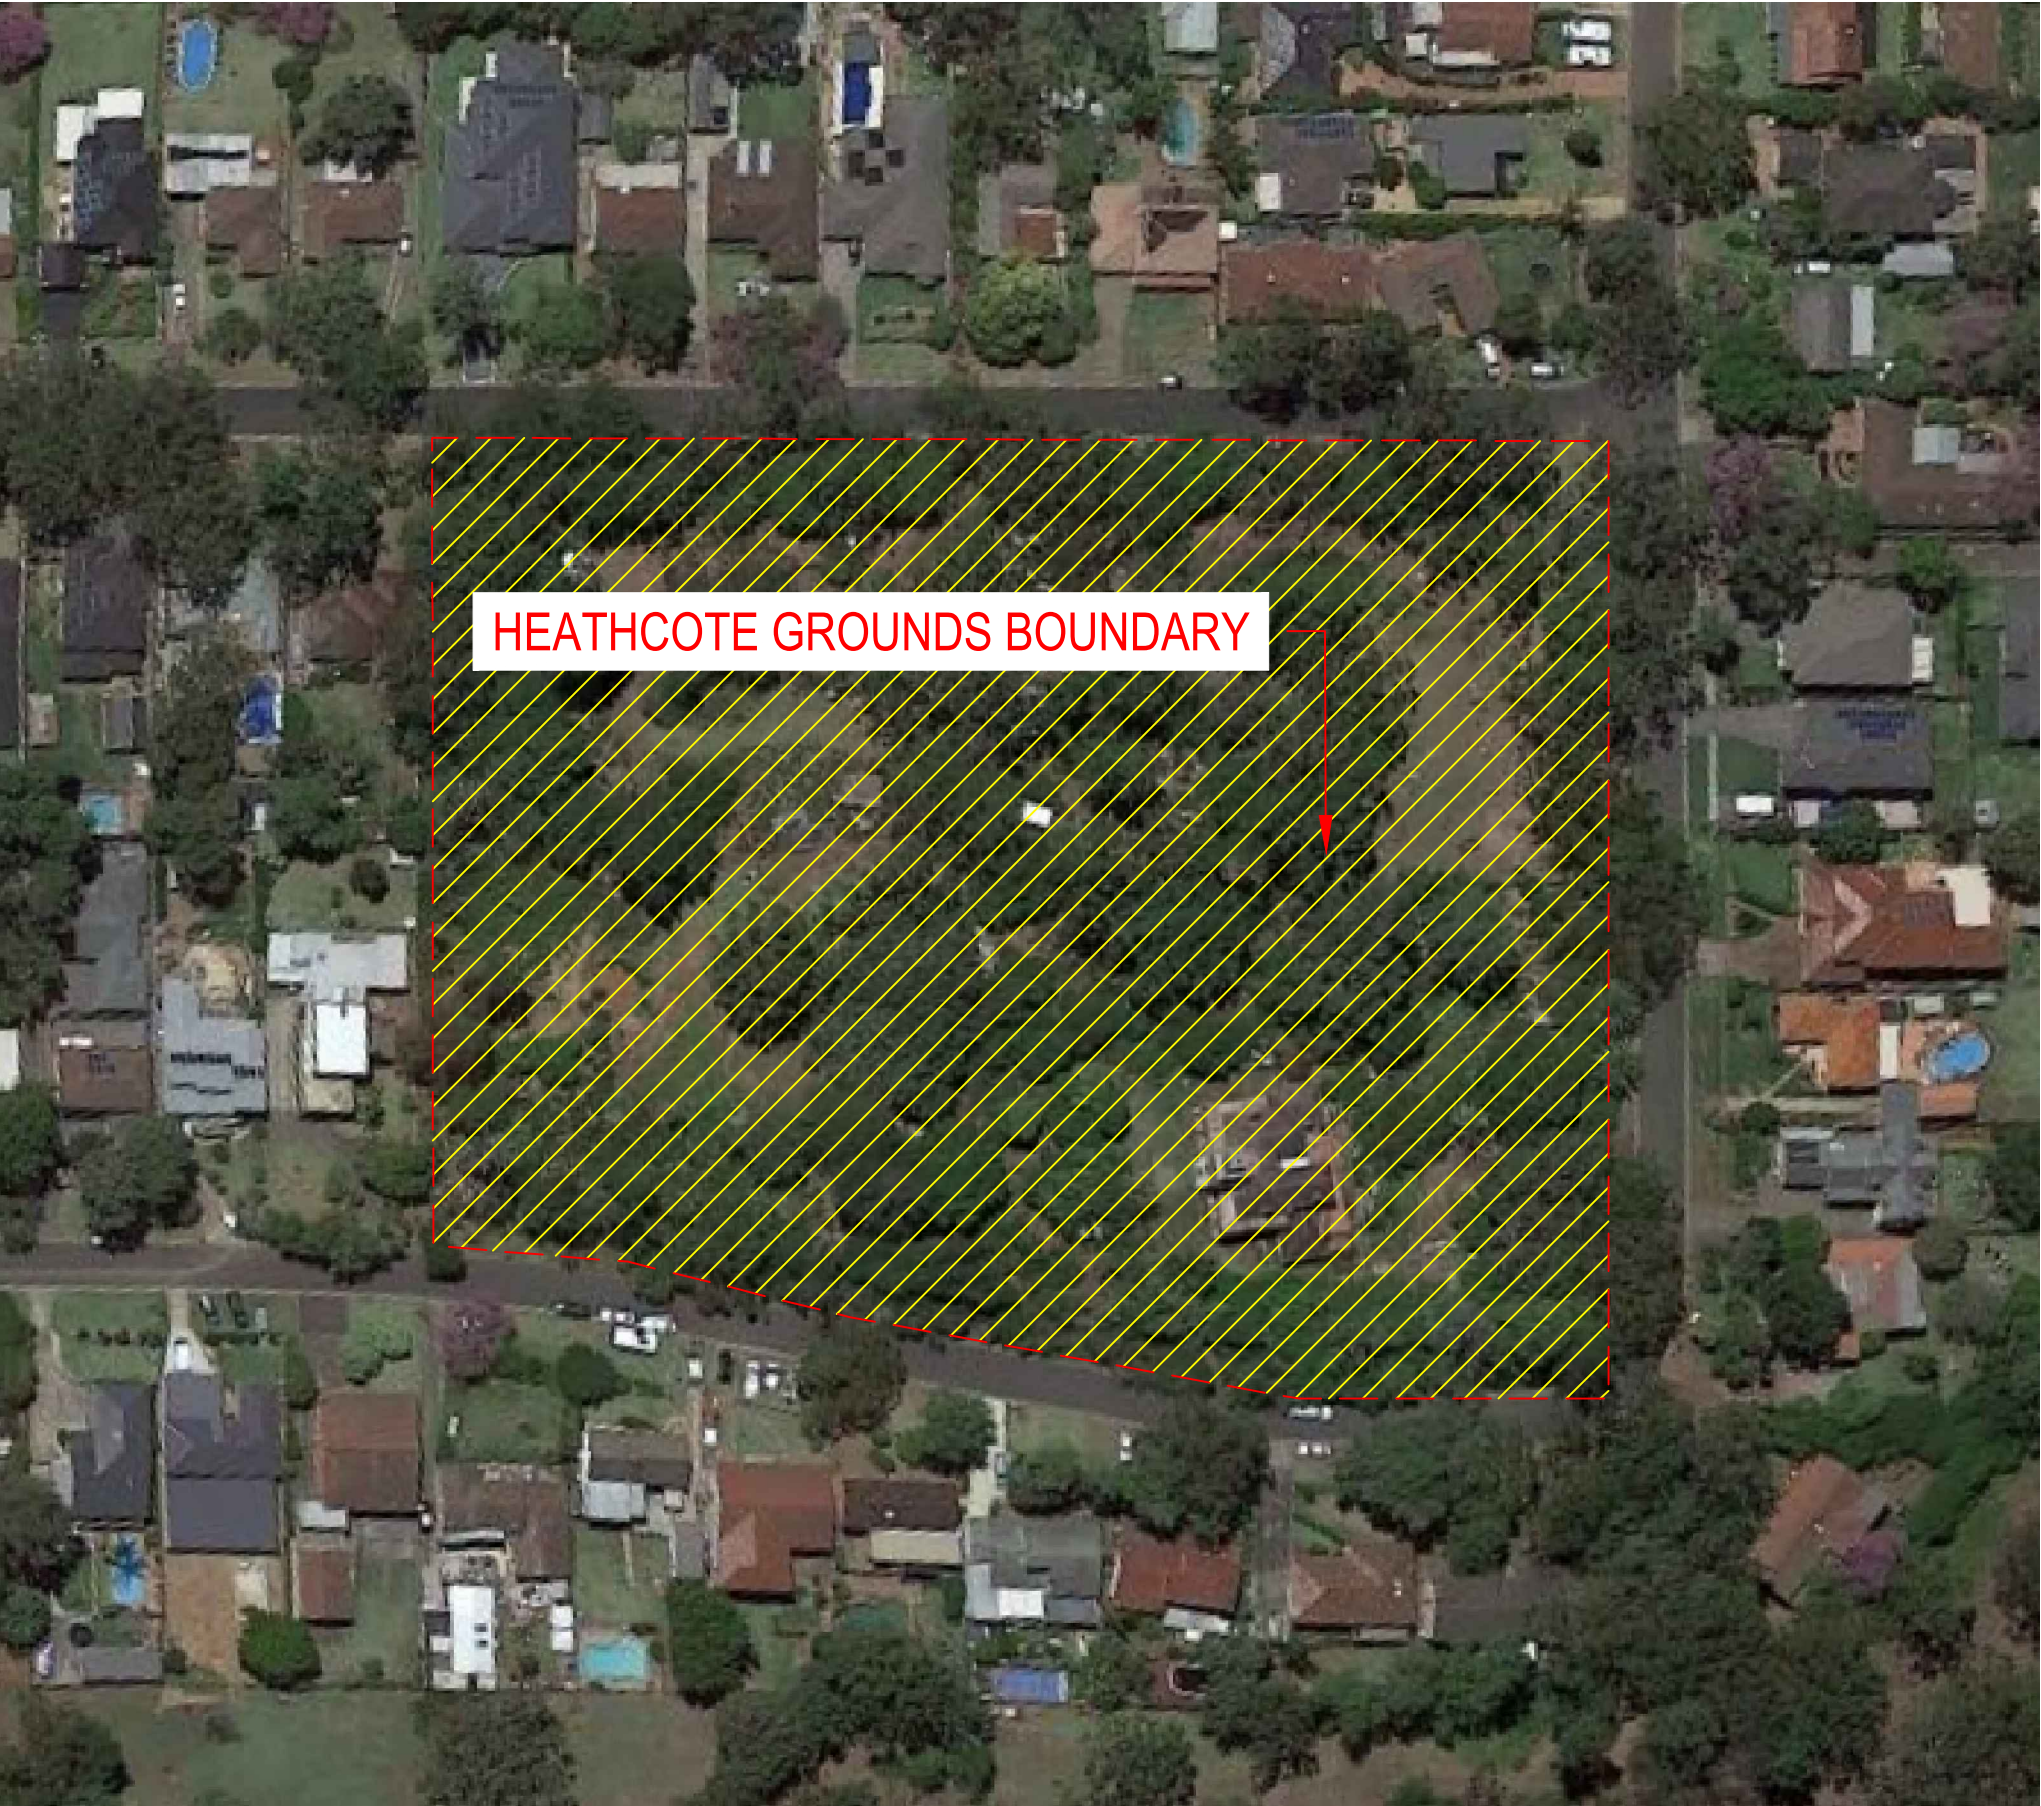

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and development
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Client
PARITER PTY LTD

Project
HEATHCOTE GROUNDS
MAIN WORKS

Title
DRAWING SCHEDULE, LEGEND
AND LOCALITY PLAN

Scale
NOT TO SCALE

Drawn JE	Checked BK	Approved JC	Project Number S201117	Drawing Number C-01-01	Revision 04
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SITeworks NOTES

1. ORIGIN OF LEVELS :- AUSTRALIAN HEIGHT DATUM (A.H.D.)
2. CONTRACTOR MUST VERIFY ALL DIMENSIONS AND EXISTING LEVELS ON SITE PRIOR TO COMMENCEMENT OF WORK.
3. ALL WORK IS TO BE UNDERTAKEN IN ACCORDANCE WITH THE DETAILS SHOWN ON THE DRAWINGS, THE SPECIFICATIONS AND THE DIRECTIONS OF THE PRINCIPAL'S REPRESENTATIVE.
4. EXISTING SERVICES HAVE BEEN PLOTTED FROM SUPPLIED DATA AND AS SUCH THEIR ACCURACY CANNOT BE GUARANTEED. IT IS THE RESPONSIBILITY OF THE CONTRACTOR TO ESTABLISH THE LOCATION AND LEVEL OF ALL EXISTING SERVICES PRIOR TO THE COMMENCEMENT OF ANY WORK. ANY DISCREPANCIES SHALL BE REPORTED TO THE PRINCIPAL'S REPRESENTATIVE. CLEARANCES SHALL BE OBTAINED FROM THE RELEVANT SERVICE AUTHORITY.
5. WHERE NEW WORKS ABOVE EXISTING THE CONTRACTOR SHALL ENSURE THAT A SMOOTH EVEN PROFILE, FREE FROM ABRUPT CHANGES IS OBTAINED.
6. THE CONTRACTOR SHALL ARRANGE ALL SURVEY SETOUT TO BE CARRIED OUT BY A REGISTERED SURVEYOR.
7. CARE IS TO BE TAKEN WHEN EXCAVATING NEAR EXISTING SERVICES. NO MECHANICAL EXCAVATIONS ARE TO BE UNDERTAKEN OVER COMMUNICATIONS OR ELECTRICAL SERVICES. HAND EXCAVATE IN THESE AREAS.
8. ALL SERVICE TRENCHES UNDER VEHICULAR PAVEMENTS SHALL BE BACKFILLED WITH AN APPROVED NON-NATURAL GRANULAR MATERIAL AND COMPACTED TO 98% STANDARD MAXIMUM DRY DENSITY IN ACCORDANCE WITH AS.1289.5.1.1.
9. ALL TRENCH BACKFILL MATERIAL SHALL BE COMPACTED TO THE SAME DENSITY AS THE ADJACENT MATERIAL.
10. ON COMPLETION OF PIPE INSTALLATION ALL DISTURBED AREAS MUST BE RESTORED TO ORIGINAL, INCLUDING KERBS, FOOTPATHS, CONCRETE AREAS, GRAVEL AND GRASSED AREAS AND ROAD PAVEMENTS.
11. PROVIDE 12mm WIDE EXPANDING CORK JOINTS BETWEEN CONCRETE PAVEMENTS AND ALL BUILDINGS, WALLS, FOOTINGS, COLUMNS, KERBS, DISHDRAINS, GRATED DRAINS, BOLLARD FOOTINGS ETC
12. CONTRACTOR TO OBTAIN ALL AUTHORITY APPROVALS.
13. ALL BATTERS TO BE GRASSED LINED WITH MINIMUM 100 TOPSOIL AND APPROVED COUCH LAID AS TURF.
14. MAKE SMOOTH TRANSITION TO EXISTING SERVICES AND MAKE GOOD.
15. THE CONTRACTOR SHALL PROVIDE ALL TEMPORARY DIVERSION DRAINS AND MOUNDS TO ENSURE THAT AT ALL TIMES EXPOSED SURFACES ARE FREE DRAINING AND WHERE NECESSARY EXCAVATE SUMPS AND PROVIDE PUMPING EQUIPMENT TO DRAIN EXPOSED AREAS.
16. ON COMPLETION OF WORKS ALL DISTURBED AREAS MUST BE RESTORED TO ORIGINAL INCLUDING, BUT NOT LIMITED TO, KERBS, FOOTPATHS, CONCRETE AREAS, GRASS AND LANDSCAPED AREAS.

EXISTING SERVICES AND FEATURES

1. EXISTING SERVICES HAVE BEEN PLOTTED FROM SUPPLIED SURVEY DATA AND AS SUCH THEIR ACCURACY CANNOT BE GUARANTEED. IT IS THE RESPONSIBILITY OF THE CONTRACTOR TO ESTABLISH THE LOCATION AND LEVEL OF ALL EXISTING SERVICES PRIOR TO THE COMMENCEMENT OF ANY WORK. ANY DISCREPANCIES SHALL BE REPORTED TO THE SUPERINTENDENT.
2. THE CONTRACTOR SHALL ALLOW FOR THE CAPPING OFF, EXCAVATION, REMOVAL AND DISPOSAL IF REQUIRED OF ALL EXISTING SERVICES IN AREAS AFFECTED BY WORKS WITHIN THE CONTRACT AREA, AS SHOWN ON THE DRAWINGS UNLESS DIRECTED OTHERWISE BY THE SUPERINTENDENT.
3. PRIOR TO COMMENCEMENT OF ANY WORKS THE CONTRACTOR SHALL GAIN WRITTEN APPROVAL OF HIS PROGRAMME FOR THE RELOCATION/CONSTRUCTION OF TEMPORARY SERVICES.
4. EXISTING BUILDINGS, EXTERNAL STRUCTURES, AND TREES SHOWN ON THESE DRAWINGS ARE FEATURES EXISTING PRIOR TO ANY DEMOLITION WORKS.
5. CLEARANCE AND COVER REQUIREMENTS SHALL BE OBTAINED FROM THE RELEVANT SERVICE AUTHORITY BEFORE COMMENCEMENT OF WORKS AND SHALL BE ADHERED TO AT ALL TIMES.
6. CARE IS TO BE TAKEN WHEN EXCAVATING NEAR EXISTING SERVICES. NO MECHANICAL EXCAVATIONS ARE TO BE UNDERTAKEN OVER TELECOM OR ELECTRICAL SERVICES. HAND EXCAVATE IN THESE AREAS ONLY.

EARTHWORKS NOTES

EW1 ALL WORK SHALL COMPLY WITH AS3798 (1996) - GUIDELINES ON EARTHWORKS FOR COMMERCIAL AND RESIDENTIAL DEVELOPMENTS.

EW2 AFTER DEMOLITION STRIP REMAINING TOPSOIL THROUGHOUT TO EXPOSE NATURALLY OCCURRING AND ENGINEERING MATERIAL AND STOCKPILE ON SITE FOR SELECTIVE REUSE OR DISPOSE OFF SITE AS DIRECTED BY THE SUPERINTENDENT.

EW3 EXCAVATE TO SUBGRADE LEVELS, SEGREGATING AND STOCKPILING MATERIALS FOR LATER REUSE FOR SELECTIVE REUSE OR DISPOSE OFF SITE AS DIRECTED BY THE SUPERINTENDENT.

EW4 PROOF ROLL ALL SOFT OR WET AREAS SHALL BE DRIED TO OPTIMUM MOISTURE AND RE-COMPACTED TO 95% MMD, WHERE MATERIAL IS DEEMED UNSUITABLE BY THE SUPERINTENDENT AND CANNOT BE USED ON SITE SHALL REMOVED FROM SITE.

EW5 ALL FILL MATERIAL SHALL BE FROM A SOURCE APPROVED BY THE SUPERINTENDENT AND SHALL COMPLY WITH THE FOLLOWING -

- a) FREE FROM ORGANIC AND PERISHABLE MATTER,
- b) MAXIMUM PARTICLE SIZE 75mm,
- c) PLASTICITY INDEX - BETWEEN 2% AND 15%.

EW6 ALL FILL MATERIAL SHALL BE PLACED IN MAXIMUM 200mm THICK LAYERS AND COMPACTED AT OPTIMUM MOISTURE CONTENT (+ OR - 2%) TO ACHIEVE A DRY DENSITY DETERMINED IN ACCORDANCE WITH AS1289.5.1.1-2003.METHODS OF TESTING SOILS FOR ENGINEERING PURPOSES OF NOT LESS THAN THE FOLLOWING STANDARD MINIMUM DRY DENSITY -

<u>LOCATION</u>	<u>STANDARD DRY DENSITY</u>
UNDER BUILDING SLABS	98%
VEHICULAR PAVED AREAS	100%
NON-VEHICULAR PAVED AREAS	98%
LANDSCAPED AREAS	95%

EW07 EXISTING SURFACE LEVEL SHOWN DOES NOT INCLUDE STRIPPING.

<u>GENERAL</u>			
1.	ALL WORKMANSHIP AND MATERIALS SHALL COMPLY WITH AS 3600 CURRENT EDITIONS WITH AMENDMENTS, AND THE ACSE CONCRETE SPECIFICATION EXCEPT WHERE VARIED BY THE CONTRACT DOCUMENTS.		
2.	VERIFY ALL SETTING OUT DIMENSIONS WITH THE SURVEYOR.		
3.	DO NOT OBTAIN DIMENSIONS BY SCALING THE DRAWINGS.		
4.	IN CASE OF DOUBT - ASK.		
<u>DESIGN LOADS</u>			
1.	80KN AXLE LOAD		
<u>CONCRETE</u>			
1.	PLACE CONCRETE OF THE FOLLOWING CHARACTERISTIC COMPRESSIVE STRENGTH F'C AS DEFINED IN AS 3600 OR M.R. FORM 609. ADD WATER REDUCING ADMIXTURE EQUAL TO WRDA.		
	LOCATION	AS 3600 F'c MPa AT 28 DAYS	SPECIFIED SLUMP
	ALL KERB PITTS ETC.	25	80
	VEHICULAR PAVEMENTS	32	80
			NOMINAL AGG. SIZE
			20
			20
2.	USE "A.C.S.E. SPECIFICATION TYPE A" CEMENT.		
3.	ALL CONCRETE SHALL BE SUBJECT TO PROJECT CONTROL SAMPLE AND TESTING TO AS 3600.		
4.	CONSOLIDATE BY VIBRATION.		
<u>REINFORCEMENT</u>			
1.	FIX REINFORCEMENT AS SHOWN ON DRAWINGS. THE TYPE AND GRADE IS INDICATED BY A SYMBOL AS SHOWN BELOW. ON THE DRAWING N IS FOLLOWED BY A NUMERAL WHICH INDICATES THE SIZE IN MILLIMETRES. A MARK NUMERAL (IF USED) FOLLOWS THIS NUMERAL. N. HOT ROLLED DEFORMED BAR, GRADE 410Y S. HOT ROLLED DEFORMED BAR, GRADE 230S R. PLAIN ROUND BAR, GRADE 230R SL. HARD DRAWN WIRE FABRIC.		
2.	PROVIDE BAR SUPPORTS OR SPACERS TO GIVE THE FOLLOWING CONCRETE COVER TO ALL REINFORCEMENT UNLESS NOTED OTHERWISE.		
	FOOTINGS		
	- 75 BOTTOM, 65 TOP AND SIDES SLABS		
	- 20 TOP AND BOTTOM, 30 WHEN EXPOSED TO WEATHER.		
	BEAMS		
	- 50 BOTTOM AND SIDES (TO STIRRIPS) TOP COVER AS DETAILED COLUMNS		
	- 40 TO TIES AND SPIRALS 50 WHEN EXPOSED TO WEATHER		
	WALLS		
	- 25 GENERALLY 30 WHEN CAST IN FORMS BUT LATER EXPOSED TO WEATHER OR GROUND.		
	- 65 WHEN CAST DIRECTLY IN CONTACT WITH GROUND.		
<u>CURING</u>			
1.	CURE ALL CONCRETE IN ACCORDANCE TO THE METHOD PROVIDED IN THE SPECIFICATION.		

JOINTING NOTES

VEHICULAR PAVEMENT JOINTING

- ALL VEHICULAR PAVEMENT TO BE JOINTED AS SHOWN ON DRAWINGS.
- KEYED CONSTRUCTION JOINTS SHOULD GENERALLY BE LOCATED AT A MAXIMUM OF 6m CENTRES.
- SAWN JOINTS SHOULD GENERALLY BE LOCATED AT A MAXIMUM OF 6m CENTRES OR 1.5 x THE SPACING OF KEYED JOINTS, WHERE KEY JOINT SPACING IS LESS THAN 4m, WITH DOWELED EXPANSION JOINTS AT MAXIMUM OF 30m CENTRES.
- PROVIDE 10mm WIDE FULL DEPTH ISOLATION JOINTS BETWEEN BUILDINGS AND ALL CONCRETE OR UNIT PAVERS.
- VEHICULAR PAVEMENT JOINTING AS FOLLOWS.

C11	DEJ	C11	FACE OF KERB	C11	DEJ	C11
			C11			
		6m MAX		6m MAX		
			30m MAX			

EDGE OF BUILDING

- WHERE DOWELED JOINTS INTERSECT REMOVE DOWELS FROM LAST 1500mm FROM JOINT IN DIRECTION OF POUR.

The diagram shows a cross-section of a joint. A vertical line represents the joint. To the left of the joint, there are three horizontal lines representing dowels. To the right of the joint, there are three horizontal lines representing dowels. A dimension line indicates that the dowels are to be removed from the last 1500mm of the joint in the direction of pour.

SUBSOIL DRAINAGE NOTES

1. DN100 SLOTTED uPVC SUBSOIL DRAINAGE WRAPPED IN GEOFABRIC SHALL BE PROVIDED IN THE FOLLOWING LOCATIONS AND CONNECTED TO THE SITE STORMWATER DRAINAGE SYSTEM (U.N.O):
 - i) UNDER KERBS ADJACENT TO ALL PAVEMENTS
 - ii) AT THE BASE OF THE HIGH SIDE OF ALL RETAINING WALLS

COMPACTION NOTES	
1. STRIP TOPSOIL TO EXPOSE NATURALLY OCCURRING MATERIAL AND STOCKPILE ON SITE FOR SELECTIVE RE-USE OR DISPOSE OFF-SITE AS DIRECTED BY THE SUPERINTENDENT.	
2. WHERE FILLING IS REQUIRED TO ACHIEVE DESIGN SUBGRADE PROOF ROLL EXPOSED NATURAL SURFACE WITH A MINIMUM OF TEN PASSES OF A VIBRATING ROLLER (MINIMUM STATIC WEIGHT OF 10 TONNES) IN THE PRESENCE OF THE SUPERINTENDENT. REFER TO SPECIFICATION FOR DETAILS.	
3. ALL SOFT, WET OR UNSUITABLE MATERIAL TO BE REMOVED AS DIRECTED BY THE SUPERINTENDENT AND REPLACED WITH APPROVED MATERIAL SATISFYING THE REQUIREMENTS LISTED BELOW.	
4. ALL FILL MATERIAL SHALL BE PLACED IN A SOURCE APPROVED BY THE SUPERINTENDENT AND SHALL COMPLY WITH THE FOLLOWING :	
a. FREE FROM ORGANIC, PERISHABLE AND CONTAMINATED MATTER	
b. MAXIMUM PARTICLE SIZE 75MM	
c. PLASTICITY INDEX BETWEEN 2% AND 15%	
5. ALL FILL MATERIAL SHALL BE PLACED IN MAXIMUM 200MM THICK LAYERS AND COMPACTED AT OPTIMUM MOISTURE CONTENT (+ OR - 2%) TO ACHIEVE A DRY DENSITY DETERMINED IN ACCORDANCE WITH AS 1289 E3.1 OF NOT LESS THAN THE FOLLOWING STANDARD MINIMUM DRY DENSITY IN ACCORDANCE WITH AS 1289 E1.1 :	
<u>LOCATION</u>	<u>STANDARD DRY DENSITY</u>
UNDER PAVED SLABS	98%
AREAS OF SERVICE TRENCHES	98%
EXTERNAL PAVED AREAS, ROADS AND CARPARKS	98%
LANDSCAPED AREAS	90%
6. THE CONTRACTOR SHALL PROGRAM THE EARTHWORKS OPERATION SO THAT THE WORKING AREAS ARE ADEQUATELY DRAINED DURING THE PERIOD OF CONSTRUCTION. THE SURFACE SHALL BE GRADED AND SEALED OFF TO REMOVE DEPRESSIONS. ROLLER MARKS AND SIMILAR WHICH WOULD ALLOW WATER TO POND AND PENETRATE THE UNDERLYING MATERIAL. ANY DAMAGE RESULTING FROM THE CONTRACTOR NOT OBSERVING THESE REQUIREMENTS SHALL BE RECTIFIED BY THE CONTRACTOR AT THEIR COST.	
7. TESTING OF THE SUBGRADE SHALL BE CARRIED OUT BY AN APPROVED NATA REGISTERED LABORATORY AT THE CONTRACTORS EXPENSE.	

STORMWATER NOTES

1. ALL Ø300mm to Ø600mm DRAINAGE PIPES SHALL BE CLASS 4 APPROVED SPIGOT AND SOCKET REINFORCED CONCRETE PIPES WITH RUBBER RING JOINTS (UNO). ALL Ø675mm OR LARGER DRAINAGE PIPES SHALL BE CLASS 3 APPROVED SPIGOT AND SOCKET REINFORCED CONCRETE PIPES WITH RUBBER RING JOINTS (UNO).
2. ALL DRAINAGE PIPES LESS THAN OR EQUAL TO Ø225mm SHALL BE uPVC DWV GRADE CLASS SN8 IN ACCORDANCE WITH AS/NZS1260:2009-PVC-U PIPES AND FITTINGS FOR DRAIN, WASTE AND VENT APPLICATION WITH SOLVENT WELDED JOINTS.
3. EQUIVALENT STRENGTH FIBROUS REINFORCED CONCRETE AND/OR VITRIFIED CLAY PIPE MAY BE USED SUBJECT TO APPROVAL BY THE SUPERINTENDENT.
4. PIPES FOR SUB-SOIL DRAINS SHALL BE SLOTTED 100MM DIAMETER CLASS 1000 WRAPPED IN GEOFABRIC, UNO, COMPLYING WITH THE REQUIREMENTS OF AS 2439
5. ALL PIPE JUNCTIONS UP TO AND INCLUDING 450 DIA. AND TAPERS SHALL BE VIA PURPOSE MADE FITTINGS.
6. ALL MID STEEL FIXTURES INCLUDING GRATES, FRAMES, STEP IRONS, LADDERS, ETC., SHALL BE HOT DIP GALVANISED. GALVANISING SHALL COMPLY WITH THE REQUIREMENTS OF AS 1214 OR AS 1650, AS APPROPRIATE.
7. MINIMUM GRADE TO STORMWATER LINES TO BE 1%. (U.N.O.)
8. CONTRACTOR TO SUPPLY AND INSTALL ALL FITTINGS AND SPECIALS INCLUDING VARIOUS PIPE ADAPTORS TO ENSURE PROPER CONNECTION BETWEEN DISSIMILAR PIPEWORK.
9. ALL CONNECTIONS TO EXISTING DRAINAGE PITS SHALL BE MADE IN A TRADESMAN-LIKE MANNER AND THE INTERNAL WALL OF THE PIT AT THE POINT OF ENTRY SHALL BE CEMENT RENDERED TO ENSURE A SMOOTH FINISH.
10. PRECAST PITS SHALL NOT BE USED UNLESS WRITTEN APPROVAL IS OBTAINED FROM THE SUPERINTENDENT.
11. WHERE TRENCHES ARE IN ROCK, THE PIPE SHALL BE BEDDED ON A MIN. 50MM CONCRETE BED (OR 75MM THICK BED OF 12MM BLUE METAL) UNDER THE BARREL OF THE PIPE. THE PIPE COLLAR AT NO POINT SHALL BEAR ON THE ROCK. IN OTHER THAN ROCK, PIPES SHALL BE LAID ON A 75MM THICK SAND BED. IN ALL CASES BACKFILL THE TRENCH WITH SAND TO 200MM ABOVE THE PIPE. WHERE THE PIPE IS UNDER PAVEMENTS BACKFILL REMAINDER OF TRENCH WITH SAND OR APPROVED GRANULAR BACKFILL COMPACTED IN 150MM LAYERS TO 98% STANDARD MAX. DRY DENSITY.
12. BEDDING SHALL BE (U.N.O.) TYPE H1, IN ACCORDANCE WITH CURRENT RELEVANT AUSTRALIAN STANDARDS.
13. BACKFILL TRENCH WITH SAND OR APPROVED GRANULAR BACKFILL TO 300mm(MIN) ABOVE THE PIPE. WHERE THE PIPE IS UNDER PAVEMENTS BACKFILL REMAINDER OF TRENCH TO PAVEMENT SUBGRADE WITH SAND OR APPROVED GRAVEL SUB-BASE COMPACTED IN 150mm LAYERS TO 98% STANDARD MAXIMUM DRY DENSITY. THE CONTRACTOR IS TO ENSURE COMPACTION EQUIPMENT IS APPROPRIATE FOR THE PIPE CLASS USED
14. WHERE STORMWATER LINES PASS UNDER FLOOR SLABS DWV GRADE uPVC RUBBER RING JOINTS ARE TO BE USED (UNO).
15. WHERE SUBSOIL DRAINAGE LINES PASS UNDER FLOOR SLABS AND VEHICULAR PAVEMENTS, UNSLOTTED uPVC DWV GRADE CLASS SN8 PIPE SHALL BE USED.
16. 100mm DIA. SUBSOIL DRAINAGE PIPE 3m LONG WRAPPED IN FILTER SOCK TO BE PROVIDED IN PIPE TRENCHES UPSTREAM OF ALL PITS.
17. CONTRACTOR TO SUPPLY AND INSTALL ALL FITTINGS AND SPECIALS INCLUDING VARIOUS PIPE ADAPTORS TO ENSURE PROPER CONNECTION BETWEEN DISSIMILAR PIPEWORK.
18. PITS DEEPER THAN 1000mm SHALL HAVE ACCESS LADDERS OR STEP IRONS INSTALLED AND SHALL BE IN ACCORDANCE WITH THE LOCAL OR STATUTORY AUTHORITY REQUIREMENTS
19. ALL FRAMES, COVERS AND GRATINGS FOR PITS, SUMPS, DRAINS, GRATED DRAINS ETC MUST BE PROVIDED TO SUIT CLASS D DUTIES AND ALL GRATES SHALL BE SLIP RESISTANT AND HEELGUARD UNO
20. WHERE A PIT IS IDENTIFIED AS A CONFINED SPACE, PIT COVERS SHALL BE PROVIDED WITH STANDARD CONFINED SPACE SIGNAGE
21. SUBSOIL DRAINAGE LINES SHALL BE INSTALLED AT THE BASE OF ALL RETAINING WALLS AND FOR ALL STORMWATER PITS. ALL SUBSOIL LINES SHALL BE CONNECTED TO DRAIN TO THE STORMWATER DRAINAGE SYSTEM
22. CAPPED FLUSHING POINTS MUST BE PROVIDED FOR ALL SUBSOIL AND SEEPAGE DRAINAGE SYSTEMS AT THE END OF EACH PIPE, AT 30M SPACING AND AT CHANGES IN DIRECTIONS
23. INSPECTION OPENINGS AND CLEAROUTS MUST BE PROVIDED AT EVERY JUNCTION, BEND, CHANGE OF DIRECTION AND AT THE BASE OF ALL DOWNPIPS IMMEDIATELY ABOVE WHERE THE DOWNPIPE PENETRATES THE GROUND OR SLAB ON GROUND
24. ALL SUBSOIL PIPES SHALL BE FACTORY SLOTTED HDPE, MINIMUM 100MM DIAMETER SN8 CLASS, SIMILAR OR EQUAL TO WINDEX DRAINCOIL, CERTIFIED uPVC, IN ACCORDANCE WITH AS1260, AS2032 (PIPE) & AS3789 (JOINTING) INSTALLED ON GEOTEXTILE FABRIC WITH 150MM SURROUND OF 25MM BLUE METAL AGGREGATE. UNO



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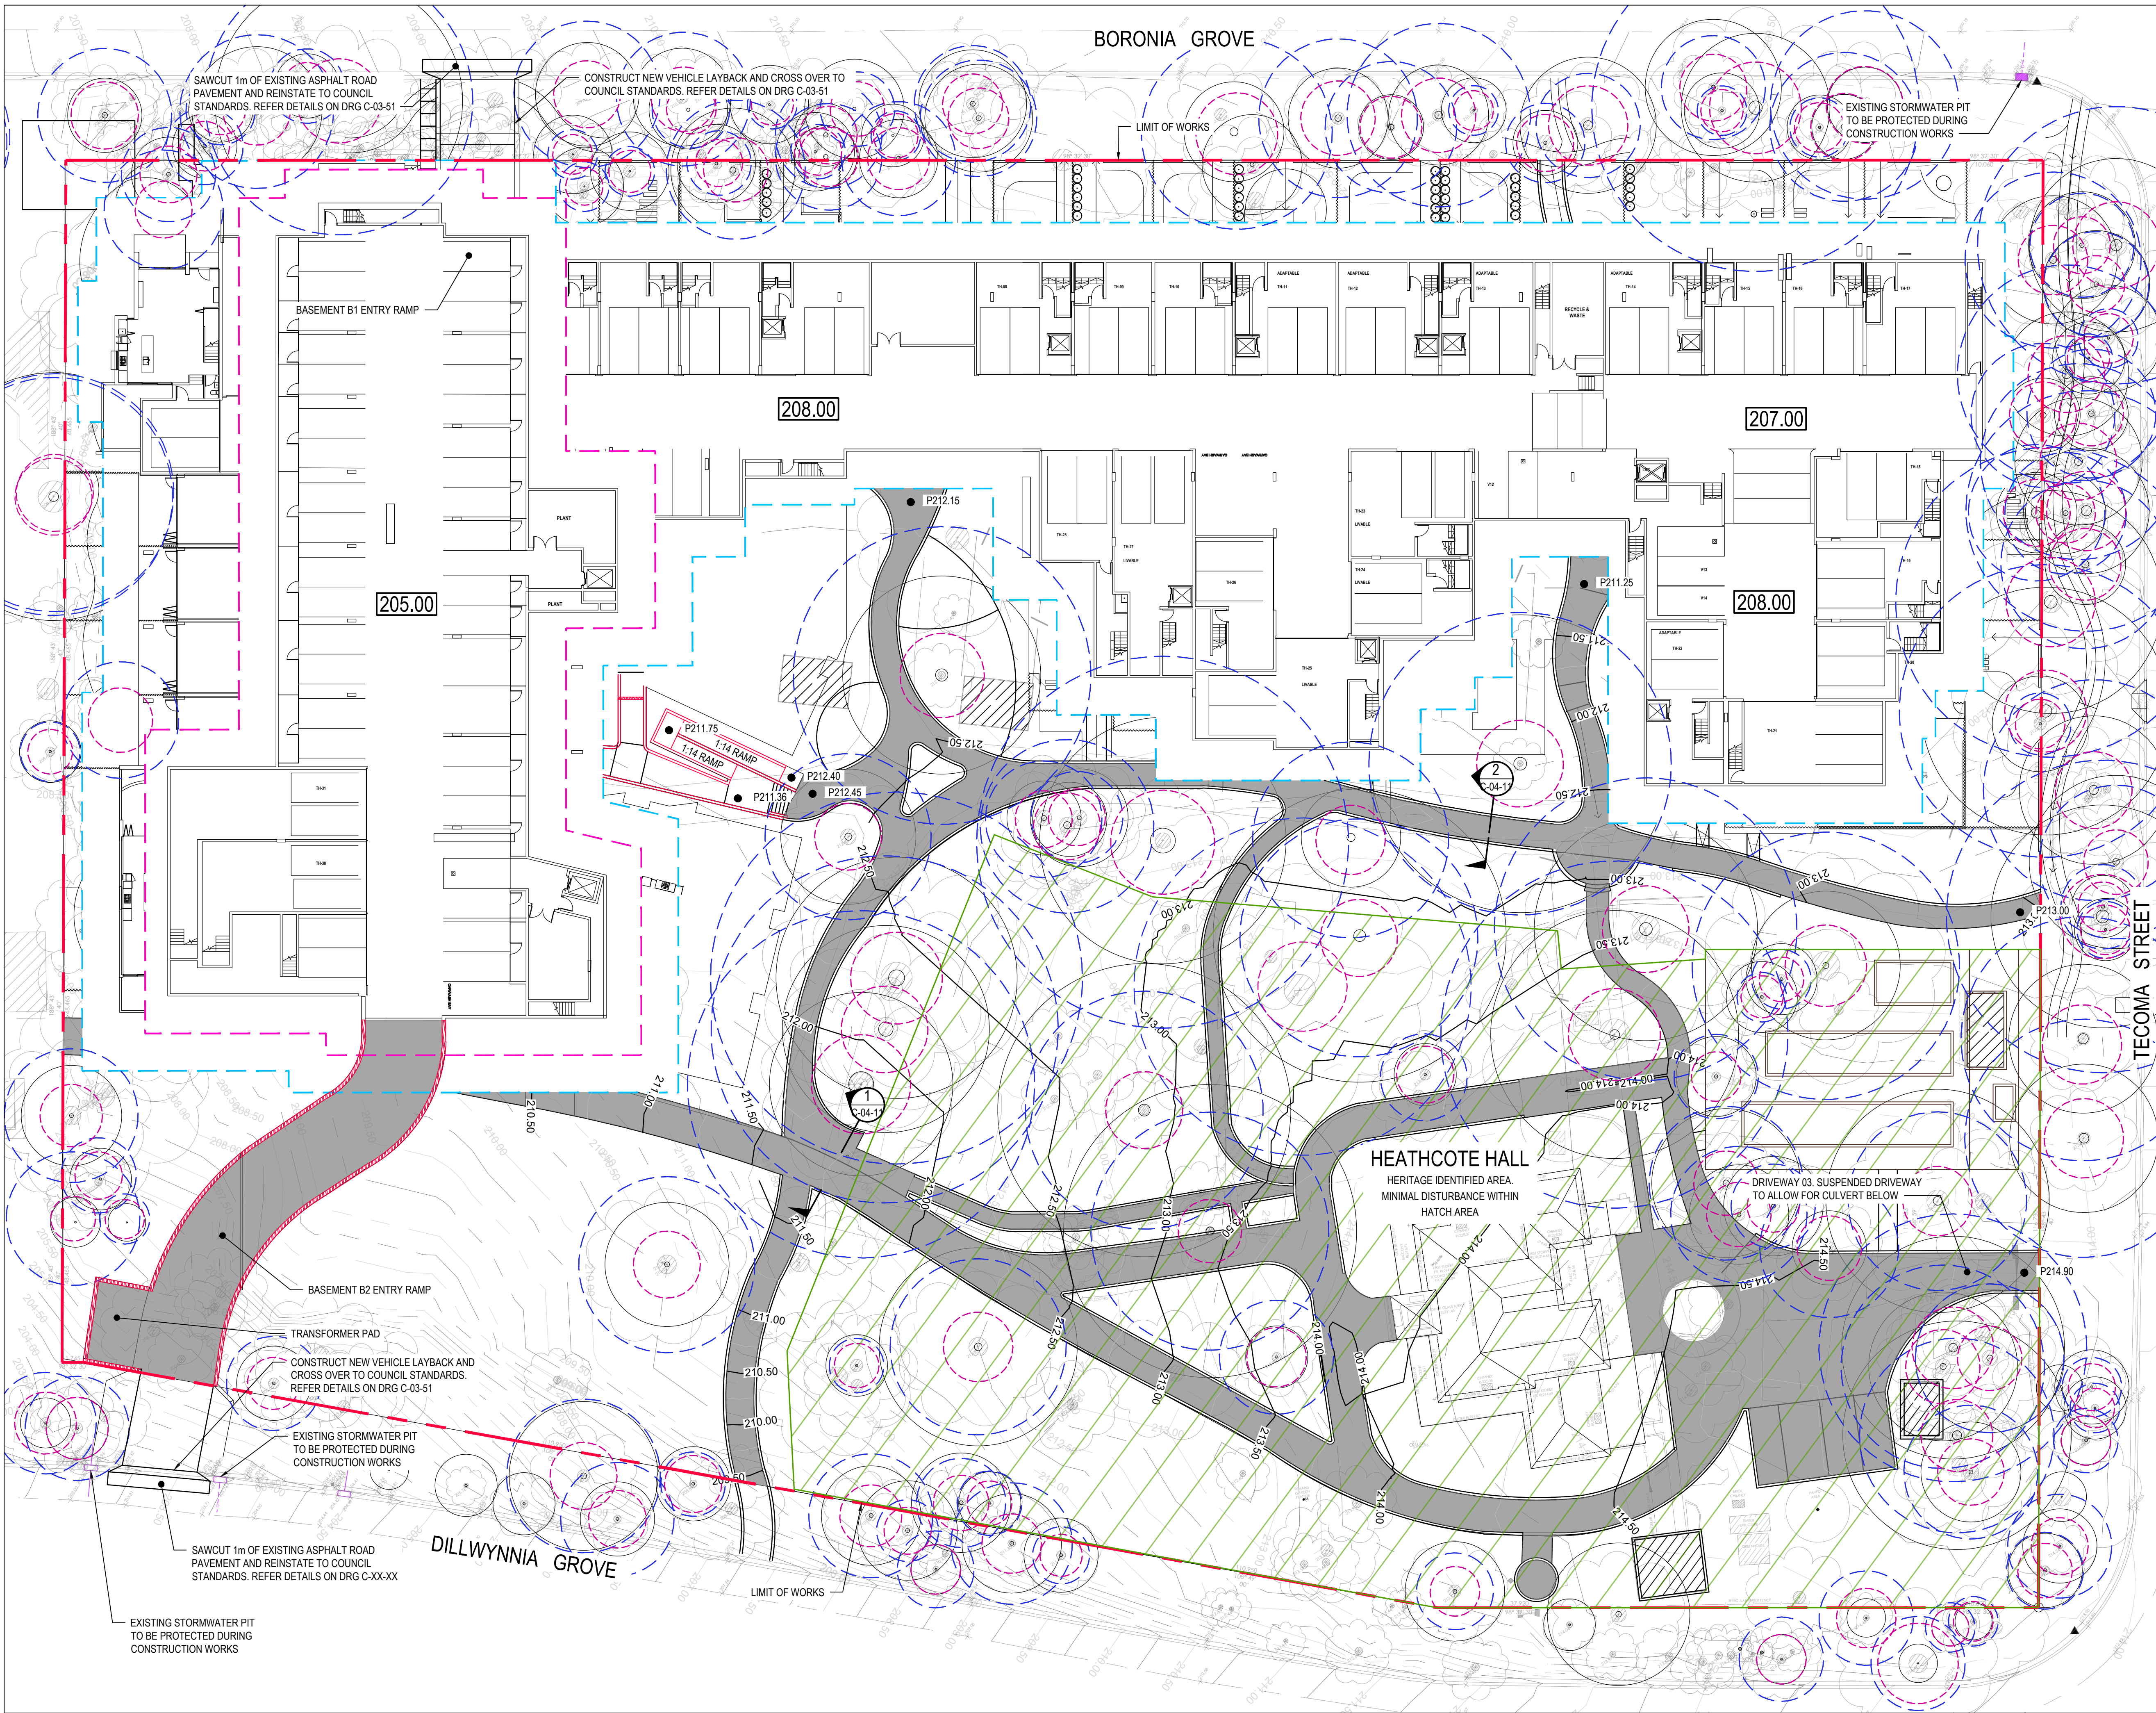
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03	ISSUED FOR TENDER	10.12.20
02	ISSUED FOR INFORMATION	27.11.20
01	ISSUED FOR INFORMATION	23.11.20
Rev	Revision Description	Date



Title
SPECIFICATION NOTES

Drawn JE	Checked BK	Approved JC
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Project Number	Drawing Number	Revision
S201117	C-01-02	04



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Client
PARITER PTY LTD

Project
**HEATHCOTE GROUNDS
MAIN WORKS**


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**SITWORKS AND GRADING
PLAN**

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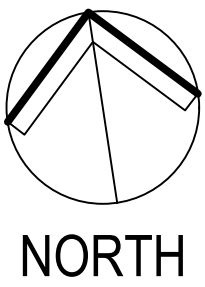
Drawn JE	Checked BK	Approved JC	Revision 04
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Project Number
S201117

Drawing Number
C-03-01



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PAVEMENT LEGEND	
	PAVEMENT TYPE 1 CONCRETE PAVEMENT (NON TRAFFICABLE)
	PAVEMENT TYPE 2 CONCRETE PAVEMENT (TRAFFICABLE)
	PAVEMENT TYPE 2A RED BRICK
	PAVEMENT TYPE 3 DECO GRAVEL
	PAVEMENT TYPE 4 MULCH
	PAVEMENT TYPE 6 ASPHALT

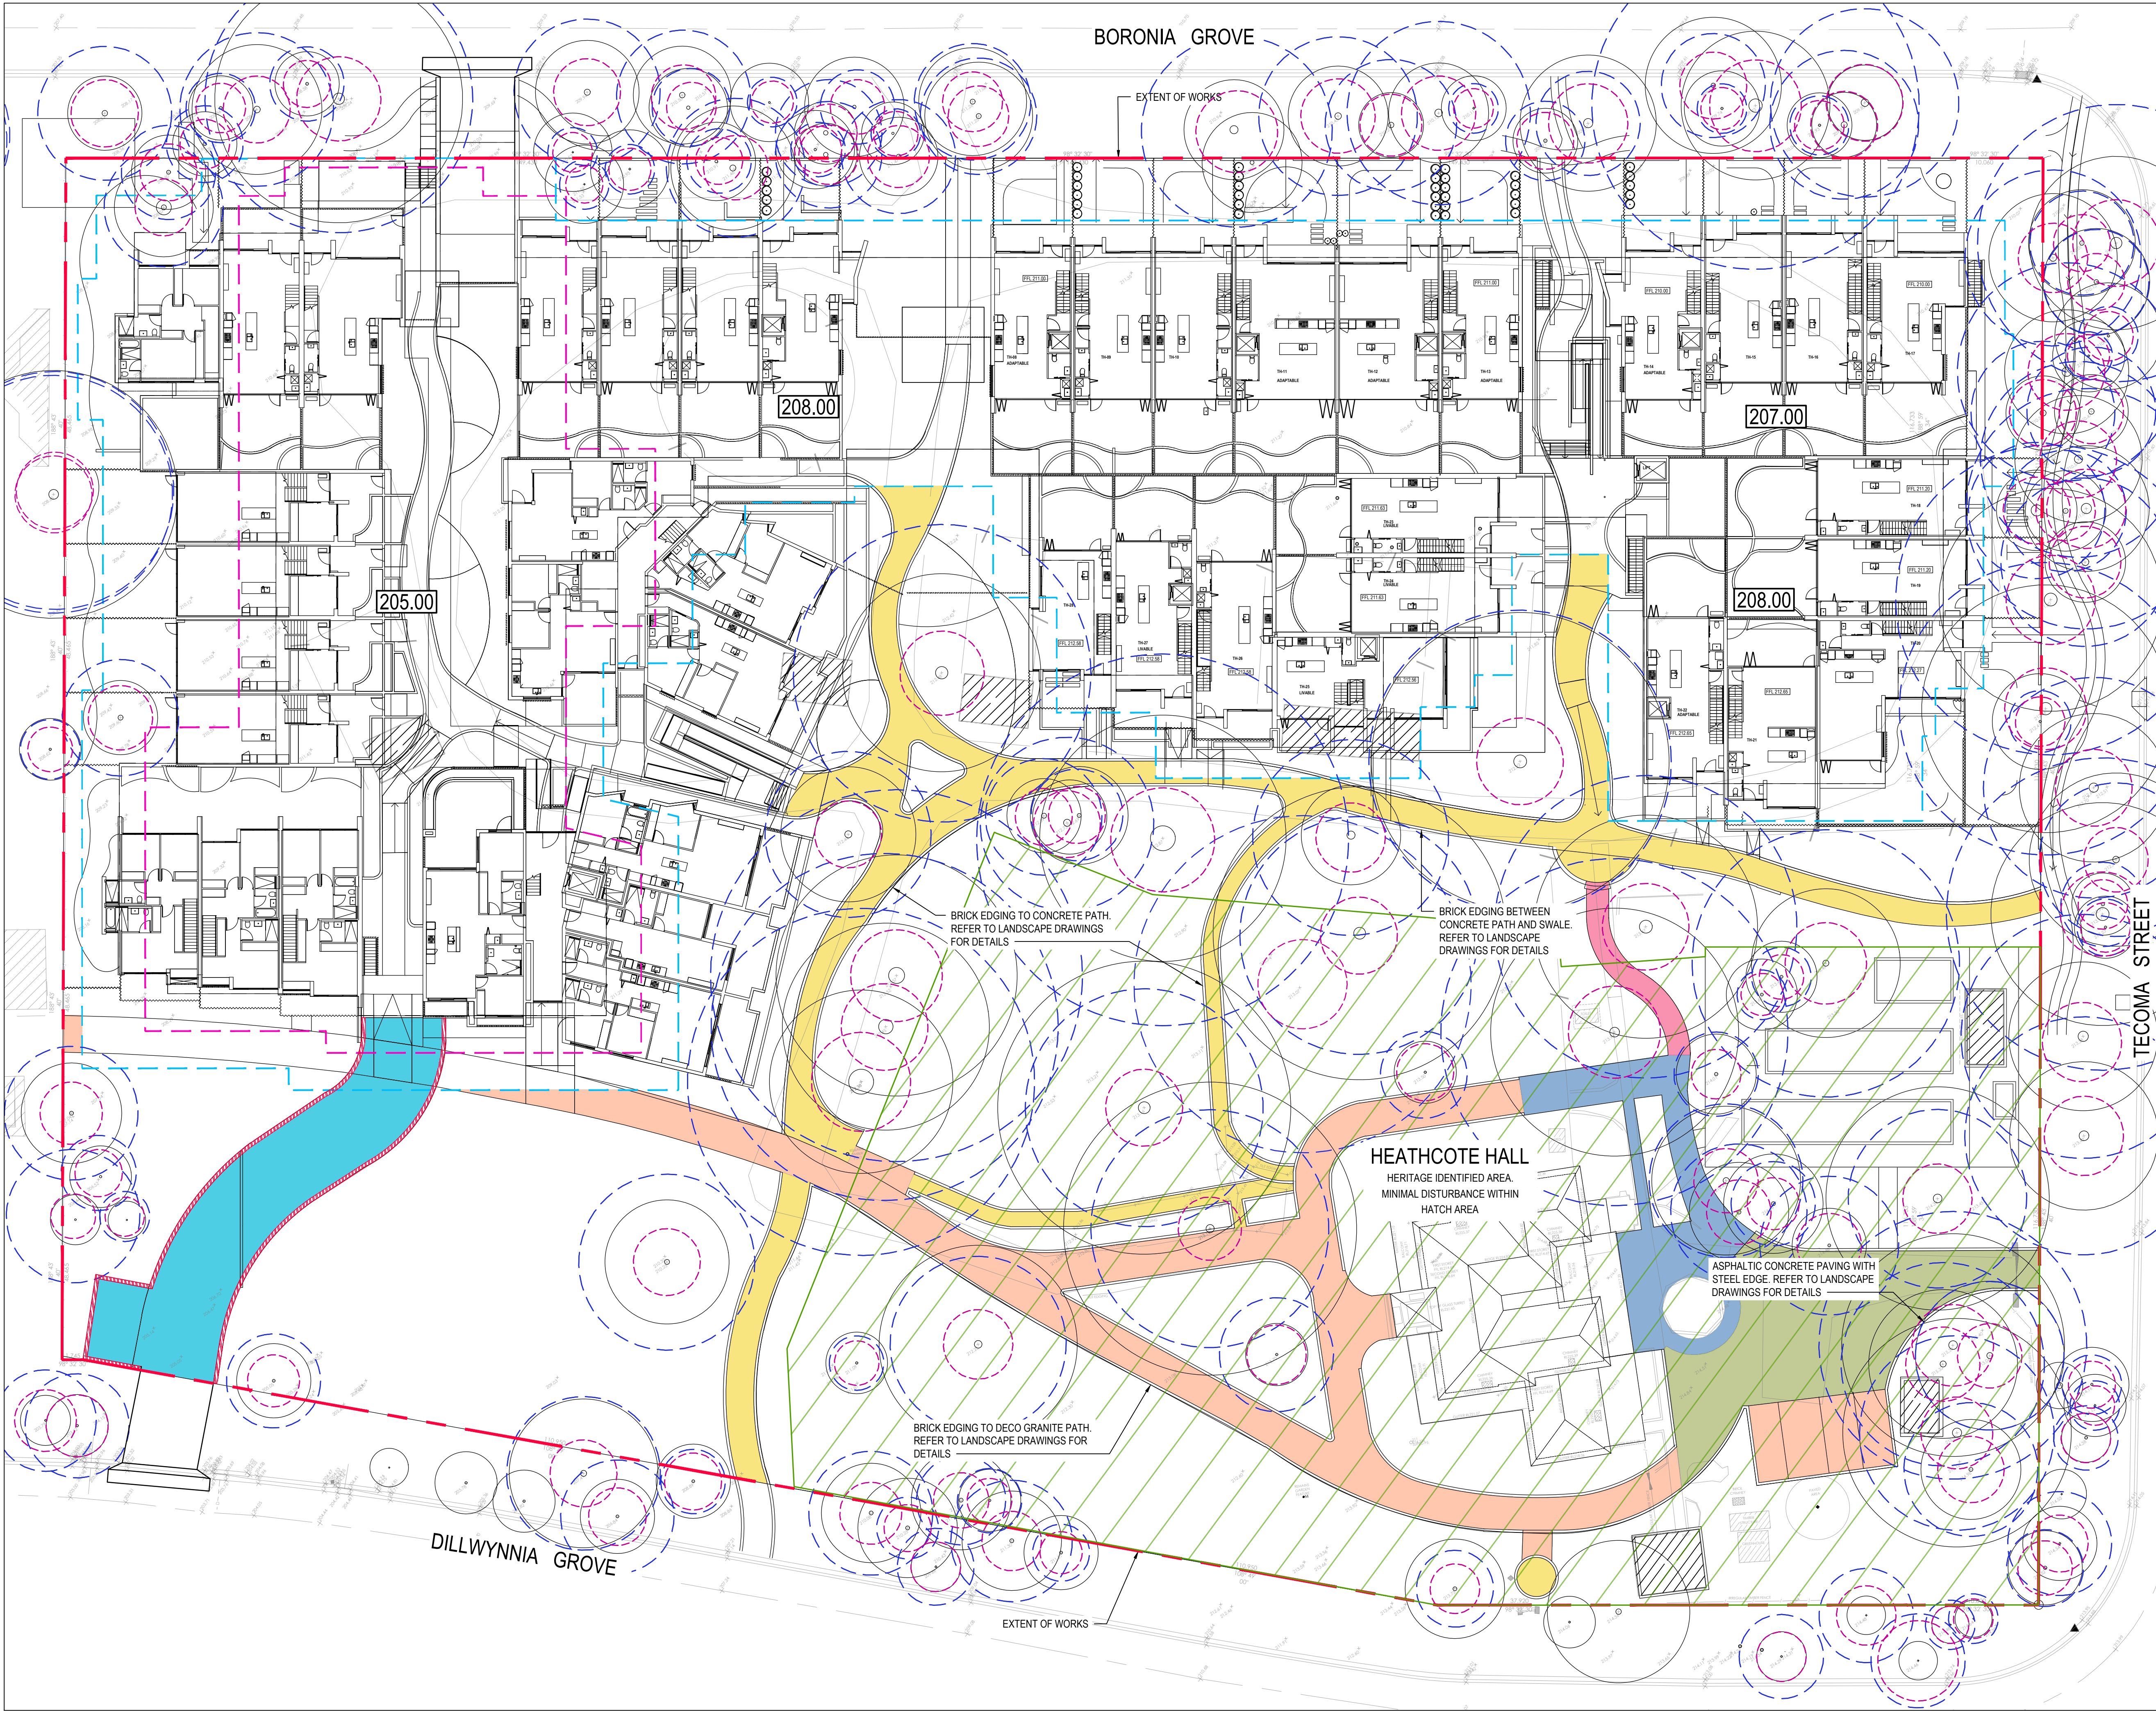Rev	Revision Description	Date
04	ISSUED FOR TENDER	16.12.20
03	ISSUED FOR TENDER	10.12.20
02	ISSUED FOR TENDER	27.11.20
01	ISSUED FOR INFORMATION	23.11.20



engineers
and development
consultants


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Client
PARITER PTY LTD

Project
**HEATHCOTE GROUNDS
MAIN WORKS**

Title
PAVEMENT PLAN



Drawn	Checked	Approved	Revision
JE	BK	JC	04
Project Number S201117	Drawing Number C-03-11		
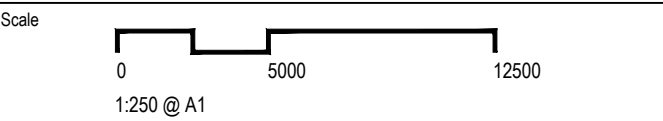
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HEATHCOTE HALL

1-21 Dillwynnia Grove Heathcote NSW

S4.55 DEVELOPMENT APPLICATION

- GENERAL NOTES
- THIS PACKAGE IS TO BE READ IN CONJUNCTION WITH ARCHITECTURE, CIVIL, STRUCTURAL, HYDRAULIC AND SERVICES CONSULTANTS DOCUMENTATION, AND ANY OF THE FOLLOWING REPORTS SPECIFIC TO THIS PROJECT: ACCESS, ARBORIST, BASIX, ELECTRICAL
 - REFER TO ARBORISTS REPORT FOR ALL DETAILED TREE INFORMATION
 - TO BE READ IN CONJUNCTION WITH THE SITE DESIGN DEVELOPMENT APPLICATION DA17/0467

DRAWING LIST

- LA-01 - COVER SHEET
- LA-02 - SITE CALCULATIONS
- LA-03 - LANDSCAPE MASTER PLAN
- LA-04 - OVERALL PLAN-LEVELS & GRADING
- LA-05 - LANDSCAPE DEVELOPMENT CHANGES
- LA-06 - CONCEPT DETAILS
- LA-07 - MATERIALS AND FINISHES
- LA-08 - TREE REMOVAL AND RETENTION PLAN
- LA-09 - EXISTING TREE PROTECTION ZONES
- LA-10 - PLANTING AREAS
- LA-11 - PLANT SCHEDULE
- LA-12 - SECTIONS ONE
- LA-13 - SECTIONS TWO
- LA-14 - SECTIONS THREE
- LA-15 - FENCING
- LA-16 - FENCING DETAILS SHEET ONE
- LA-17 - FENCING DETAILS SHEET TWO
- LA-18 - FENCING DETAILS SHEET THREE
- LA-19- FENCING DETAILS SHEET FOUR
- LA-20- FENCING DETAILS SHEET FIVE
- LA-21- FENCING DETAILS SHEET SIX



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	A	15/01/2021	S4.55 DEVELOPMENT APPLICATION		MD																				
							ARCHITECT	<div>DesignInc</div> <div>DesignInc Sydney Pty Ltd</div> <div>Level 12, 77 Pacific Highway</div> <div>North Sydney NSW 2060 Australia</div> <div>+61 2 8985 7100</div> <div>sydney@designinc.com.au</div>			CLIENT	PARITER			PROJECT	HEATHCOTE GROUNDS			TITLE	LANDSCAPE PACKAGE			<div><div><div>N</div><div>1</div><div>2</div><div>3</div><div>4</div></div><div>DRAWN BY</div><div>SP</div><div>1:200 @ A0</div><div>PLOT DATE</div><div>20 January 2021</div><div>PROJECT Nº.</div><div>P20-056</div><div>REVISION</div><div>A</div><div>DRAWING Nº.</div><div>LA-01</div><div>DRAWING STATUS</div><div>REVIEWED BY</div><div>MD</div><div>SIGNATURE</div><div></div><div>DATE</div><div></div></div> <div>S4.55 DEVELOPMENT APPLICATION</div>		
										1-21 DILLWYNNIA GROVE,			COVER SHEET												
										HEATHCOTE,															
										SUTHERLAND 2233 NSW															
	<div><div><div>METERS</div><div>02410</div></div><div>1:200</div></div>																								



COMMUNAL GATED OPEN SPACE
COMMUNAL OPEN SPACE
(UNFENCED/UNGATED)
PRIVATE OPEN SPACE

TOTAL SITE AREA
15502 m²


- PRIVATE OPEN SPACE
3812 m²
- GATED COMMUNAL OPEN SPACE COMPRISING OPEN
LAWN, SELECTED SEATING OPTIONS AND BBQ AREAS
964 m²
- COMMUNAL OPEN SPACE COMPRISING AREAS OF OPEN
LAWN, PATHS, REVEGETATION AREA AND GARDENS
4342 m²
- HERITAGE GARDENS
5092 m²

NOTE: ALL LANDSCAPED AREAS HAVE BEEN REVISED IN
CONJUNCTION WITH REVISED ARCHITECTURAL DESIGN



MAINS WATER REQUIREMENTS

- COMMUNAL OPEN SPACE AREAS AND
PRIVATE PLANTER BOXES ON SLAB
MUST BE PROVIDED WITH WATER
IRRIGATION AND TAPS AT 25m
CENTRES, CONNECTED TO A PUMP
OR RAINWATER TANK

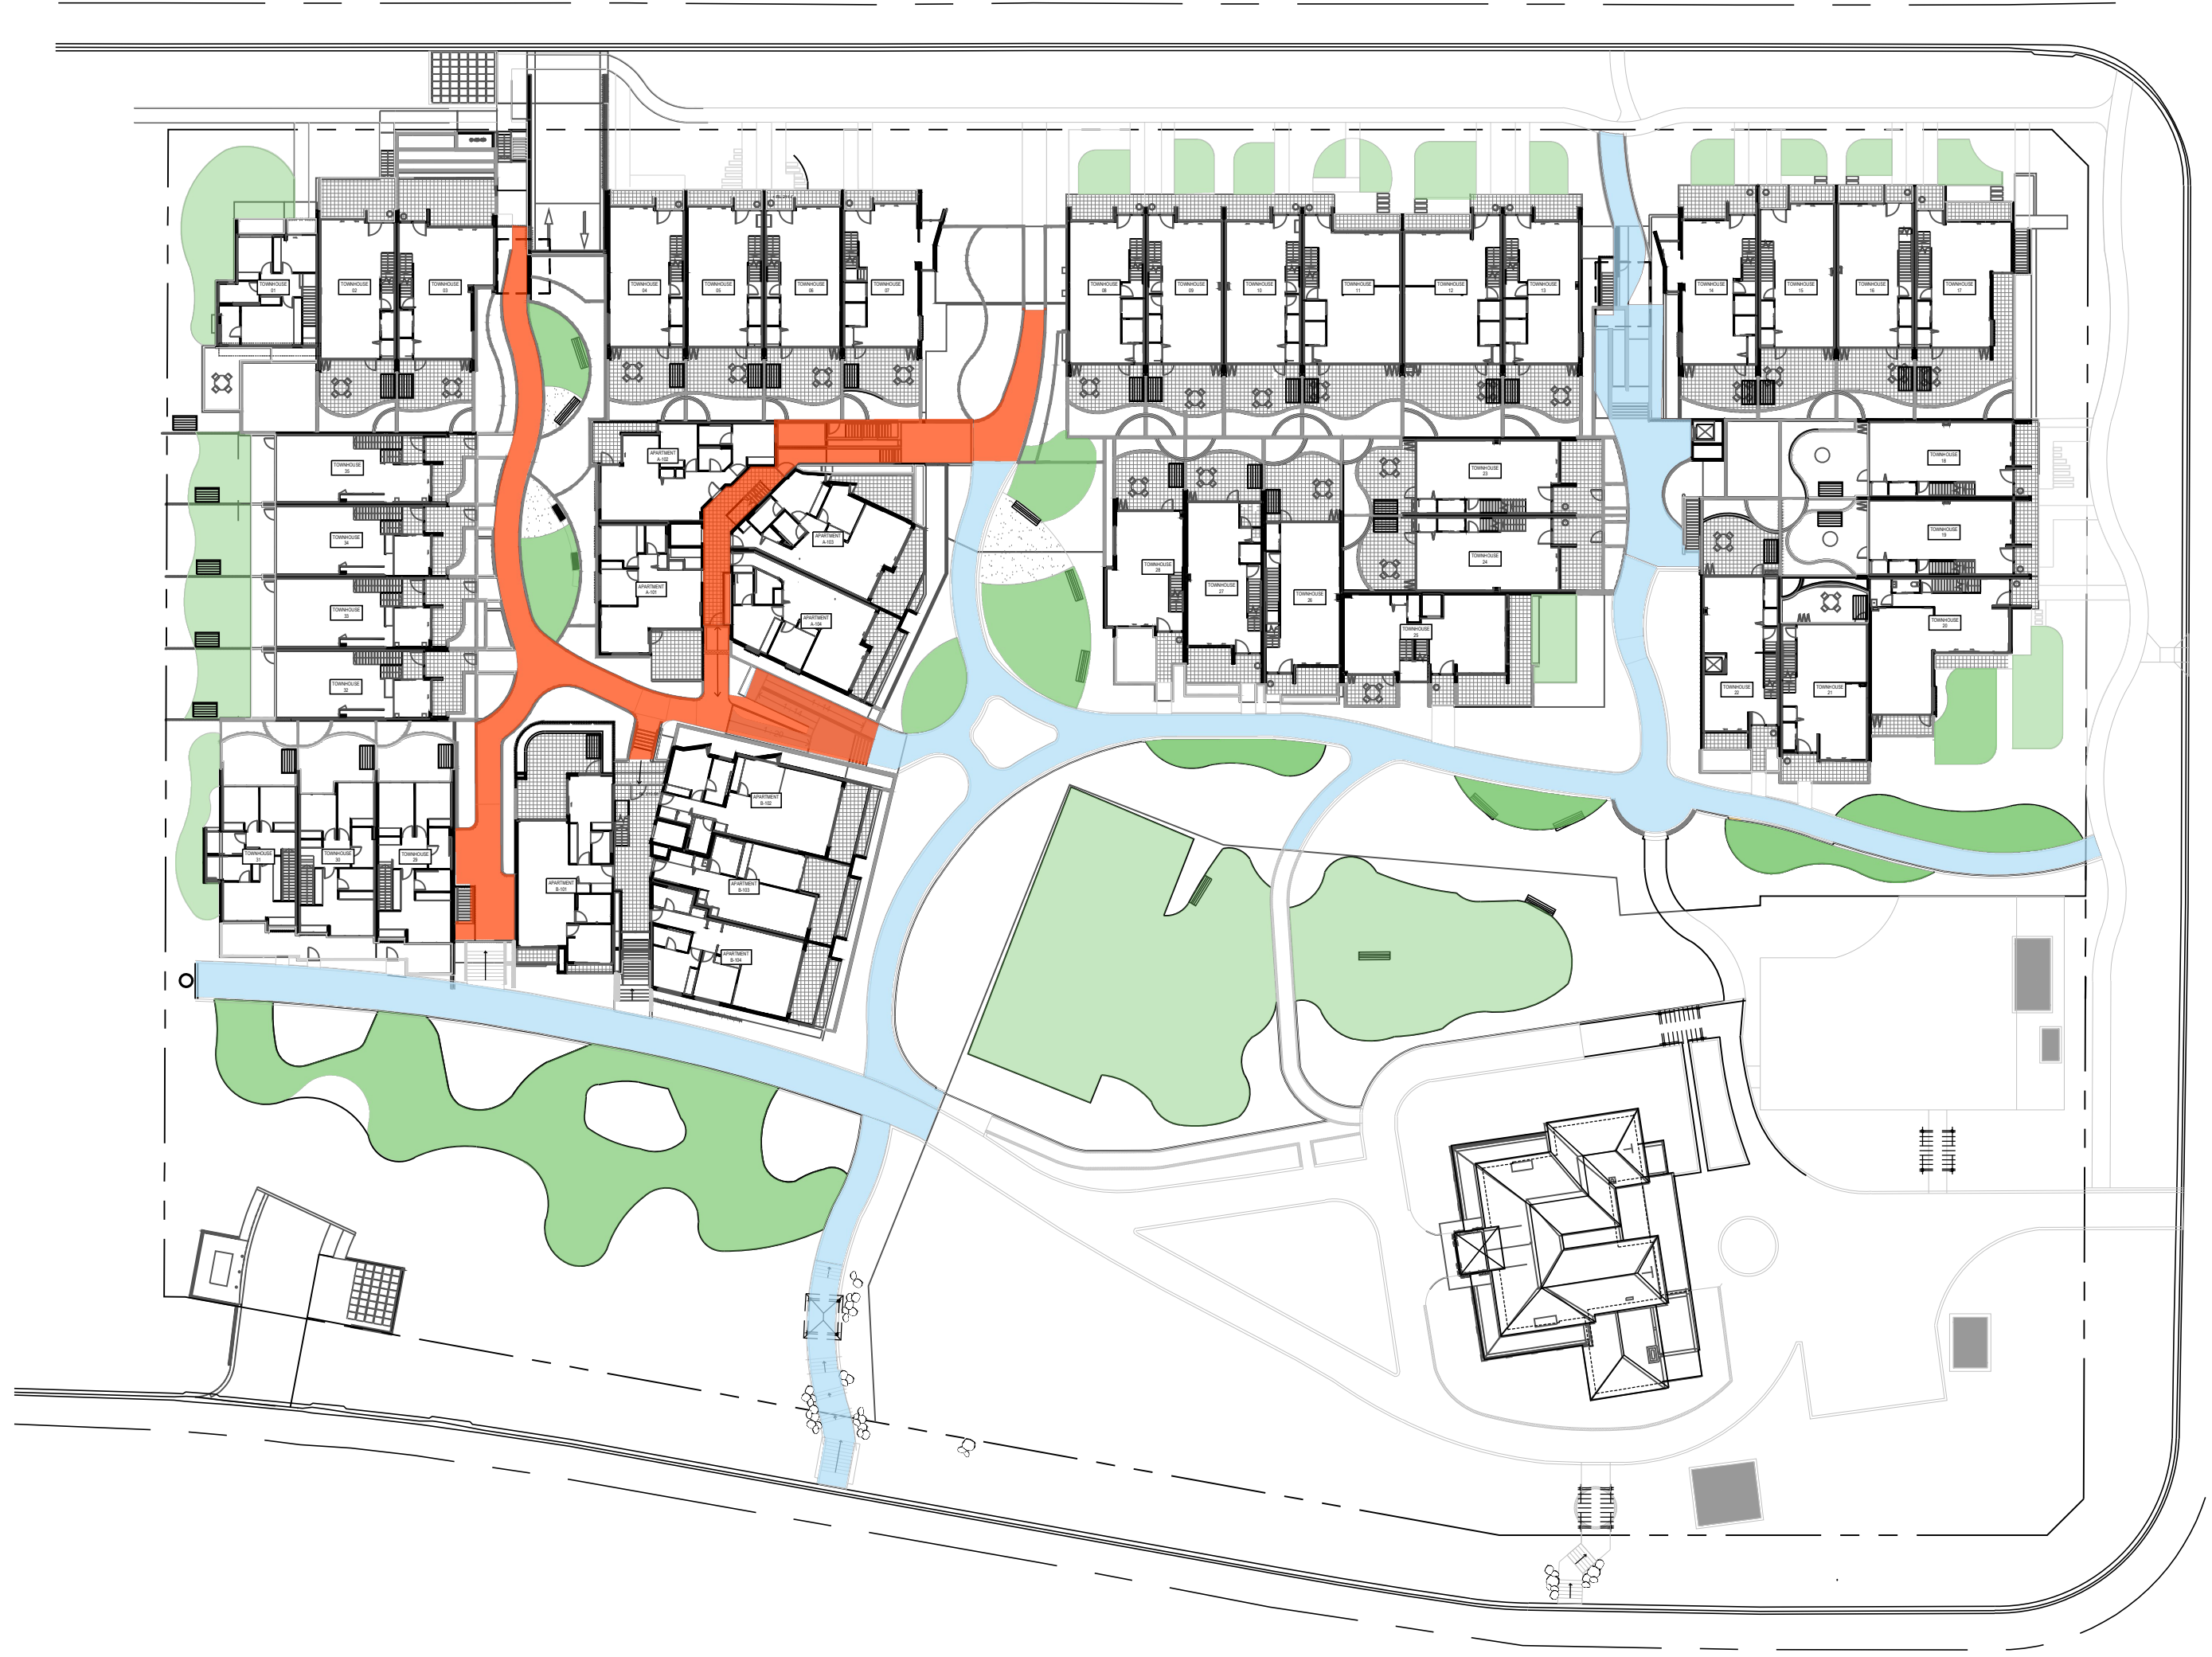

PATH SYSTEM / COMMUNAL
OPEN SPACE

- COMMUNAL SPACE NOT GATED COMPRISING
OF OPEN AREAS AND SELECTED SEATING
OPTIONS
- GATED COMMUNAL PATH AREAS
- COMMUNAL PATHS OUTSIDE GATED AREA

NOTE: ALL LANDSCAPED AREAS HAVE BEEN REVISED IN
CONJUNCTION WITH REVISED ARCHITECTURAL DESIGN



DEEP SOIL GARDEN AREA


- DEEP SOIL GARDEN AREAS 29 %
4910 m² (Outside heritage area)
- HERITAGE LANDSCAPE AREA 23%
3593 m²

BASEMENT 51%

NOTE: ALL LANDSCAPED AREAS HAVE BEEN REVISED IN
CONJUNCTION WITH REVISED ARCHITECTURAL DESIGN

No	DATE	REVISIONS	BY
A	15/01/2021	S4.55 DEVELOPMENT APPLICATION	MD

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Nominated Architects
Sandeep Arora 7337 | Ian Armstrong 7260 | Richard Does 8126 | Cathryn Drew-Brodin 7269 | Mary Anne McGirr 10946 |

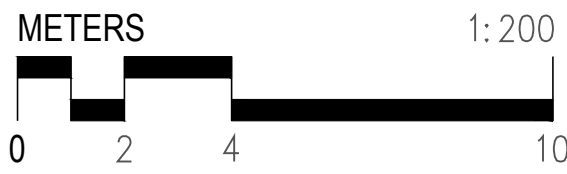

ARCHITECT	CLIENT	PROJECT	TITLE	QUALITY CERTIFIED ISO 9001	COMPLETION OF THE DRAWING STATUS IS EVIDENCE THE DESIGN HAS BEEN VERIFIED AS CONFORMING TO THE REQUIREMENTS OF THE PROJECT M.S. PLAN. INITIATING THE "DRAWN BY" BOX CONFIRMS THAT THIS DRAWING HAS BEEN PREPARED IN CONFORMITY WITH DESIGNINC SYDNEY M.S. PROCEDURES.
DesignInc DesignInc Sydney Pty Ltd Level 12, 77 Pacific Highway North Sydney NSW 2060 Australia +61 2 8925 7100 sydney@designinc.com.au	PARITER	HEATHCOTE GROUNDS 1-21 DILLWYNNIA GROVE, HEATHCOTE, SUTHERLAND 2233 NSW	SITE CALCULATIONS	ISO 9001	
					S4.55 DEVELOPMENT APPLICATION



GENERAL NOTE:

1. ALL EXISTING LEVELS EXTERNAL TO THE BUILDINGS TO REMAIN AS EXISTING LEVELS.


REVISION NOTES:

ALL PROPOSED LEVELS WITHIN THE LANDSCAPE HAVE BEEN REVISED TO REFLECT CURRENT ARCHITECTURE DESIGN AND PROPOSED BUILDING LEVELS

LEGEND			
+RL	RELATIVE LEVELS		
+TOW	TOP OF WALL LEVELS		
+FFL	FINISHED LEVEL		

No	DATE	REVISIONS	BY	MD
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				<div><div><div><div></div><div></div><div></div><div></div><div></div></div><div></div></div></div> <div>SCALES</div> <div></div>	<div>20 January 2021</div>							
				<div><div><div><div></div><div></div><div></div><div></div><div></div></div><div></div></div></div> <div>PLOT DATE</div> <div></div>	<div><div><div><div></div><div></div><div></div><div></div><div></div></div><div></div></div></div> <div>PROJECT N°.</div> <div>P20-056</div>	<div>REVISION</div> <div>A</div>						
				<div><div><div><div></div><div></div><div></div><div></div><div></div></div><div></div></div></div> <div>DRAWING N°.</div> <div>LA-05</div>								
				<div><div><div><div></div><div></div><div></div><div></div><div></div></div><div></div></div></div> <div>DRAWING STATUS</div> <div>MD</div>	<div>REVIEWED BY</div> <div>SIGNATURE</div>	<div>DATE</div> <div></div>						
<div><div><div><div></div><div></div><div></div><div></div><div></div></div><div></div></div></div> <div>QUALITY CERTIFIED</div> <div>ISO 9001</div>							<div>Completion of the Drawing Status is evidence the design has been verified as conforming to the requirements of the Project M.S. Plan, initiating the "Drawn By" box confirms that this drawing has been prepared in conformity with DesignInc Sydney M.S. procedures.</div>					
<div>S4.55 DEVELOPMENT APPLICATION</div>												

QUALITY CERTIFIED
ISO 9001

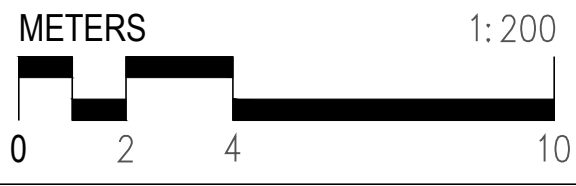Completion of the Drawing Status is evidence the design has been verified as conforming to the requirements of the Project M.S. Plan. Initiating the 'Drawn By' box confirms that this drawing has been prepared in conformity with DesignInc Sydney M.S. procedures.

REVISION NOTES:

1. PA1 ASPHALT REPLACED WITH CONCRETE OFF PODIUM
2. PA7 ASPHALT REPLACED WITH LARGE FORMAT PAVEMENT ON PODIUM
3. PA7 TIMBER REPLACED WITH SMALL FORMAT PAVEMENT ON FRONT TOWN HOUSE ENTRY

LEGEND

PA1	STANDARD CONCRETE PATH	1
PA2	RED BRICK HERITAGE PAVING	
PA3	DECO GRAVEL	
PA4	MULCH HERITAGE PATH	
PA5	PEBBLES	
PA6	ASPHALT PAVING	2
PA7	GRANITE PAVER (LARGE FORMAT)	3
PA7	GRANITE PAVER (SMALLER FORMAT)	
PA9	SANDSTONE PAVING	
	PATIO/COURTYARD PAVING	
	RAISED TIMBER DECK	
	TURF	
WA1	INSITU CONCRETE WALL 300MM H	
WA2	INSITU CONCRETE WALL 600MM H	
WA3	INSITU CONCRETE WALL 900-1200MM H	
EG1	STEEL EDGING	
EG2	BRICK EDGING	
EG3	HERITAGE RED ROPE EDGING	
SS	SHELTER STRUCTURES	
ST	CONCRETE STAIRS	
FC1A	1.2M WHITE HERITAGE PICKET FENCE	
FC1B	1.8M WHITE HERITAGE PICKET FENCE	
FC2	1.2M TOWNHOUSE TIMBER PICKET FENCE	
FC3	1.8M COLOURBOND FENCE	
FC3A	1.8M EXISTING COLOURBOND FENCE	
FC4A	1.8M VERTICAL METAL BATTEN FENCE (50MMX50MM)	
FC4B	1.8M VERTICAL METAL BATTEN FENCE (50MMX100MM)	
FC4C	1.2M VERTICAL METAL BATTEN FENCE (50MMX50MM)	
FC5	1.2M TIMBER BATTEN FENCE	
FC6	SANDSTONE LOG WALL	
	BENCH SEATING	

No	DATE	REVISIONS	BY
A	15/01/2021	S4.55 DEVELOPMENT APPLICATION	MD

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Nominated Architects
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PROJECT


HEATHCOTE GROUNDS
 1-21 DILLWYNNIA GROVE,
 HEATHCOTE,
 SUTHERLAND 2233 NSW


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DRAWING N°.	LA-07		A	
DRAWING STATUS	REVIEWED BY	SIGNATURE	DATE	
	MD			
S4.55 DEVELOPMENT APPLICATION				





- NOTE**
- 1. REFER ARBORIST REPORT FOR DETAILED INFORMATION
 - 2. TREE ZONES BASED ON INFORMATION TAKEN FROM ARBORISTS REPORT BY JACKSONS TREE WORKS

LEGEND

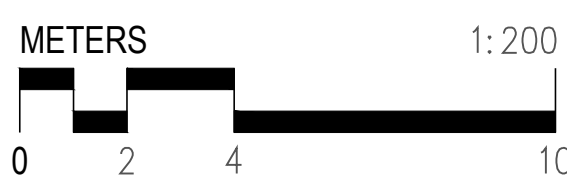- TREES TO BE RETAINED
- TPZ (TREE PROTECTION ZONE)
- SRZ (STRUCTURAL ROOT ZONE)

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**HEATHCOTE GROUNDS
1-21 DILLWYNNIA GROVE,
HEATHCOTE,
SUTHERLAND 2233 NSW**

TITLE

TREES TO BE RETAINED WITH TPZ AND SRZ

	DRAWN BY	SP	
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	PLOT DATE	20 January 2021	
	PROJECT N°.	P20-056	REVISION
QUALITY CERTIFIED ISO 9001	DRAWING N°.	LA-09	A
	DRAWING STATUS	REVIEWED BY	DATE
		MD	
S4.55 DEVELOPMENT APPLICATION			



PLANTING AREAS

- TREE PLANTING AREAS OUTSIDE OF HERITAGE AND OUTSIDE
 3M SETBACK FROM ANY BUILT FORM
 APPROX 1 INDIGENOUS/STIFF TREE/m2 (trees rangng in size from
 small to large canopy trees)
1964 m2
 APPROX 368 TREES (CHOSEN FROM COUNCIL NATIVE TREE
 SELECTOR AND OUTLINED IN THE TABLE ON PAGE L18)

- * TREE DENSITY AND NUMBERS TO BE CONFIRMED BY BUSHFIRE CONSULTANT

NOTE: ALL LANDSCAPED AREAS HAVE BEEN REVISED IN CONJUNCTION WITH REVISED ARCHITECTURAL DESIGN

NOTE: ALL LANDSCAPED AREAS HAVE BEEN REVISED IN CONJUNCTION WITH REVISED ARCHITECTURAL DESIGN

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No	DATE	REVISIONS	BY										
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PLANT SCHEDULE

CODE	BOTANICAL NAME	COMMON NAME	POT SIZE	MATURE HEIGHT	MATURE SPREAD	SPACING	DENSITY	QUANTITY
TREES								
Ang cos	<i>Angophora costata</i>	Sydney Red Gum	45L	15m - 20m	6m - 10m	AS SHOWN	AS SHOWN	5
Cer gum	<i>Ceratopetalum gummiferum</i>	NSW Christmas Bush	200mm	2m - 4m	1m - 3m	AS SHOWN	AS SHOWN	15
Cit lim	<i>Citrus limon</i> "Eureka"	Eureka Lemon	45L	5-10m	3.5 -6m	AS SHOWN	AS SHOWN	10
Cor gum	<i>Corymbia gummifera</i>	Red Bloodwood	45L	15m - 20m	3.5m - 6m	AS SHOWN	AS SHOWN	7
Ela ret	<i>Elaeocarpus reticulatus</i>	Blueberry Ash	45L	5m - 10m	2m - 4m	AS SHOWN	AS SHOWN	12
Euc pan	<i>Eucalyptus paniculata</i>	Grey Ironbark	45L	10m - 30m	6m	AS SHOWN	AS SHOWN	9
Euc pil	<i>Eucalyptus pilularis</i>	Blackbutt	75L	over 30m	6m - 10m	AS SHOWN	AS SHOWN	9
Euc sal	<i>Eucalyptus saligna</i>	Sydney Blue Gum	75L	15m - 30m	5m -12m	AS SHOWN	AS SHOWN	10
Glo fer	<i>Glochidion ferdinandi</i>	Cheese Tree	45L	5m - 10m	6m - 10m	AS SHOWN	AS SHOWN	8
Lag ind	<i>Lagerstroemia indica x fauriei</i> Biloxi Indian Summer	Crepe Myrtle	45L	4m	3m	AS SHOWN	AS SHOWN	13
Lep pol	<i>Leptospermum polygalifolium</i>	Jelly Bush	200mm	2m	1.5m	AS SHOWN	AS SHOWN	10
Lep tri	<i>Leptospermum trinervium</i>	Paperbark Tea Tree	300mm	2m	1m - 2m	AS SHOWN	AS SHOWN	8
Mag exm	<i>Magnolia grandiflora</i> "Exmouth"	Magnolia	45L	5m	4m	AS SHOWN	AS SHOWN	12
Mag gra	<i>Magnolia grandiflora</i> "T eddy Bear"	Magnolia	45L	2-4m	2 - 3.5m	AS SHOWN	AS SHOWN	15
Ole eur	<i>Olea europaea</i> "Manzanillo"	Olive	45L	3m	2m	AS SHOWN	AS SHOWN	10
Pit rev	<i>Pittosporum revolutum</i>	Hairy Pittosporum	200mm	1m -2m	1.5m	AS SHOWN	AS SHOWN	8
Pit und	<i>Pittosporum undulatum</i>	Sweet Pittosporum/Native Daphne	45L	10m - 15m	1m -3m	AS SHOWN	AS SHOWN	15
Syn glo	<i>Syncarpia glomulifera</i>	Turpentine	45L	over 30m	6m -10m	AS SHOWN	AS SHOWN	7
							TOTAL	183
PLANT MIX 1: FRONT GARDENS (TOTAL AREA: 479m²)								
Gar aug	<i>Gardenia augusta</i> "Florida"	Gardenia	200mm	1m	1m	AS SHOWN	15% (6m2)	431
Lom lon	<i>Lomandra longifolia</i> "Sungold"	Mat Rush	150mm	0.6m	0.6m	AS SHOWN	20% (6m2)	575
Poa lab	<i>Poa labillardieri</i> "Eskdale"	Lion's Tail	150mm	0.6m	0.5m	AS SHOWN	15% (6m2)	431
Rap ind	<i>Raphiolepis indica</i> "Oriental Pearl"	Inian Hawthorn	200mm	0.45m - 0.6m	1.2m - 2.0m	AS SHOWN	15% (6m2)	431
Sta byz	<i>Stachys byzantina</i>	Lamb's Ear	150mm	0.15m - 0.6m	0.30m - 0.6m	AS SHOWN	15% (6m2)	431
Wes fru	<i>Westringia fruticosa</i>	Coastal Rosemary	200mm	0.6m	0.9m	AS SHOWN	10% (6m2)	287
Zam fur	<i>Zamia furfuracea</i>	Cardboard Plant	150mm	0.5m	0.6m	AS SHOWN	10% (6m2)	287
							TOTAL	2873
PLANT MIX 2: REAR GARDENS (TOTAL AREA: 407m²)								
Cal dub	<i>Calochlaena dubia</i>	Flase Bracken Fern	150mm	0.9m - 1.5m	0.3m	AS SHOWN	15% (6m2)	366
Cra ova	<i>Crasula ovata</i> "Minima"	Mini Jade	150mm	0.3m	0.3m - 0.6m	AS SHOWN	15% (6m2)	366
Lav sto	<i>Lavandula stoechas</i> "Avon View"	Avon View Lavander	200mm	0.8m	0.6m	AS SHOWN	15% (6m2)	366
Lom lab	<i>Lomandra labill</i> "Evergreen Baby"	Dwarf Mat Rush	150mm	0.40m - 0.45m	0.45m	AS SHOWN	15% (6m2)	366
San uga	<i>Sansevieria uganda</i>	Sansevieria	200mm	0.7m	0.9m	AS SHOWN	10% (6m2)	244
Sen man	<i>Senecio mandraliscae</i>	Blue Chalk Sticks	150mm	0.15m	0.5m	AS SHOWN	10% (6m2)	244
Sta byz	<i>Stachys byzantina</i>	Lamb's Ear	150mm	0.15m - 0.6m	0.30m - 0.6m	AS SHOWN	10% (6m2)	244
Ste jun	<i>Streitzia juncea</i>	Narrow-Leaf Bird of Paradise	200mm	0.9m - 1.5m	0.9m - 1.2m	AS SHOWN	10% (6m2)	244
							TOTAL	2440
PLANT MIX 3: REAR GARDENS (TOTAL AREA: 75.1m²)								
Acm smi	<i>Acmena smithii</i> "Minor"	Lily Pilly	200mm	2-3m	2m	AS SHOWN	15% (6m2)	68
Cor alb	<i>Correa alba</i>	White Correa	200mm	0.9m - 1.5m	0.9m - 1.2m	AS SHOWN	15% (6m2)	68
Cra arb	<i>Crassula arborescens</i> "Bluebird"	Blue Bird	150mm	0.3m	0.3m - 0.6m	AS SHOWN	10% (6m2)	45
Lom fil	<i>Lomandra filiformis</i> "Savanna Blue"	Wattle Mat Rush	150mm	0.5m	0.5m	AS SHOWN	10% (6m2)	45
Rap ind	<i>Raphiolepis indica</i> "Oriental Pearl"	Inian Hawthorn	200mm	0.45m - 0.6m	1.2m - 2.0m	AS SHOWN	10% (6m2)	45
Sen man	<i>Senecio mandraliscae</i>	Blue Chalk Sticks	150mm	0.15m	0.5m	AS SHOWN	10% (6m2)	45
Ste reg	<i>Strelitzia reginae</i>	Bird of Paradise	200mm	0.9m - 1.5m	0.9m - 1.2m	AS SHOWN	10% (6m2)	45
Wes fru	<i>Westringia fruticosa</i>	Coastal Rosemary	200mm	0.6m	0.9m	AS SHOWN	10% (6m2)	45
Zam fur	<i>Zamia furfuracea</i>	Cardboard Plant	150mm	0.5m	0.6m	AS SHOWN	10% (6m2)	45
							TOTAL	451

PLANT MIX 4: COMMON SPACES (TOTAL AREA: 1033.4m²)								
Cal dub	<i>Calochlaena dubia</i>	Flase Bracken Fern	150mm	0.9m - 1.5m	0.3m	AS SHOWN	10% (6m2)	620
Cor ref	<i>Correa reflexa</i>	Native Fuchsia	200mm	0.9m - 1.5m	0.9m - 1.2m	AS SHOWN	10% (6m2)	620
Cra arb	<i>Crassula arborescens</i> "Bluebird"	Blue Bird	150mm	0.3m	0.3m - 0.6m	AS SHOWN	10% (6m2)	620
Dia cae	<i>Dianella caerulea</i>	Blue Flax Lily	150mm	0.6m - 0.75m	0.6m - 0.9m	AS SHOWN	5% (6m2)	310
Dic rep	<i>Dichondra repens</i>	Kidney Weed	150mm	0.3m	0.9m - 1.2m	AS SHOWN	5% (6m2)	310
Dil ret	<i>Dillwynia retorta</i>	Eggs and Bacon	200mm	1.5m	1m	AS SHOWN	5% (6m2)	310
Ent mar	<i>Entolasia marginala</i>	Sprawling Panic	150mm	0.75m - 0.9m	0.3m	AS SHOWN	5% (6m2)	310
Gre lin	<i>Grevillea linearifolia</i>	Narrow Leaf Grevillea	200mm	1.5m	1.5m	AS SHOWN	5% (6m2)	310
Hib bra	<i>Hibbertia bracteata</i>	Guinea Flower	200mm	1m	1m	AS SHOWN	5% (6m2)	310
Lam for	<i>Lambertia formosa</i>	Mountain Devil	200mm	1m - 2m	1m	AS SHOWN	5% (6m2)	310
Mel thy	<i>Melaleuca thymifolia</i>	Thyme Honey Myrtle	200mm	1m	1m	AS SHOWN	5% (6m2)	310
Pat ser	<i>patersonia sericea</i>	Silky Purple Flag	150mm	0.3m - 0.45m	0.3m	AS SHOWN	5% (6m2)	310
Per pin	<i>Persoonia pinifolia</i>	Pine Lead Geebung	200mm	2m - 3m	2m	AS SHOWN	5% (6m2)	310
Poa lab	<i>Poa labillardieri</i> "Eskdale"	Lion's Tail	150mm	0.6m	0.5m	AS SHOWN	5% (6m2)	310
The aus	<i>Themeda australis</i>	Kanagaroo Grass	150mm	0.9m - 1.5m	0.3m - 0.6m	AS SHOWN	5% (6m2)	310
Wah com	<i>Wahlenbergia communis</i>	Blue Bells	200mm	0.3m	0.2m	AS SHOWN	5% (6m2)	310
Xan con	<i>Xanthorrhoea concava</i>	Grass Tree	150mm	1m	1m	AS SHOWN	5% (6m2)	310
							TOTAL	6200

PLANT MIX 5: BUFFER PLANTING (TOTAL AREA: 2045m²)								
Aca lon	<i>Acacia longifolia</i> var. <i>longifolia</i>	Sydney Golden Wattle	200mm	3m - 5m	2m - 3.5m	AS SHOWN	5% (6m2)	614
Act hel	<i>Actinotus helianthi</i>	Flannel Flower	150mm	1m	0.5m	AS SHOWN	5% (6m2)	614
Act hel	<i>Actinotus helianthi</i>	Flannel Flower	150mm	1m	0.5m	AS SHOWN	5% (6m2)	614
Ari vag	<i>Aristida vagans</i>	Threese Awned Spear Grass	150mm	0.3m	0.9m	AS SHOWN	5% (6m2)	614
Ban spi	<i>Banksia spinulosa</i>	Hairpin Banksia	200mm	0.9m - 1.5m	0.9m - 1.5m	AS SHOWN	5% (6m2)	614
Bur spi	<i>Bursaria spinosa</i> var. <i>macrophylla</i>	Sweet Bursaria	200mm	3m -5m	2m - 3.5m	AS SHOWN	5% (6m2)	614
Cym ref	<i>Cymbopogon refractus</i>	Barbed Wire Grass	150mm	0.5m	0.9m	AS SHOWN	5% (6m2)	614
Dia cae	<i>Dianella caerulea</i>	Blue Flax Lily	150mm	0.6m - 0.75m	0.6m - 0.9m	AS SHOWN	5% (6m2)	614
Gah sie	<i>Gahnia sieberian</i>	Red Fruit Saw Edge	150mm	2m	0.8m	AS SHOWN	5% (6m2)	614
Hib bra	<i>Hibbertia bracteata</i>	Guinea Flower	200mm	1m	1m	AS SHOWN	5% (6m2)	614
Hib emp	<i>Hibbertia empetrifolia</i>	Trailing Guinea Flower	200mm	0.3m	0.6m	AS SHOWN	5% (6m2)	614
Imp cyl	<i>Impertata cylindrica</i>	Blady Grass	150mm	0.3m - 0.45m	0.3m	AS SHOWN	5% (6m2)	614
Lom lon	<i>Lomandra longifolia</i>	Mat Rush	150mm	0.75m - 0.9m	0.9m - 1.2m	AS SHOWN	5% (6m2)	614
Lom mul	<i>Lomandra multiflora</i>	Many-Flowered Mat Rush	150mm	0.3m - 0.45m	0.3m	AS SHOWN	5% (6m2)	614
Mel thy	<i>Melaleuca thymifolia</i>	Thyme Honey Myrtle	200mm	1m	1m	AS SHOWN	5% (6m2)	614
Mic sti	<i>Microlaena stipoidea</i>	Weeping grass	150mm	0.6m - 0.75m	0.6m - 0.9m	AS SHOWN	5% (6m2)	614
Not Lon	<i>Notelaea longifolia</i>	Mock Olive	200mm	1.5m - 2m	1m -1.5m	AS SHOWN	5% (6m2)	614
Ole mic	<i>Olearia microphylla</i>	Small Leaf Daisy Bush	200mm	1m - 2m	1.5m	AS SHOWN	5% (6m2)	614
Pat ser	<i>patersonia sericea</i>	Silky Purple Flag	150mm	0.3m - 0.45m	0.3m	AS SHOWN	5% (6m2)	614
The aus	<i>Themeda australis</i>	Kanagaroo Grass	150mm	0.9m - 1.5m	0.3m - 0.6m	AS SHOWN	5% (6m2)	614
							TOTAL	12280

CODE	BOTANICAL NAME	COMMON NAME	POT SIZE	MATURE HEIGHT	MATURE SPREAD	SPACING	DENSITY	QUANTITY
PENTHOUSE SUITS								
Kal org	<i>Kalanchoe orgyalis</i> "Coppr Spoon"	Copper Spoons	150mm	1.8m	0.8m - 1m	AS SHOWN	AS SHOWN	42
Bou Bam	<i>Bougainvillea</i> "Bambino Zuki"	Bougainvillea	200mm	0.9m	0.9m	AS SHOWN	AS SHOWN	63
Con sab	<i>Convolvulus sabatius</i>	Blue Rock Bindweed	150mm	0.1m - 0.2m	0.45m - 0.6m	AS SHOWN	AS SHOWN	61
Lir mus	<i>Liriope muscari</i> "Samantha"	Liriope	150mm	0.45m	0.5m	AS SHOWN	AS SHOWN	47
Asp den	<i>Asparagus densiflorus</i> "Myersii"	Myers Fern	200mm	0.6m - 0.8m	1m	AS SHOWN	AS SHOWN	42
Kal bra	<i>Kalanchoe brachteata</i> "Silver Teaspoons"	Silver Teaspoons	200mm	1.2m	0.9m	AS SHOWN	AS SHOWN	63
Sed mor	<i>Sedum morganianum</i> "Donkey Tail"	Donkey Tail	150mm	0.2m	1.2m	AS SHOWN	AS SHOWN	61
Rap ind	<i>Raphiolepis indica</i> "Oriental Pearl"	Inian Hawthorn	200mm	0.45m - 0.6m	1.2m - 2.0m	AS SHOWN	AS SHOWN	7
Rha exc	<i>Rhapis excelsa</i> "Lady Palm"	Lady's Palm	200mm	4m	1.5m	AS SHOWN	AS SHOWN	8

NOTE: PLANT SCHEDULE UPDATED IN ACCORDANCE WITH DEVELOPMENT APPLICATION CONDITIONS AND CHANGES REFLECTED IN THE LANDSCAPE DESIGN

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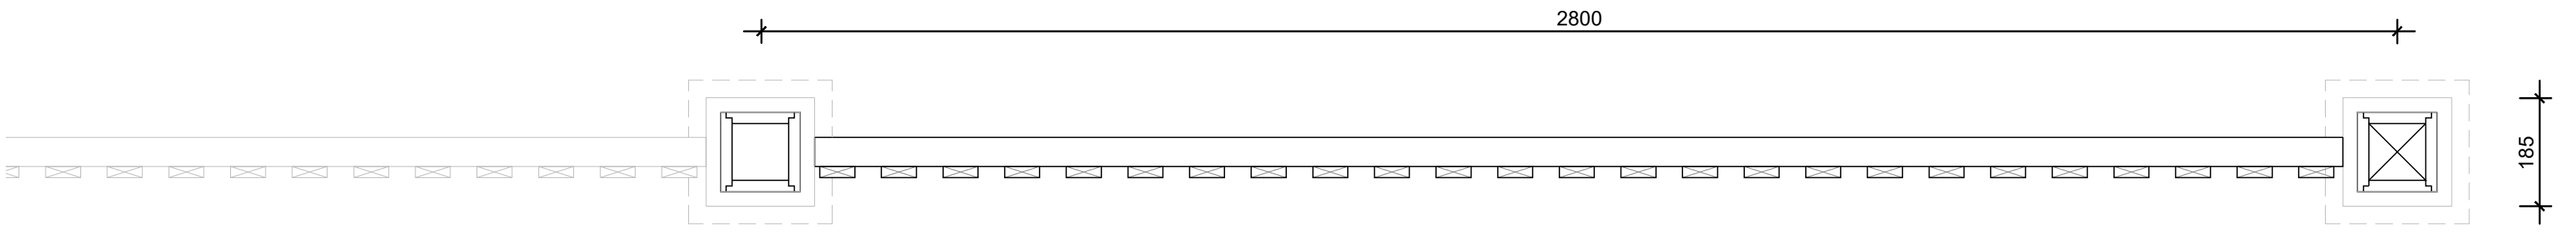
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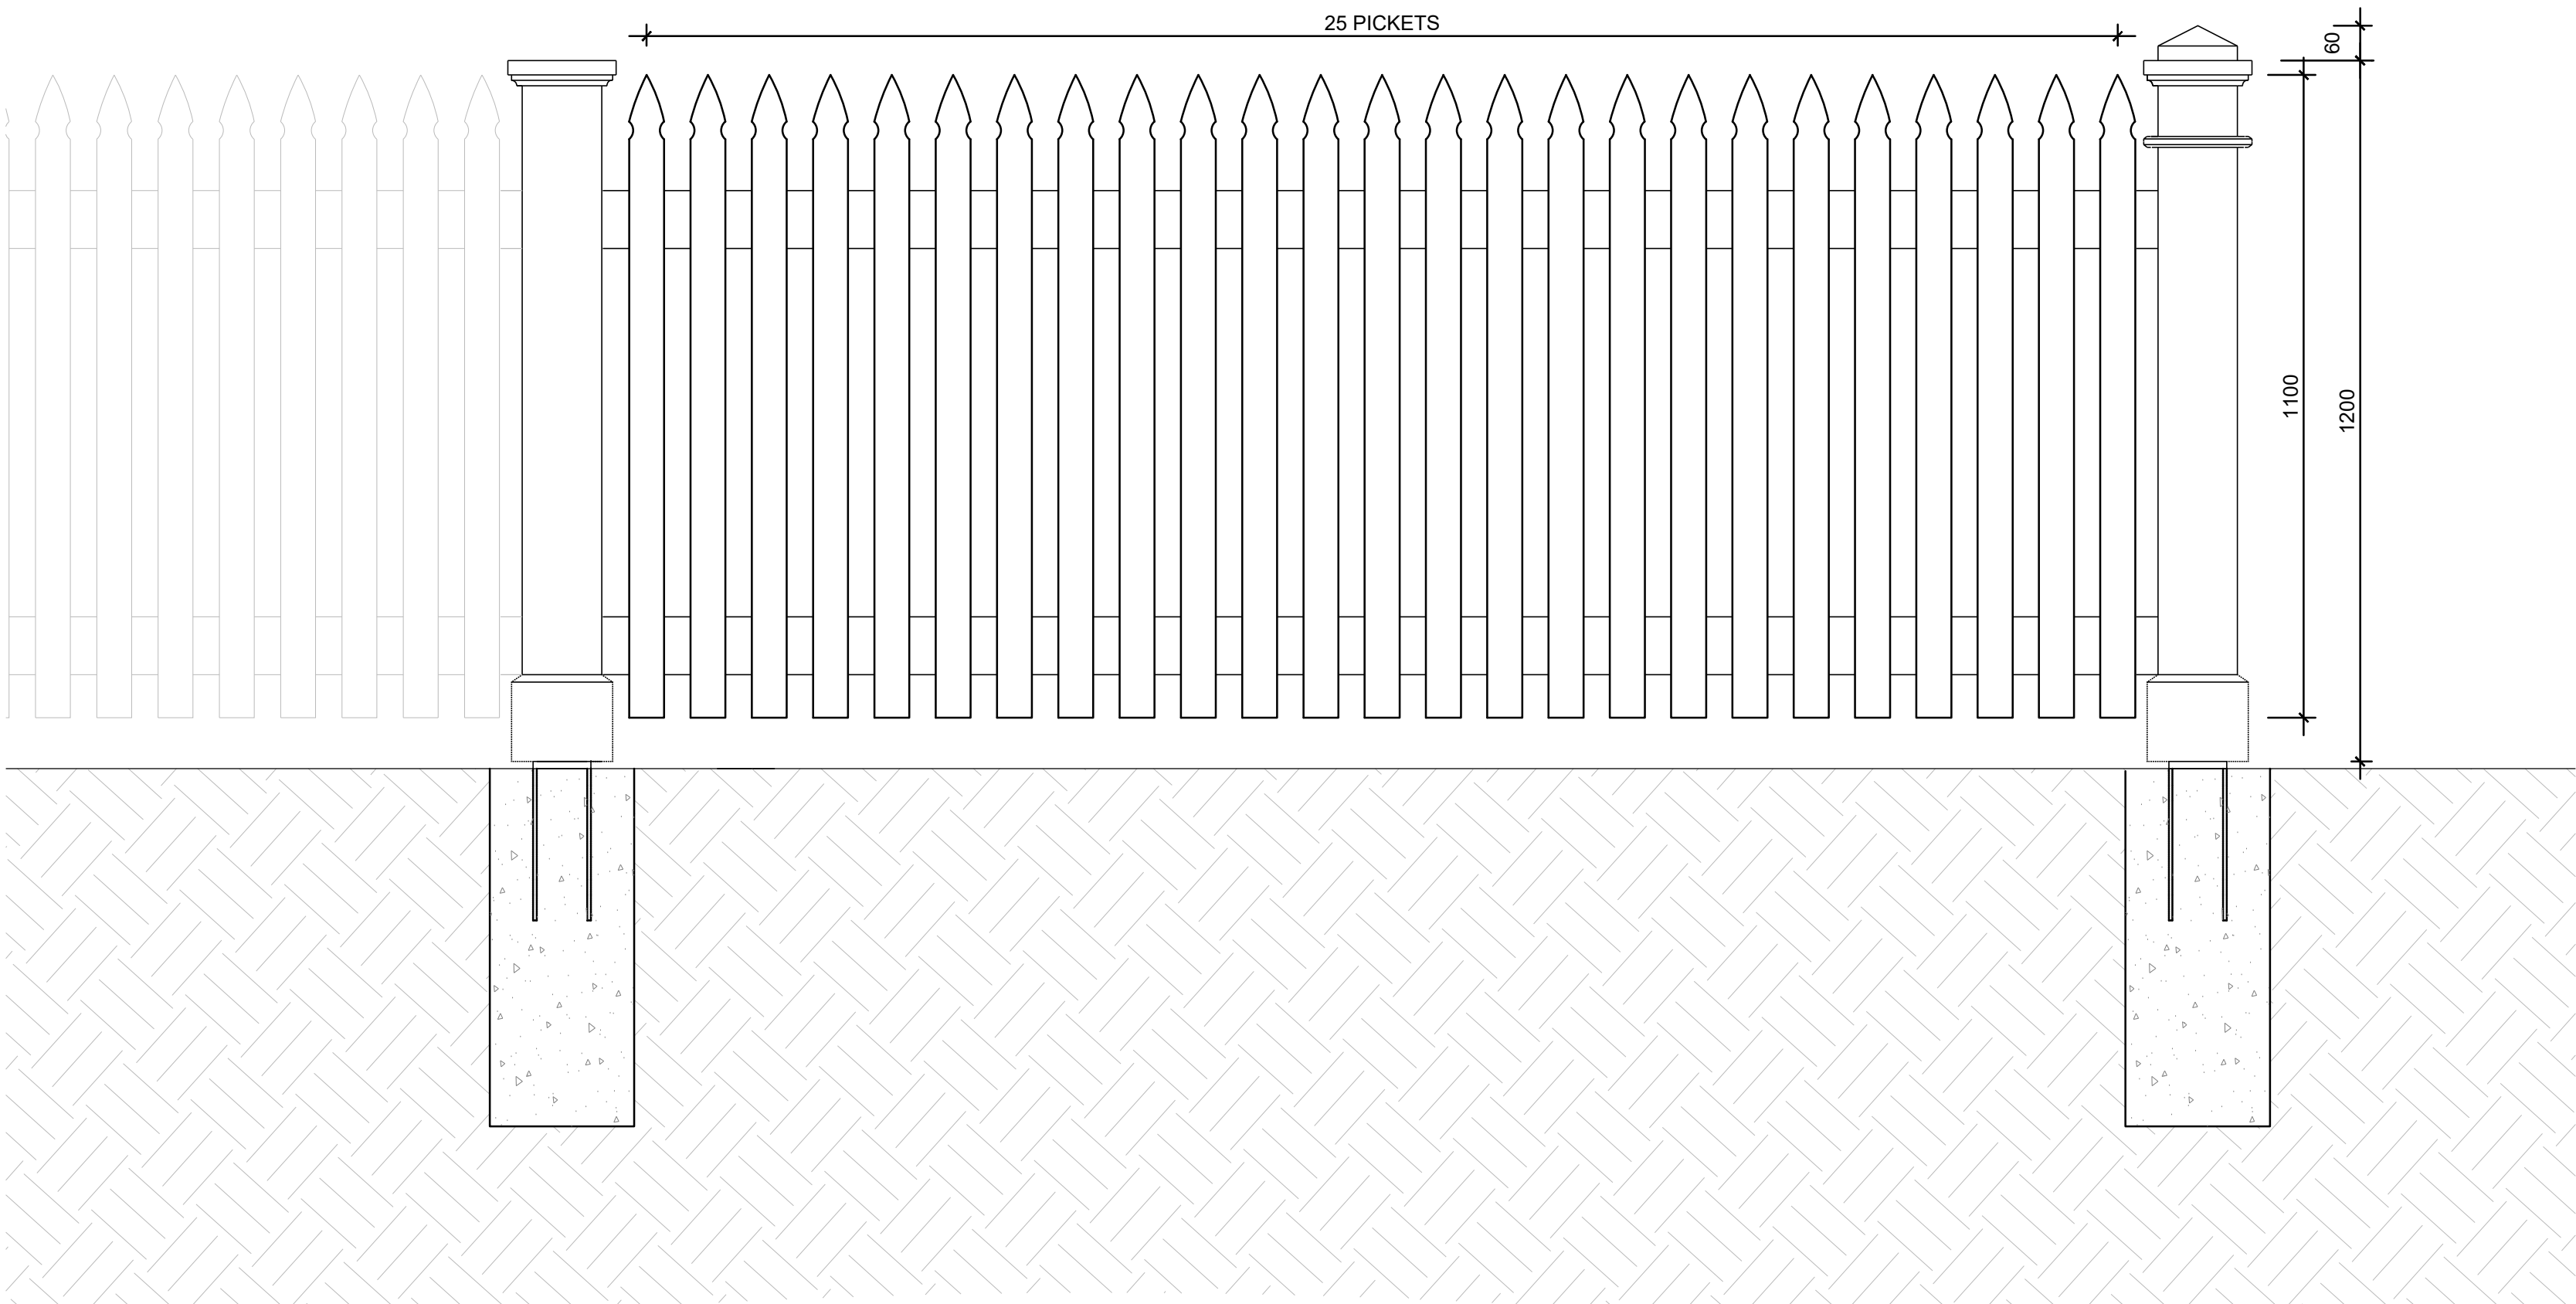
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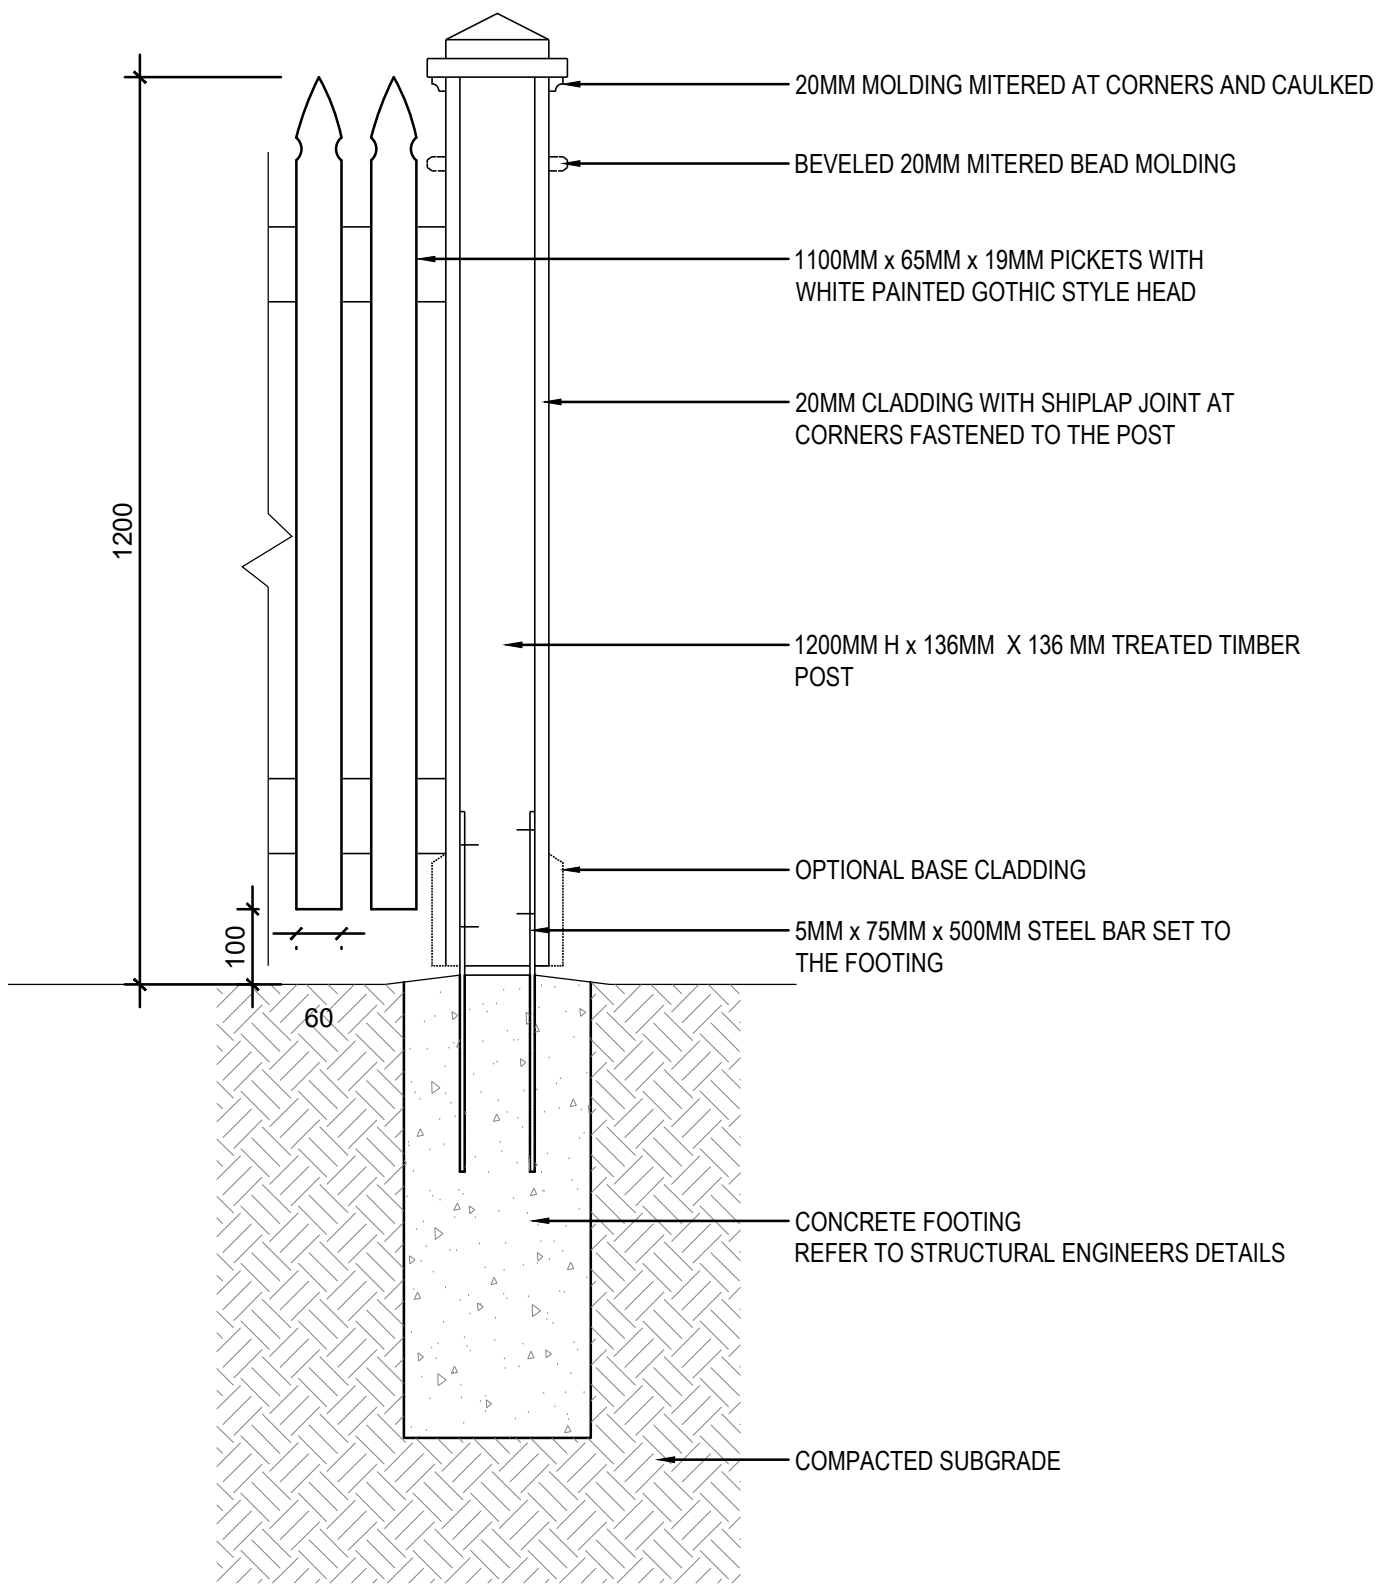
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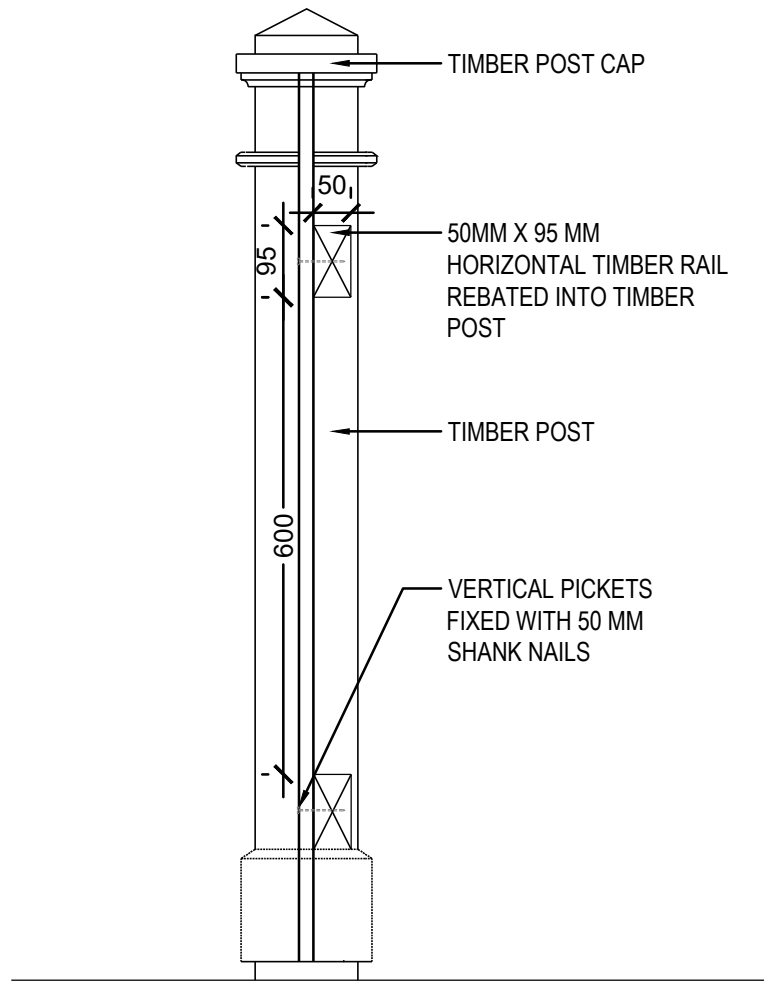
01 FC1A FENCING PLAN
1:10




02 FC1A FENCE ELEVATION
1:10




03 FC1A FENCE SECTION
1:10




04 FC1A FENCE FIXING DETAILS
1:10

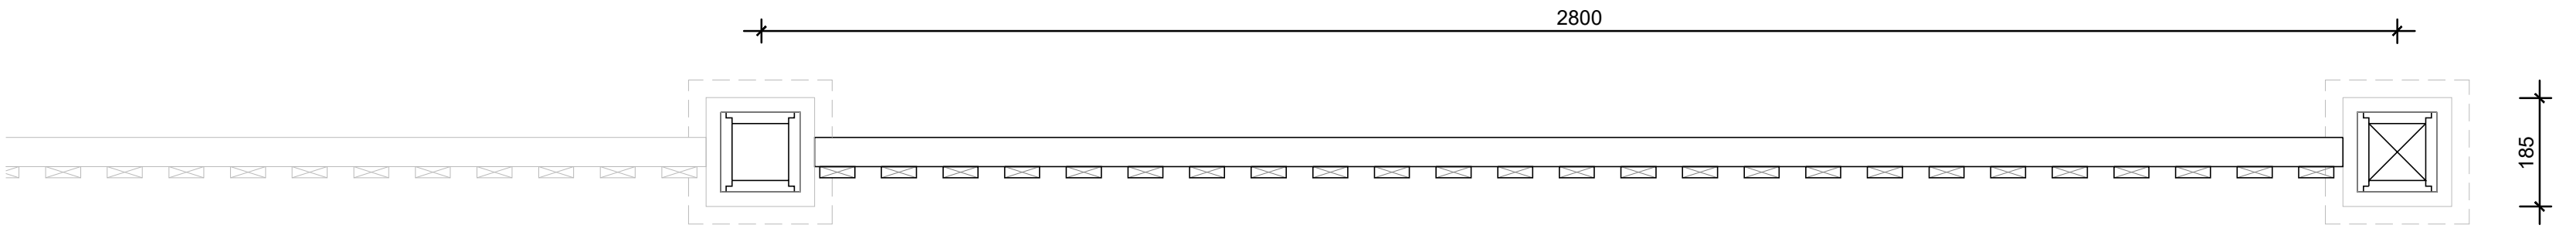


05 FC1B FENCING PLAN
1:10

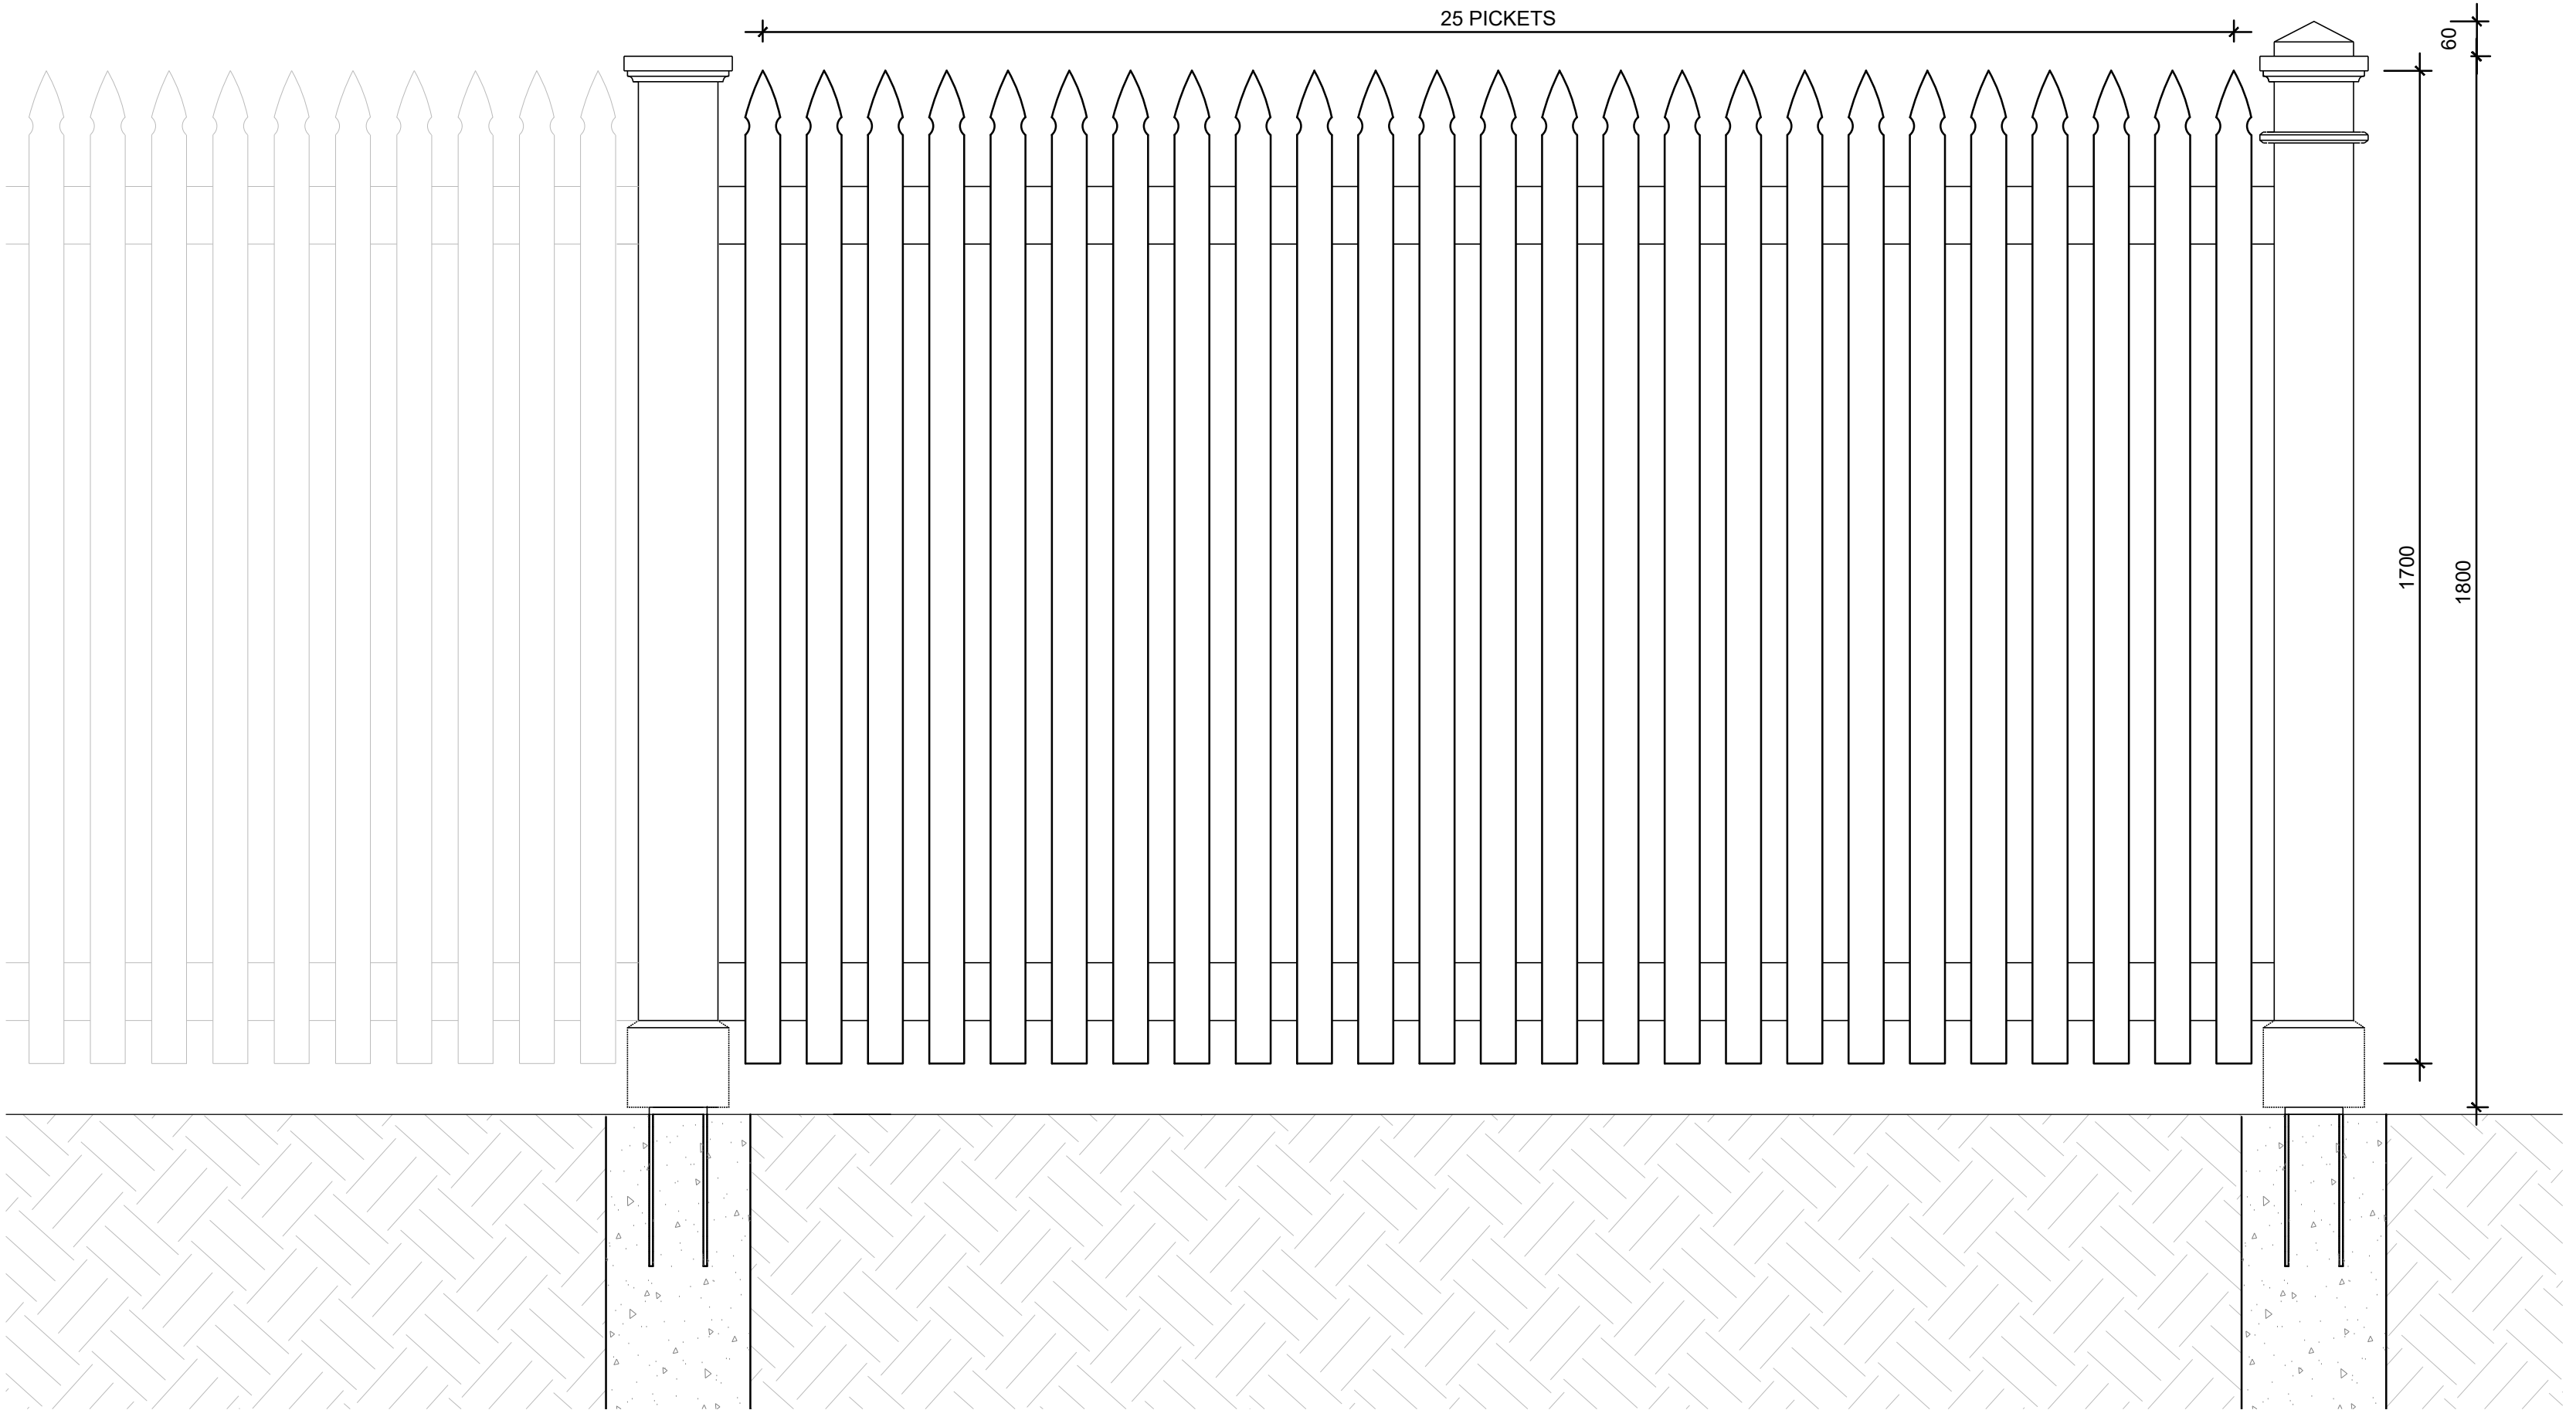

06 FC1B FENCE ELEVATION
1:10

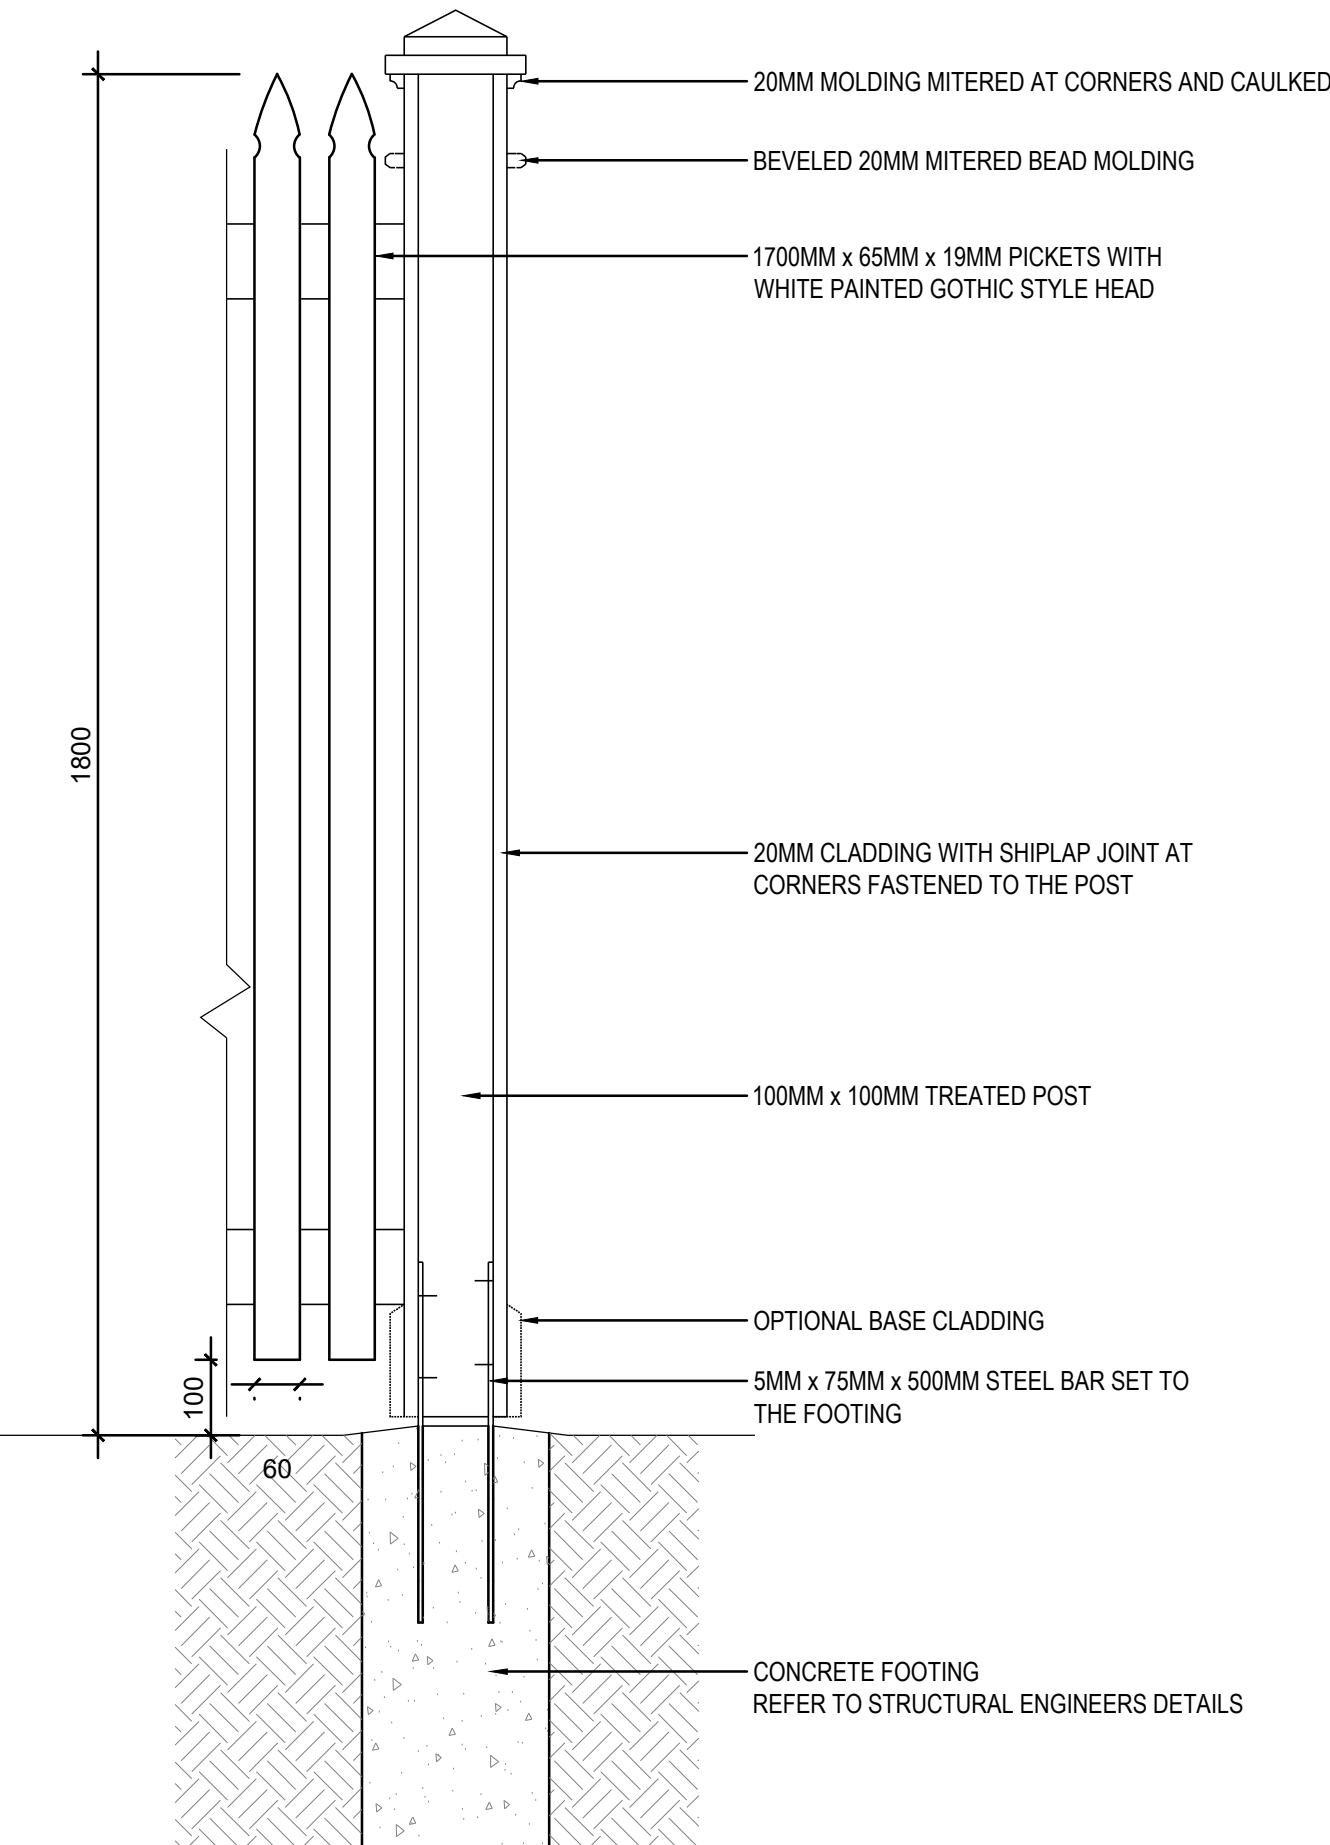

07 FC1B FENCE SECTION
1:10

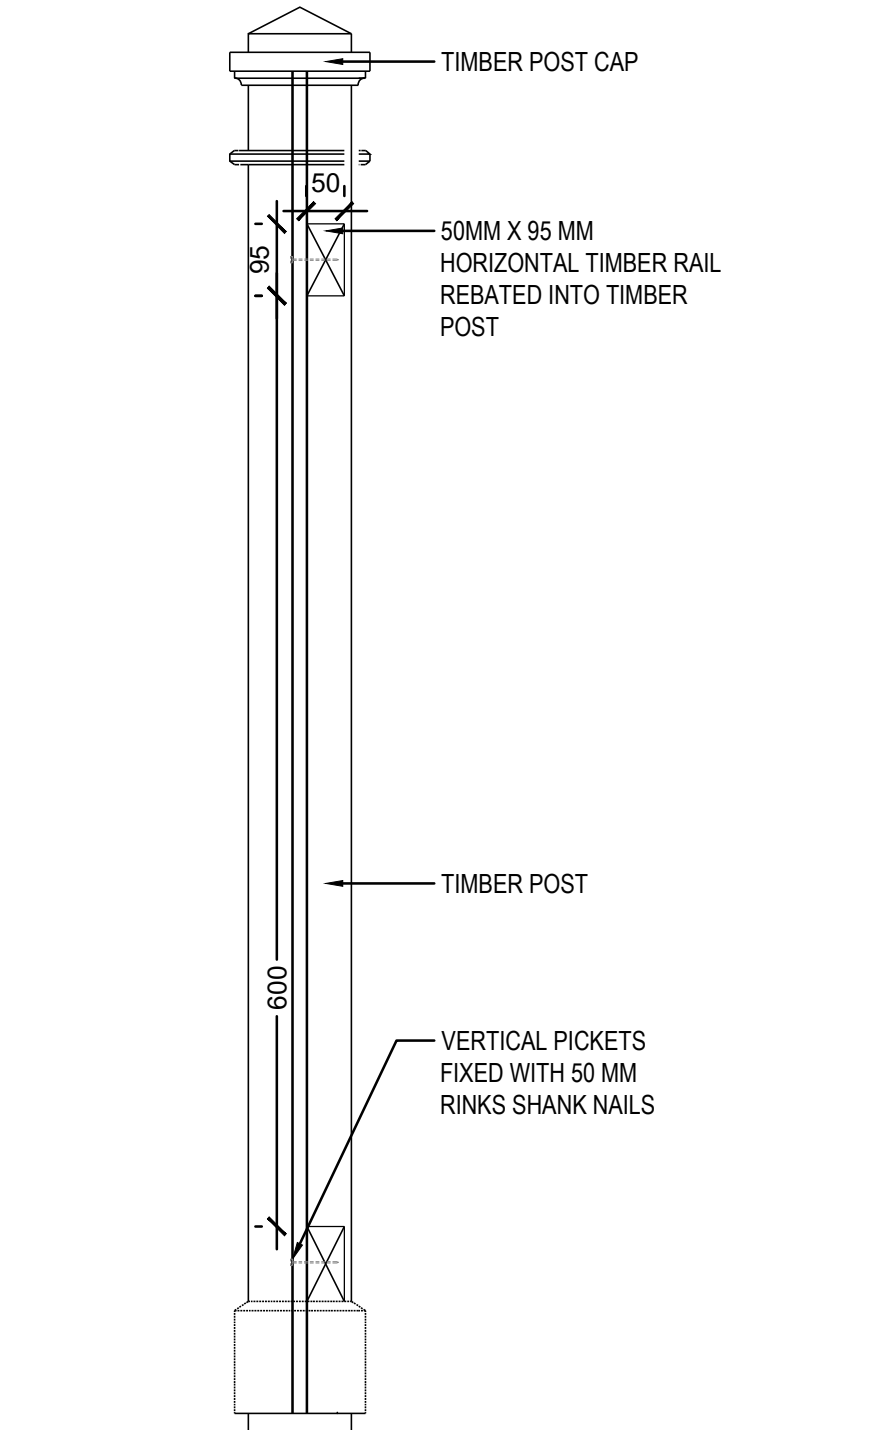

08 FC1B FENCE FIXING DETAILS
1:10

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CLIENT

PARITER

PROJECT

HEATHCOTE GROUNDS
1-21 DILLWYNNIA
GROVE,
HEATHCOTE,
SUTHERLAND 2233 NSW

TITLE

FENCING DETAILS
SHEET ONE

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PROJECT N°.

P20-056

DRAWING N°.

LA-15

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REVIEWED BY


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DATE


REVISION

A

S4.55 DEVELOPMENT APPLICATION

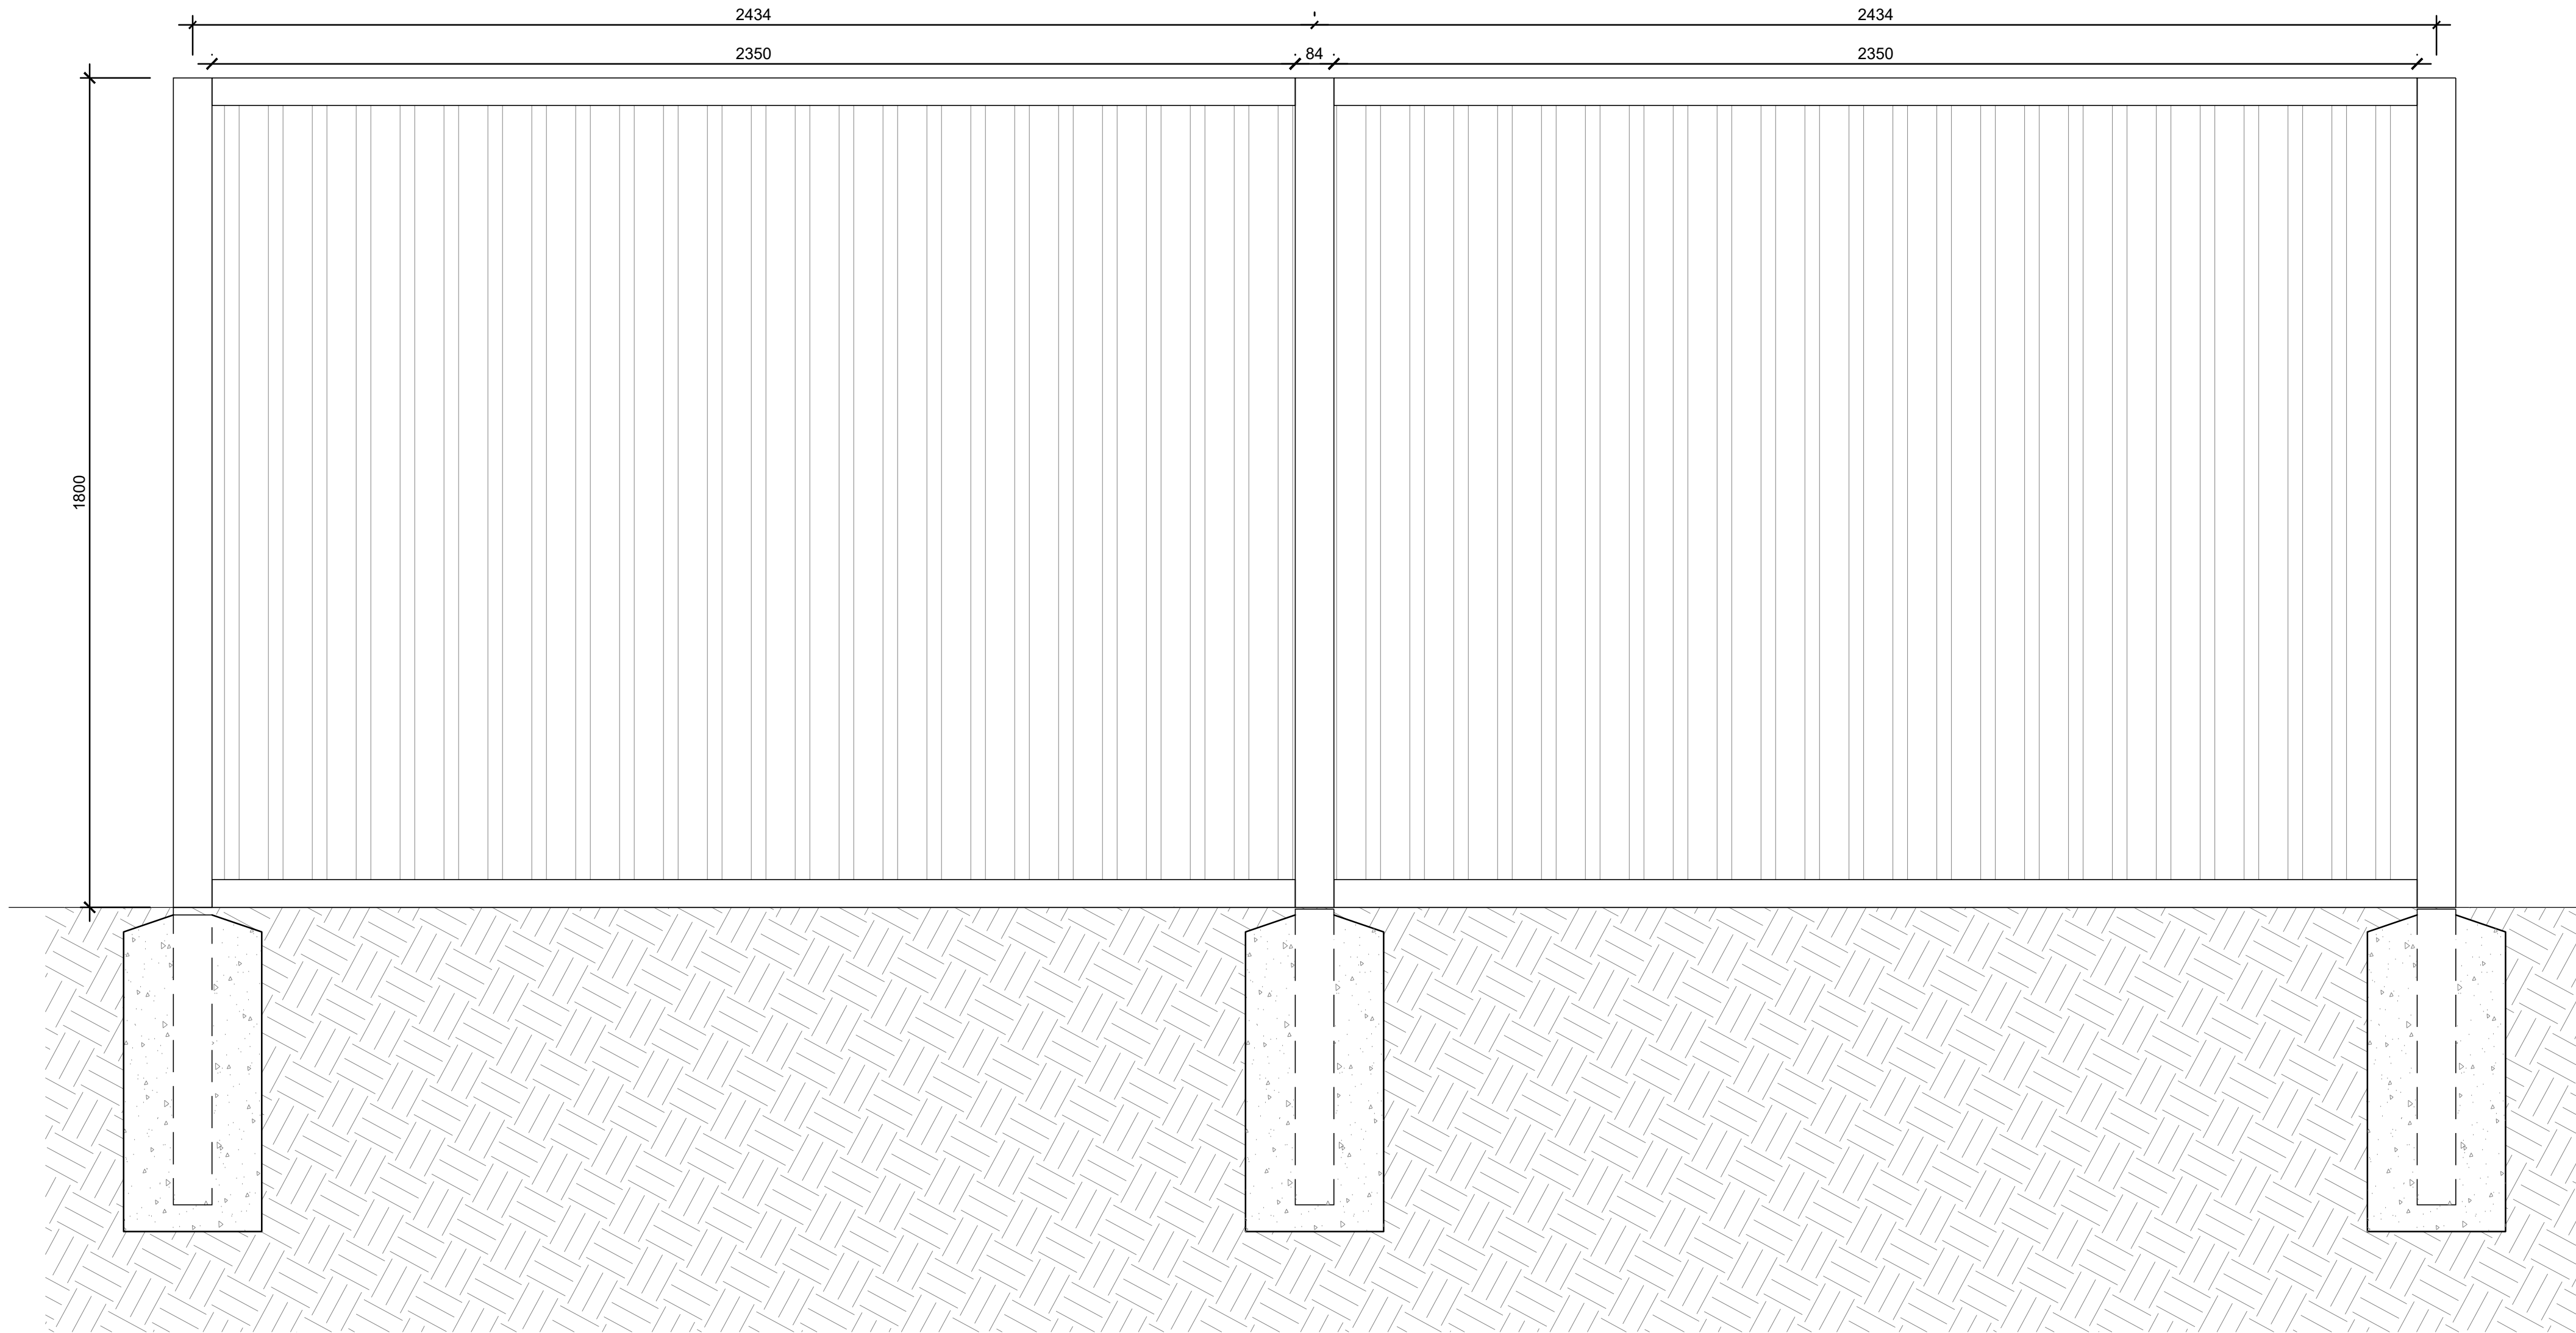

01 FC3 FENCE ELEVATION
1:10

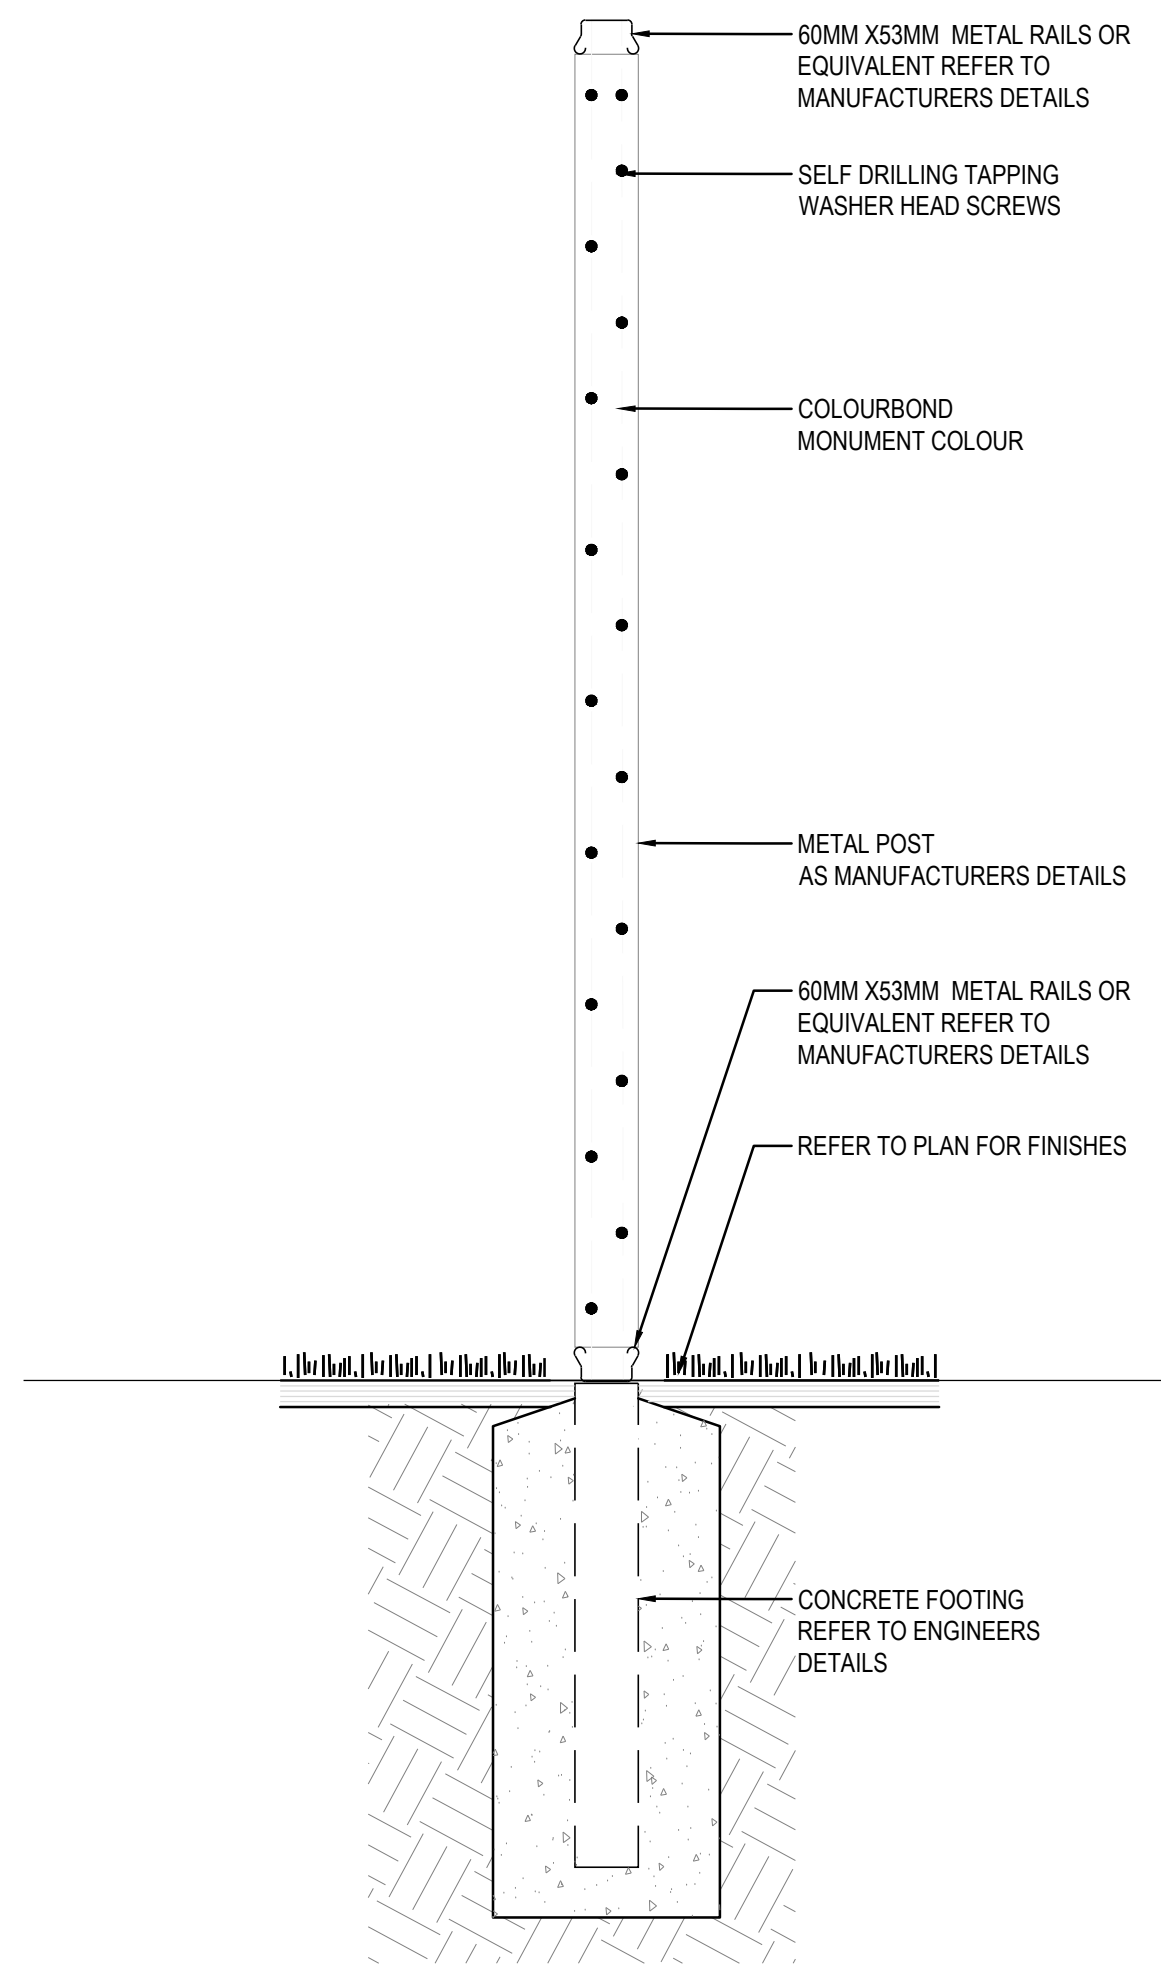

GENERAL NOTES:
DRAWING IS INDICATIVE. ALL
DRAWINGS TO BE UNDERTAKEN AS
PER MANUFACTURERS DETAIL.

02 FC3 FENCE SECTION
1:10

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1-21 DILLWYNNIA GROVE,
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SUTHERLAND 2233 NSW

TITLE

FENCING DETAILS
SHEET THREE

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SCALES

AS SHOWN

PLOT DATE

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PROJECT N°.

P20-056

DRAWING N°.

LA-18

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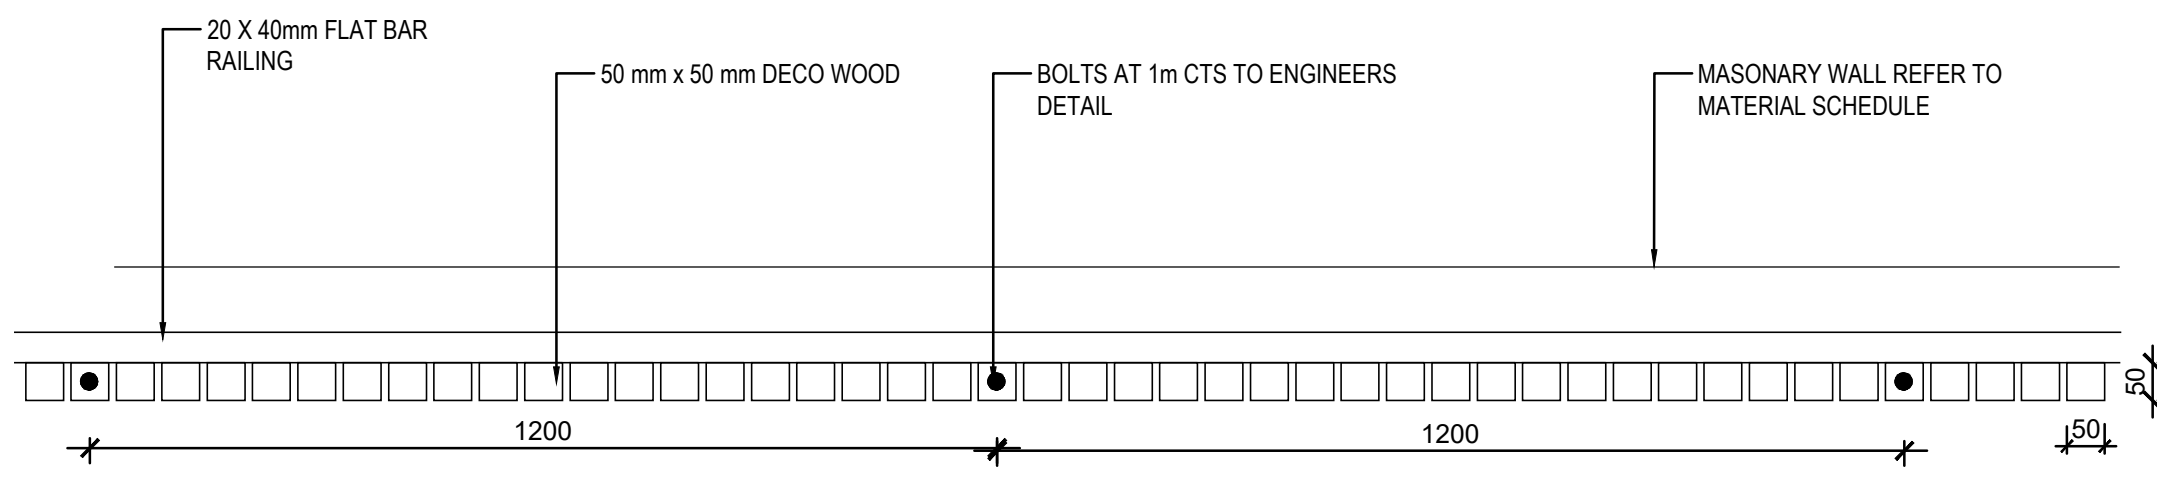
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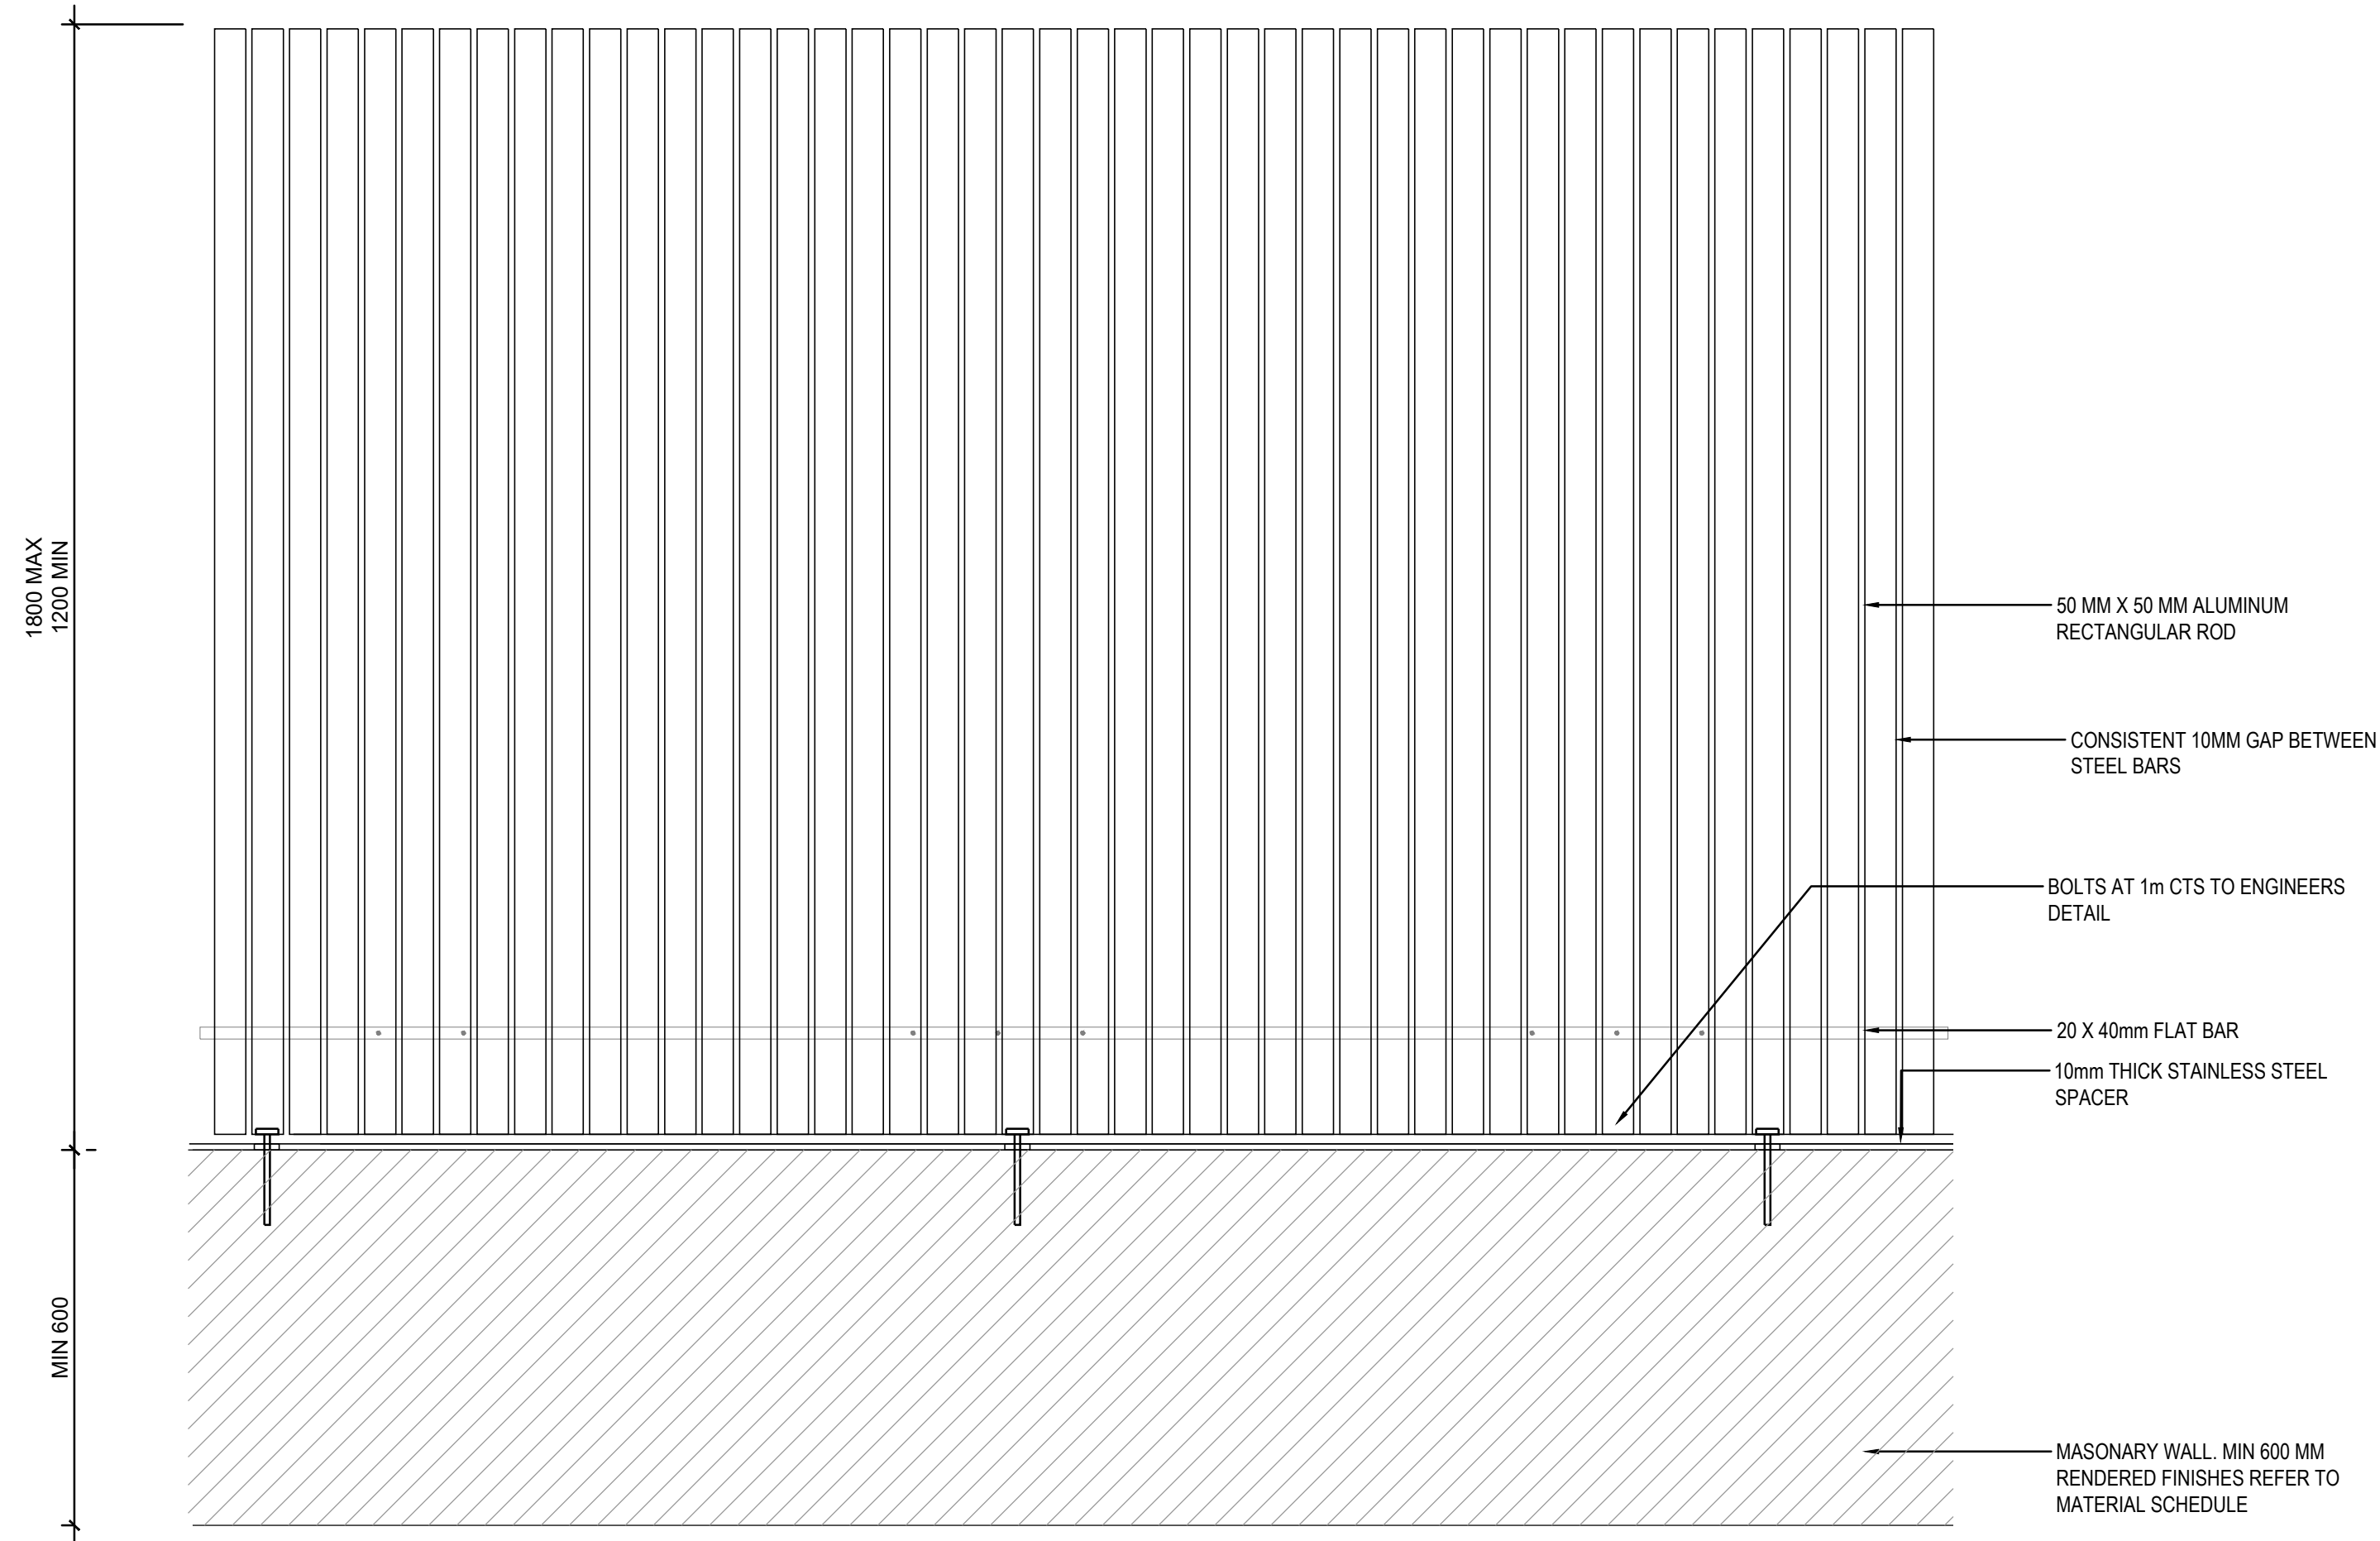
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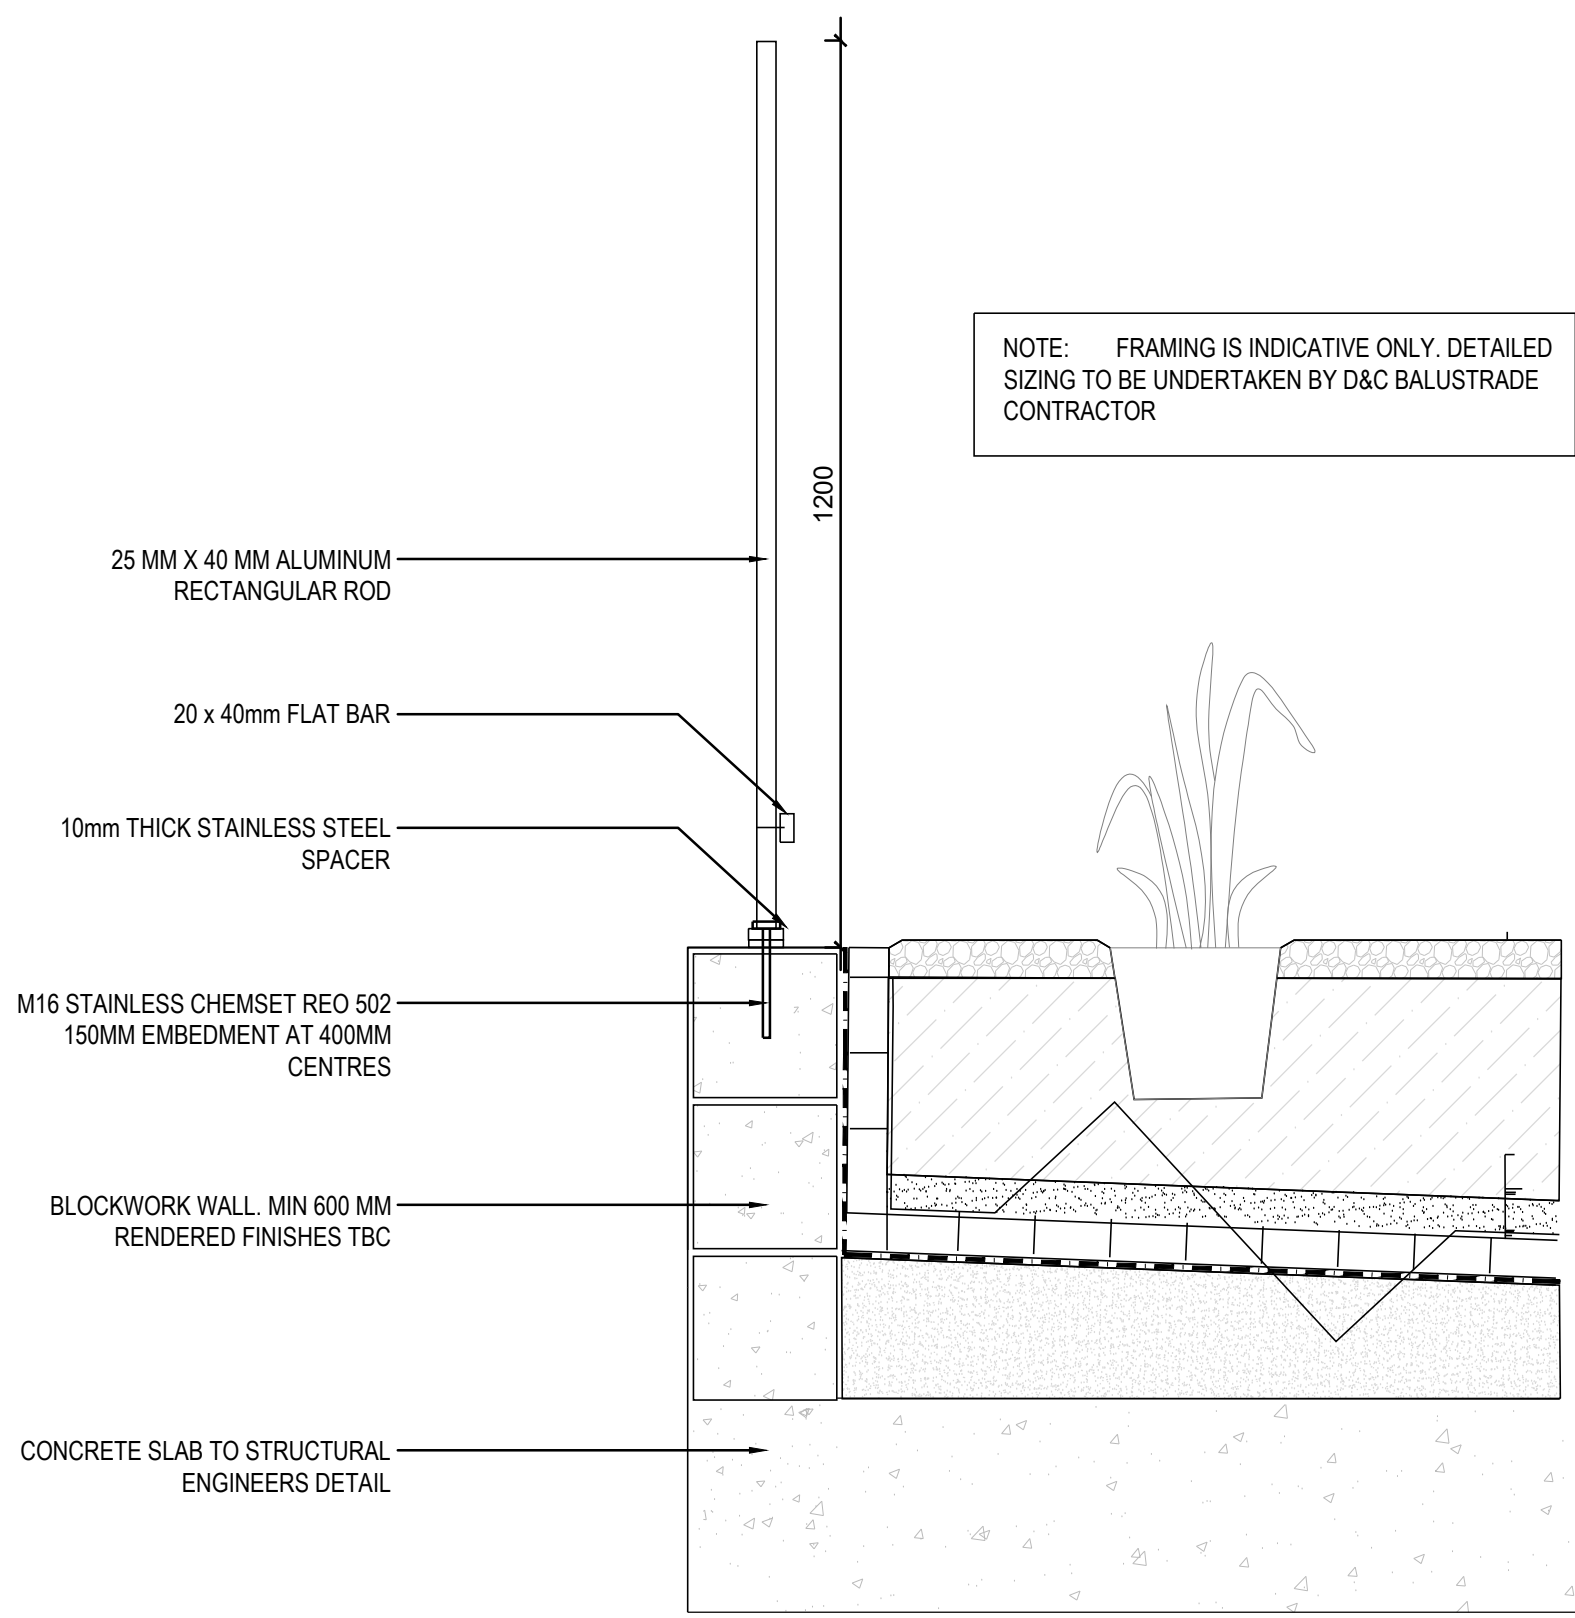




01 FC4 FENCE PLAN
1:10



02 FC4 FENCE ELEVATION
1:10



03 FC4 FENCE SECTION
1:10

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
HEATHCOTE GROUNDS
1-21 DILLWYNNIA
GROVE,
HEATHCOTE,
SUTHERLAND 2233 NSW


TITLE

FENCING DETAILS
SHEET FOUR


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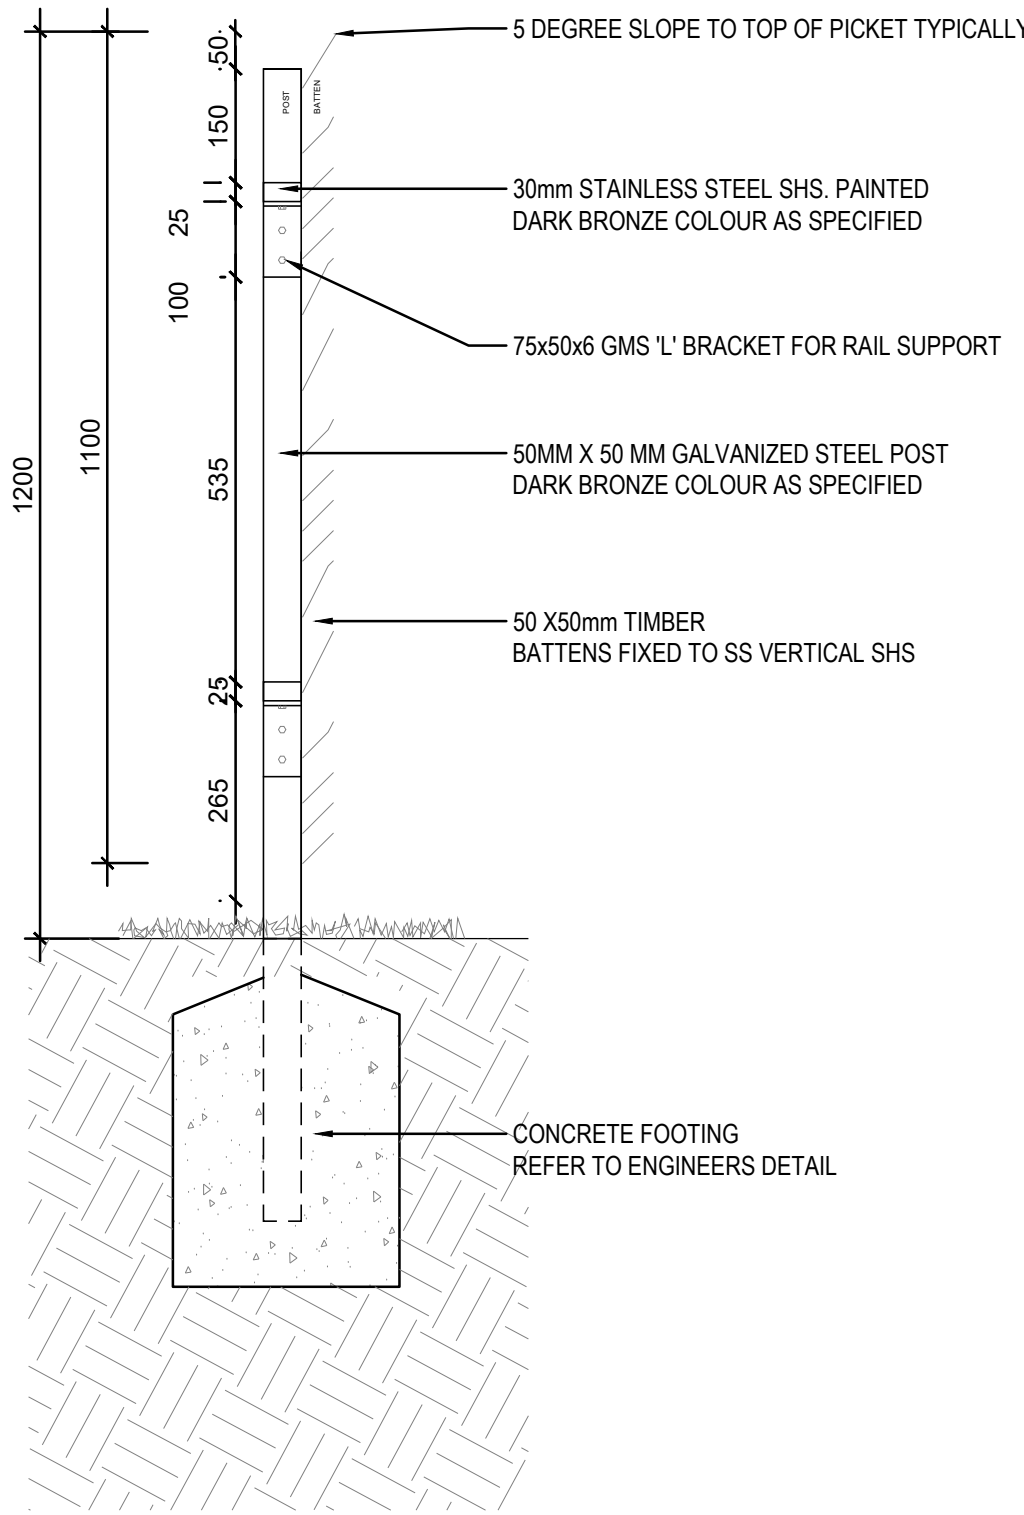
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	SCALES	AS SHOWN	
	PLOT DATE	20 January 2021	
	PROJECT N°.	P20-056	REVISION
	DRAWING N°.	LA-19	A
DRAWING STATUS		REVIEWED BY	SIGNATURE
		MD	DATE
S4.55 DEVELOPMENT APPLICATION			



01 FC5 FENCE PLAN
1:10

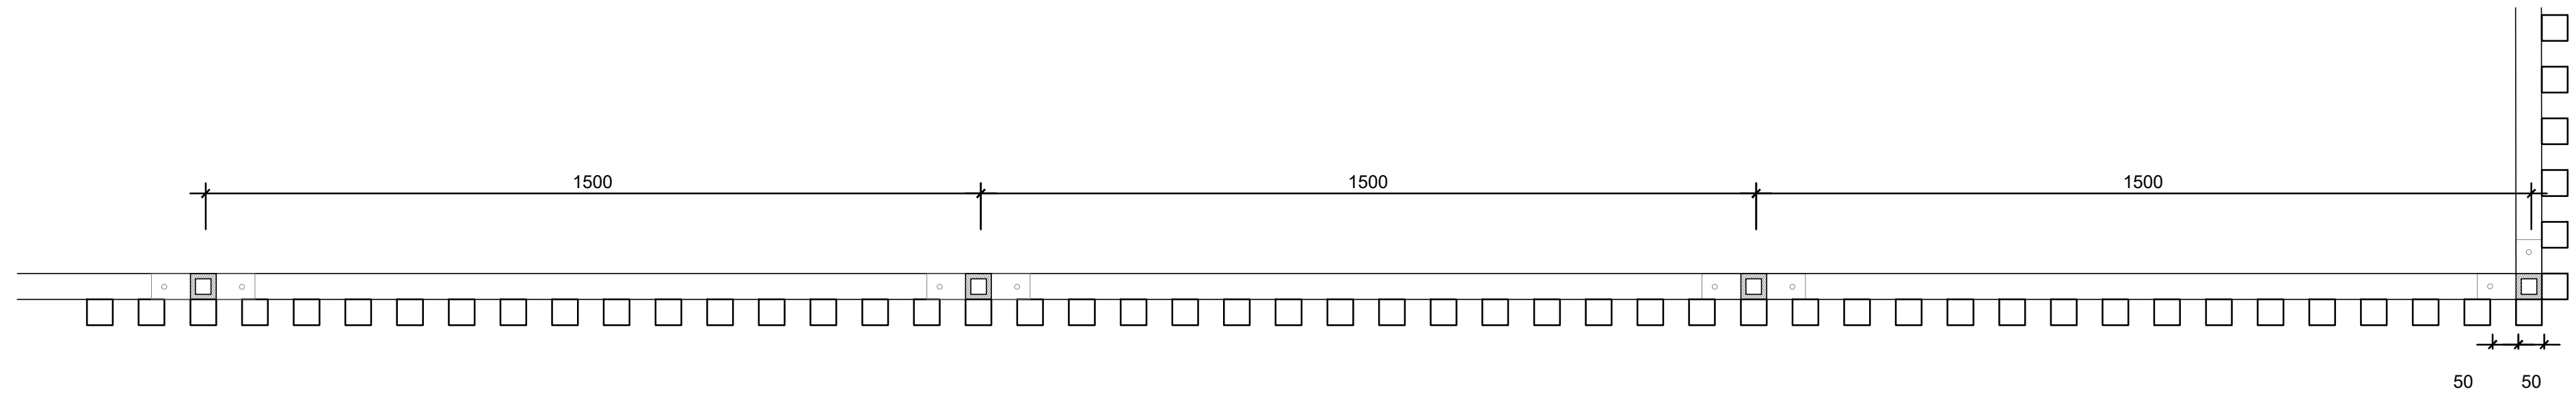

02 FC5 FENCE ELEVATION
1:10

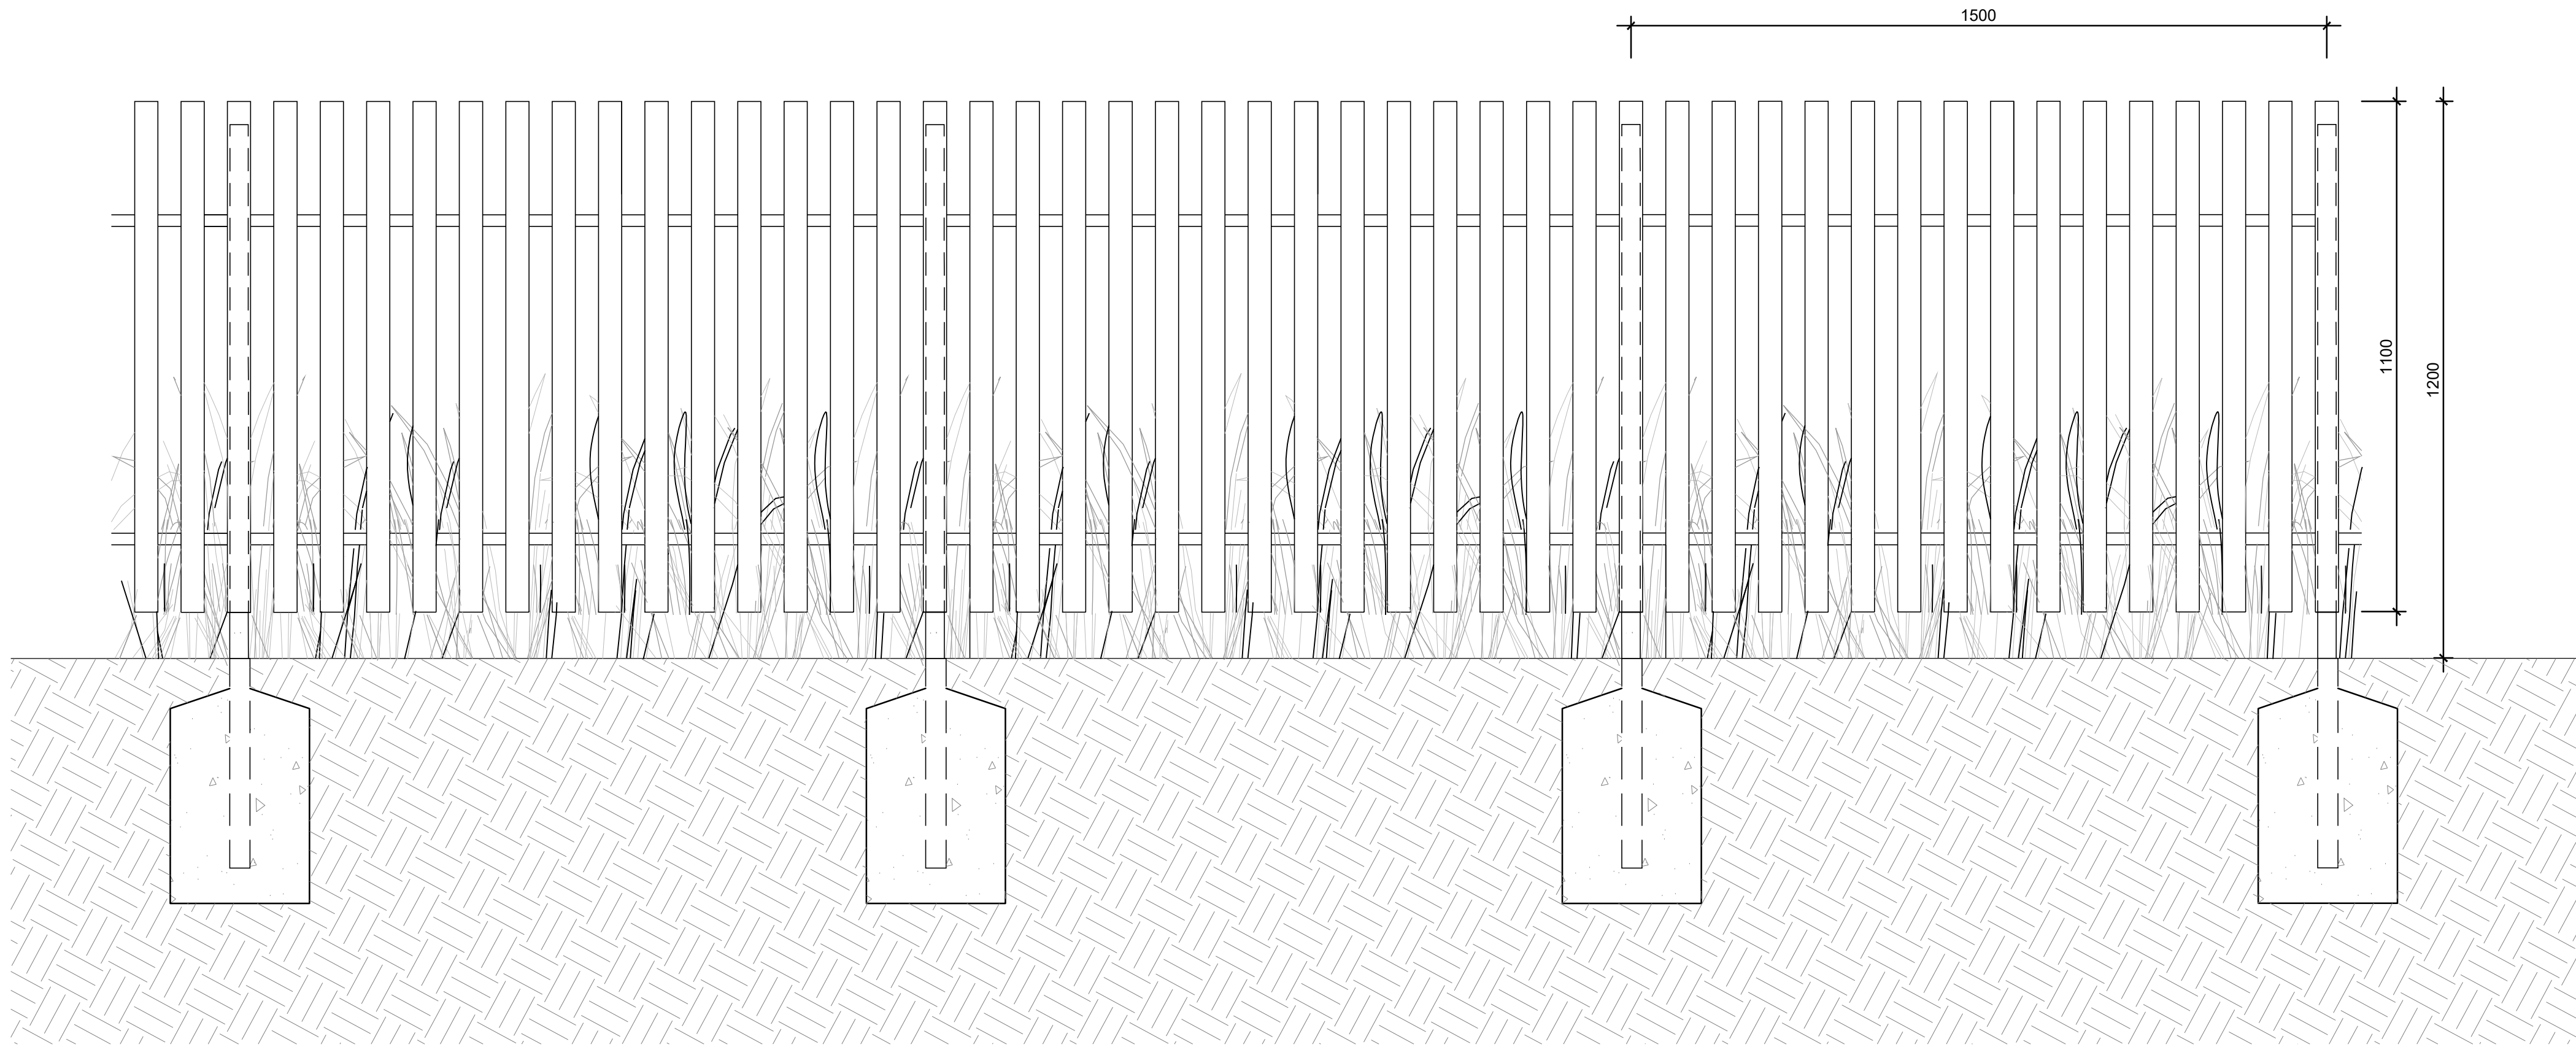

03 FC5 FENCE SECTION
1:10

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SUTHERLAND 2233 NSW

TITLE

FENCING DETAILS

SHEET FIVE

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PLOT DATE

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P20-056

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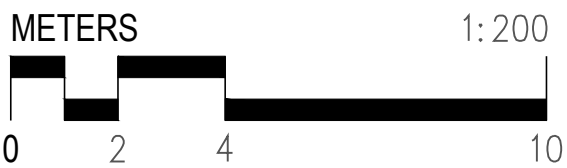
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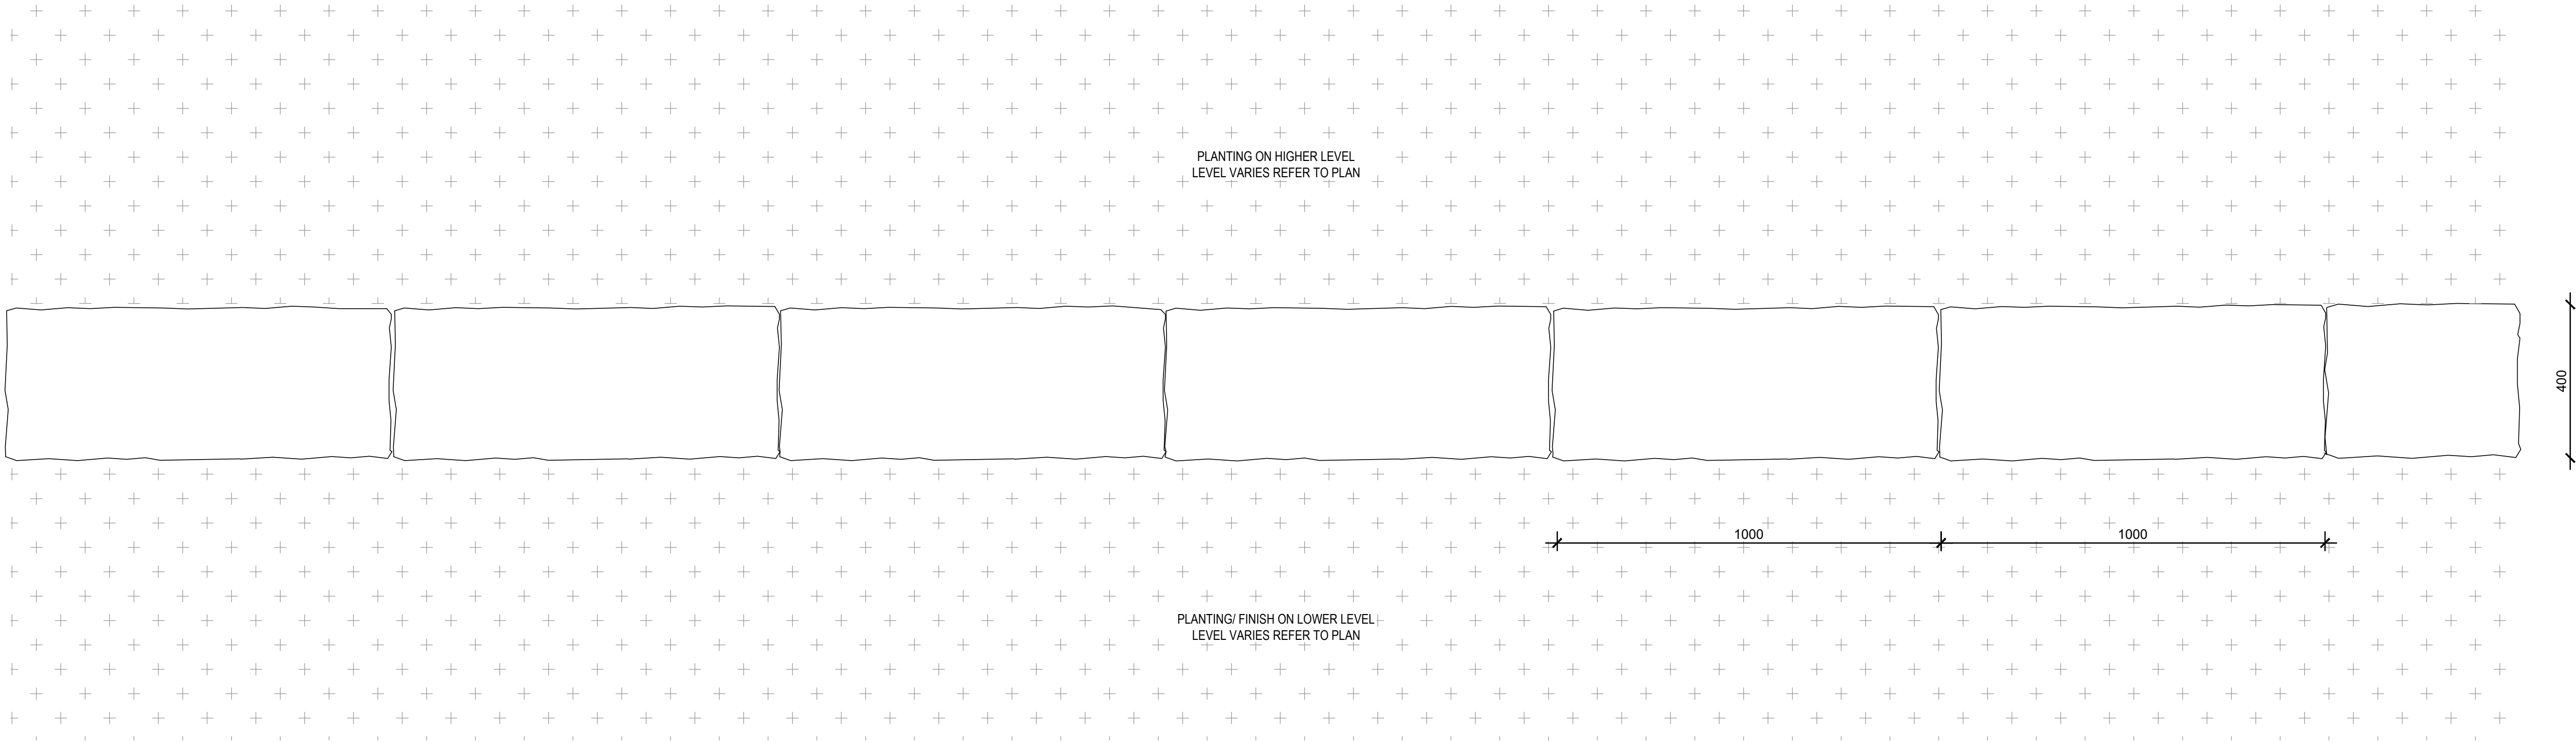
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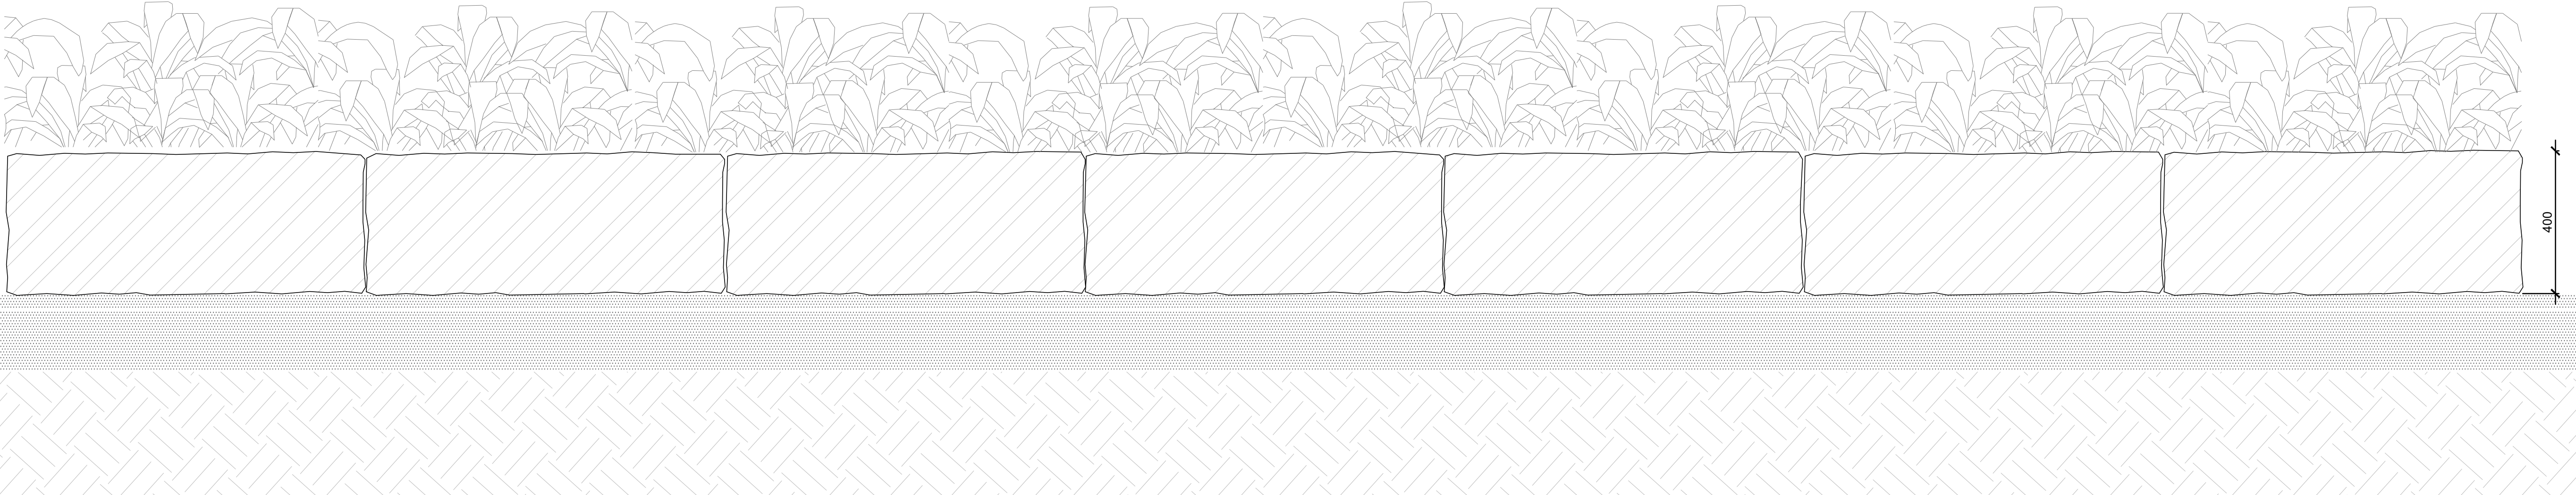
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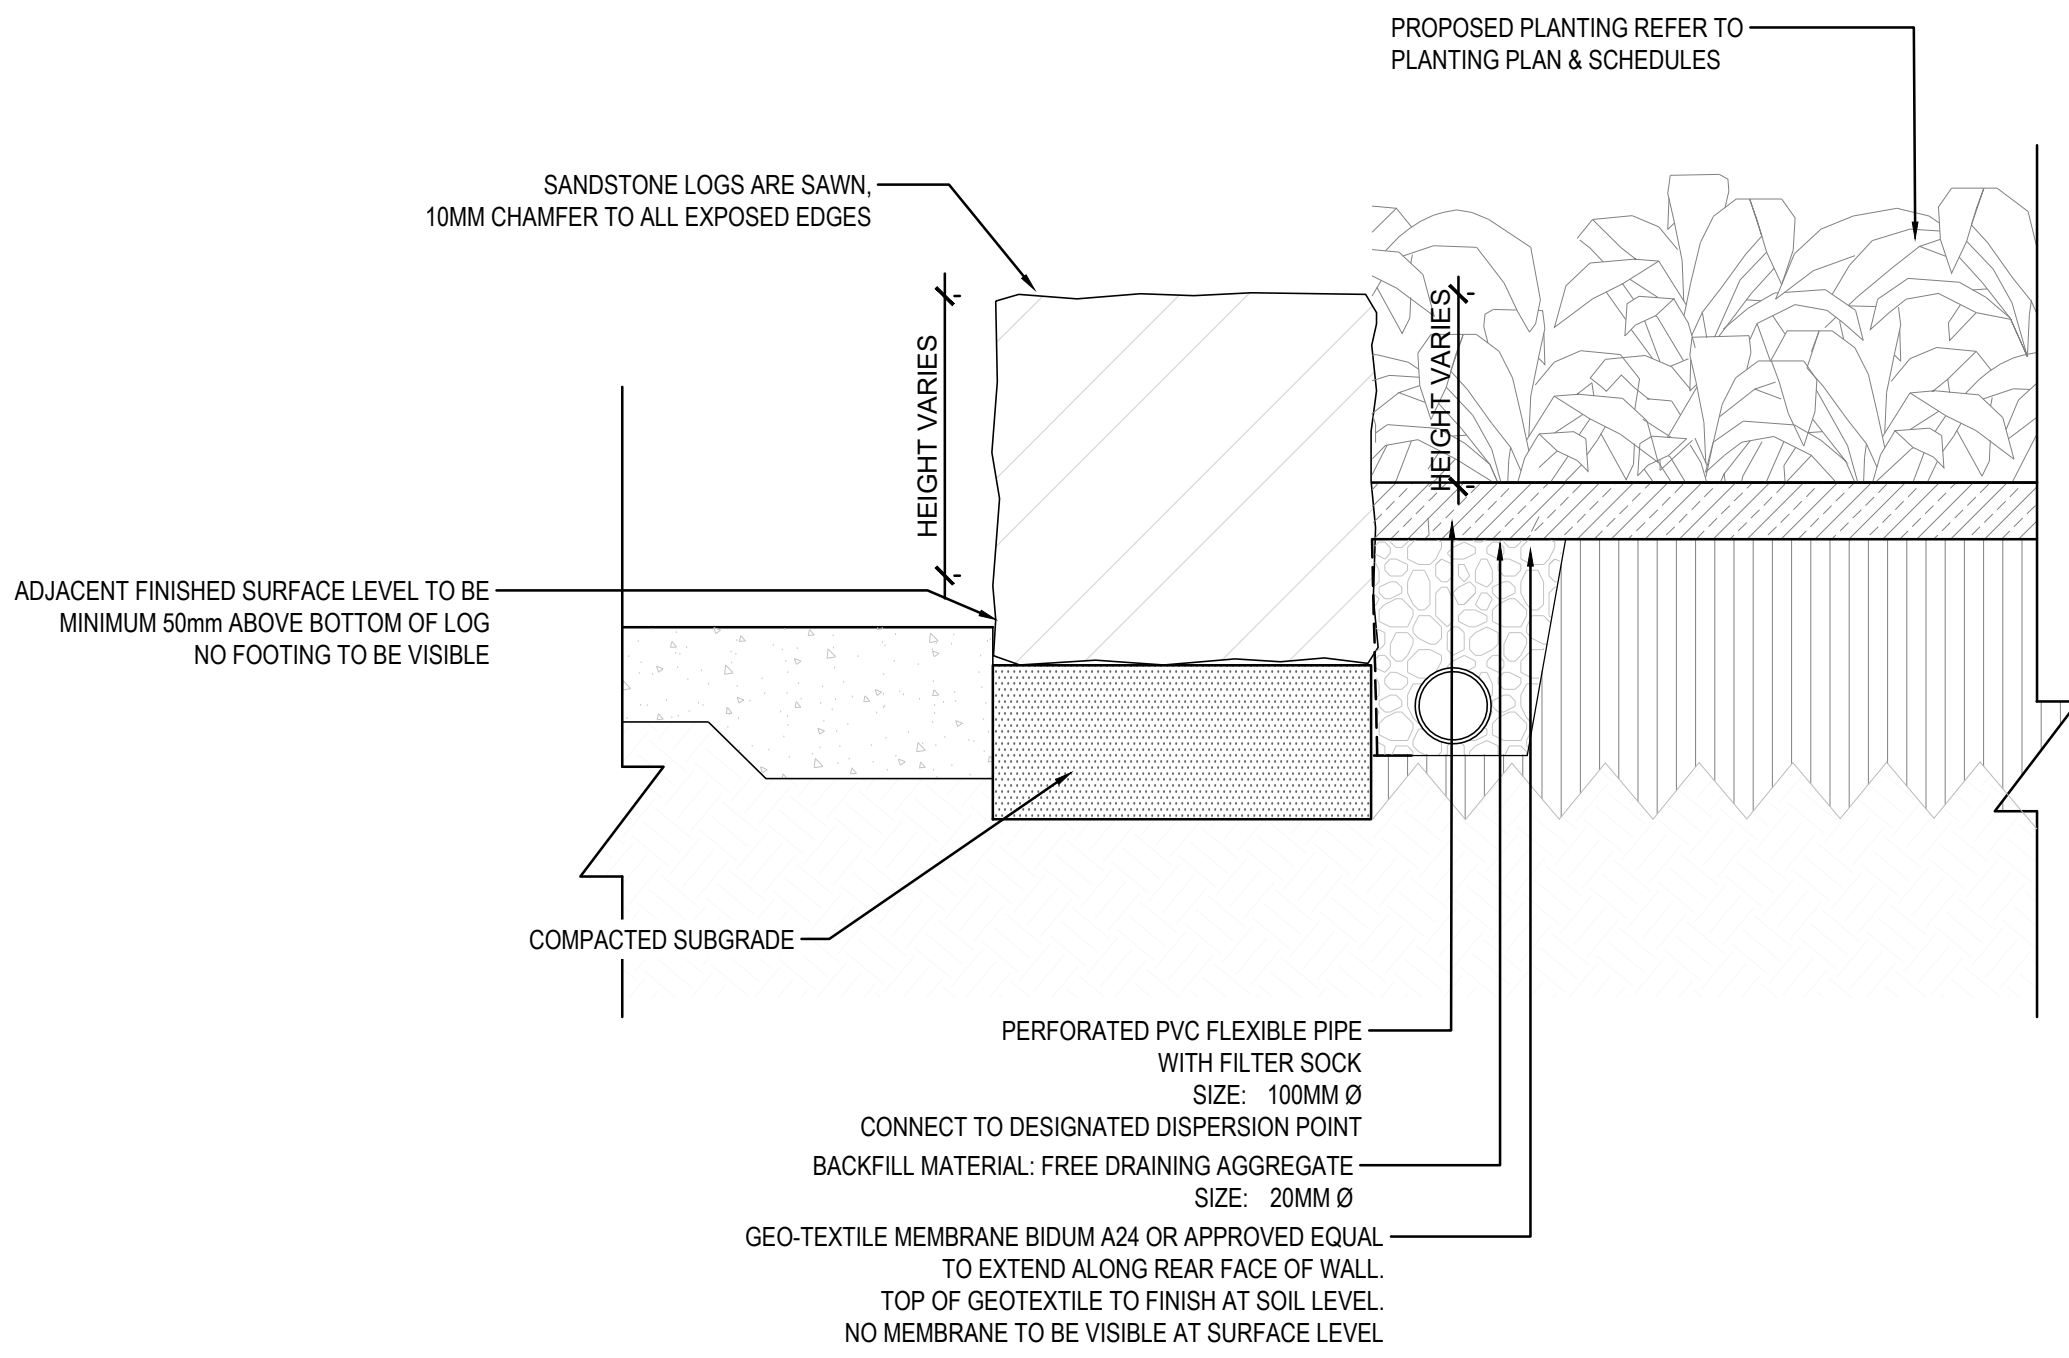





01 FC6 SANDSTONE LOG WALL PLAN
1:10



02 FC6 SANDSTONE LOG WALL ELEVATION
1:10



03 FC6 SANDSTONE LOG WALL SECTION WITH ADJACENT PAVING
1:10

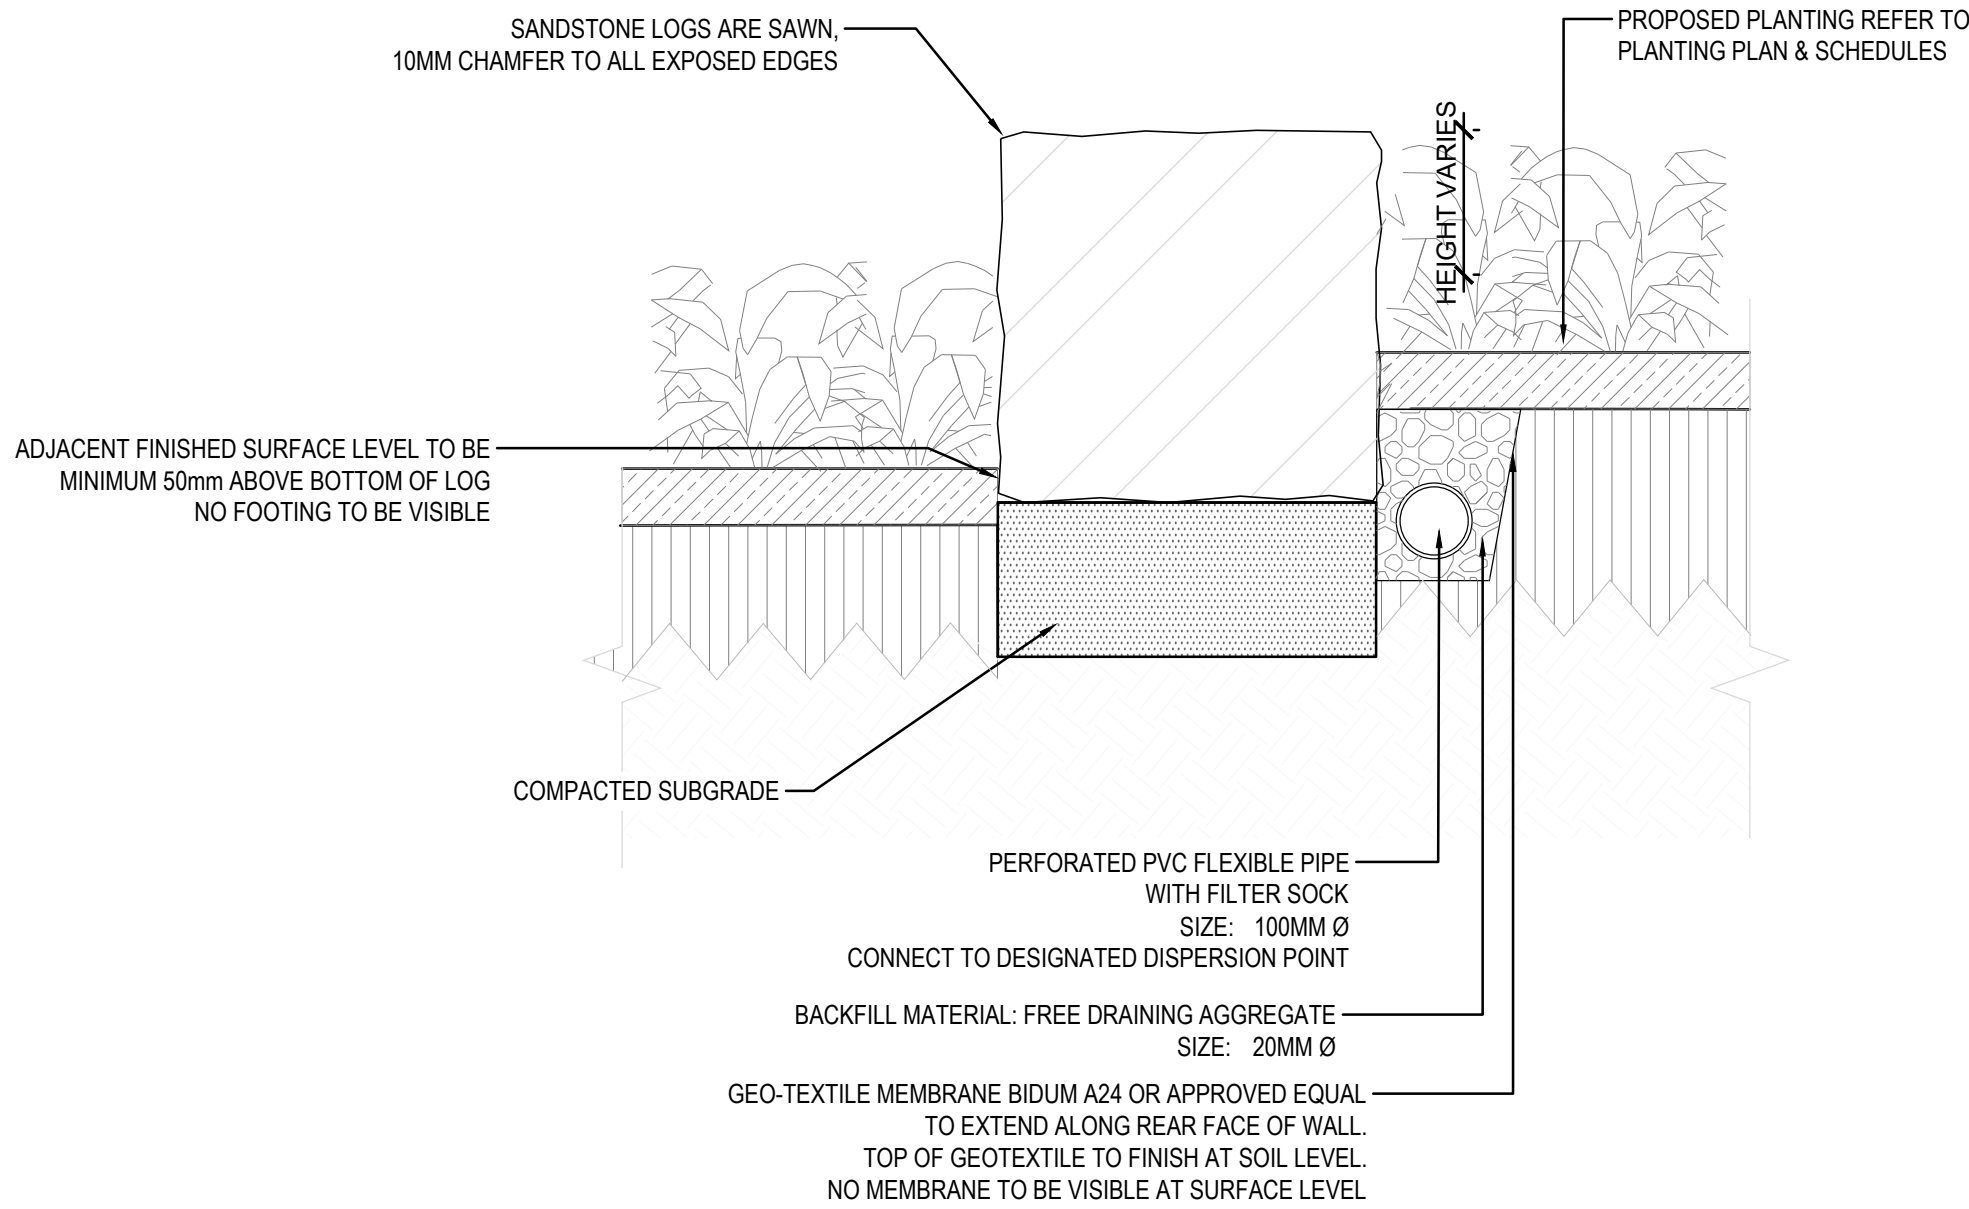

04 FC6 SANDSTONE LOG WALL SECTION WITH ADJACENT PLANTING BED
1:10

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SUTHERLAND 2233 NSW

TITLE

FENCING DETAILS
SHEET SIX

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PLOT DATE

20 January 2021

PROJECT N°.

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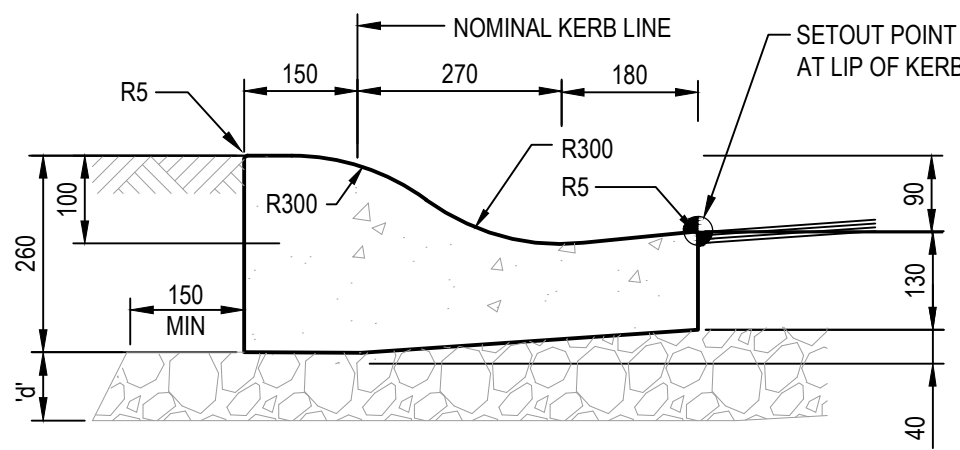
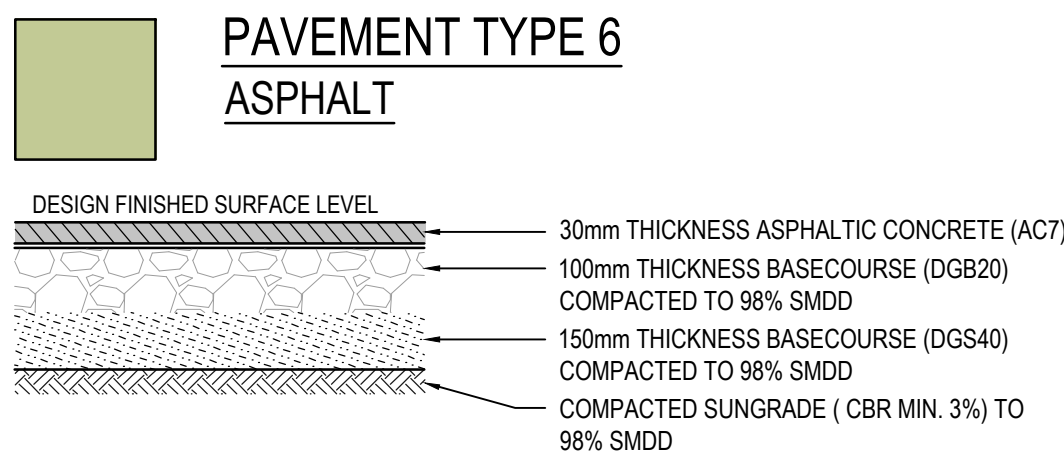
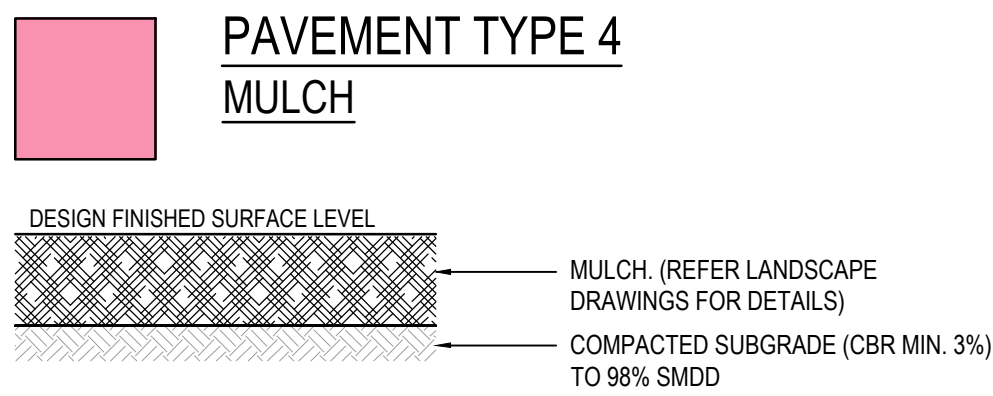
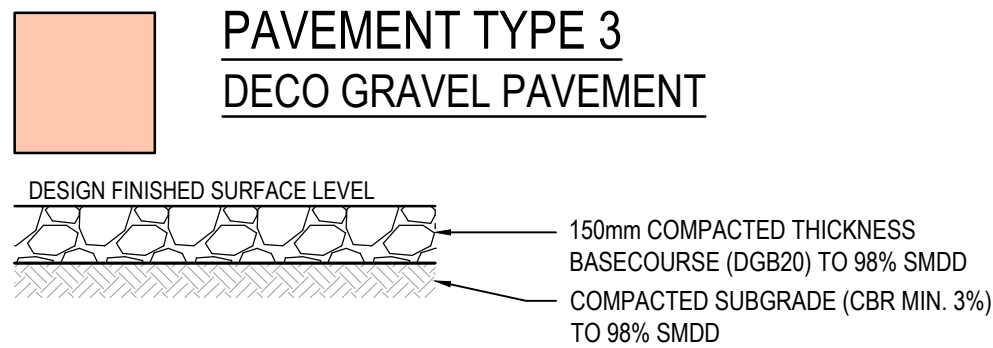
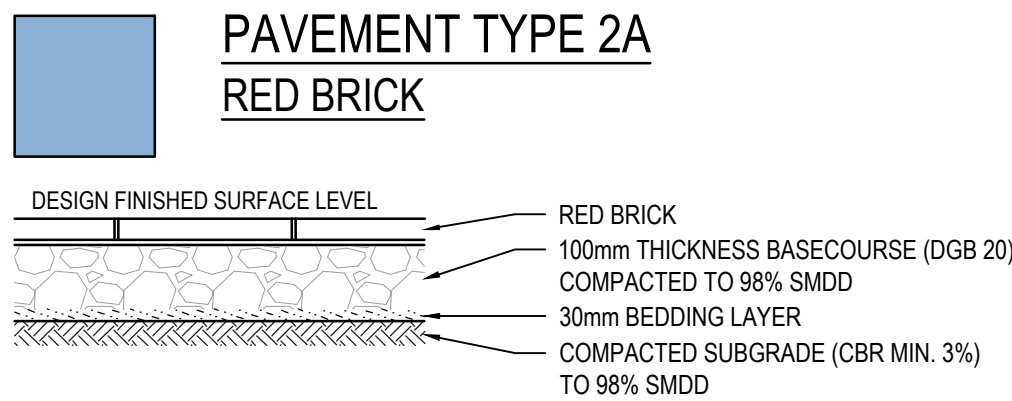
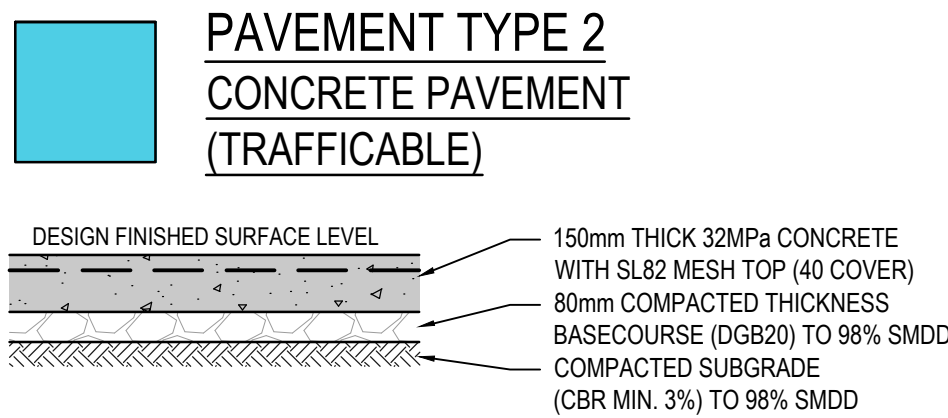
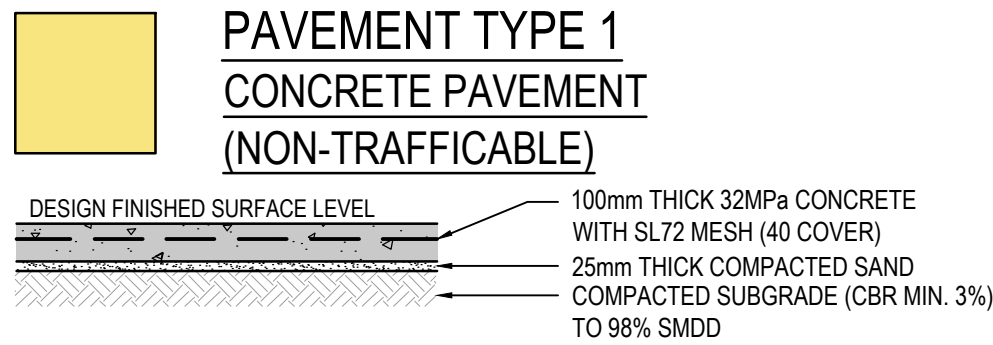
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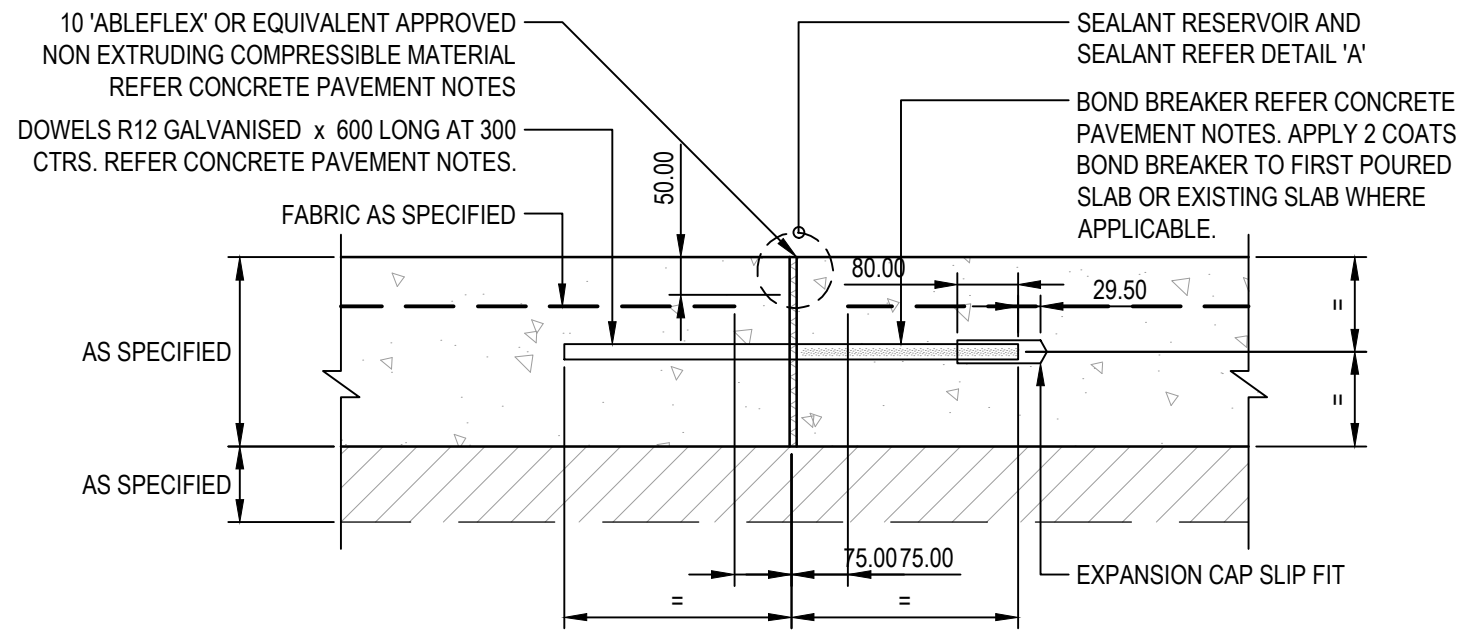
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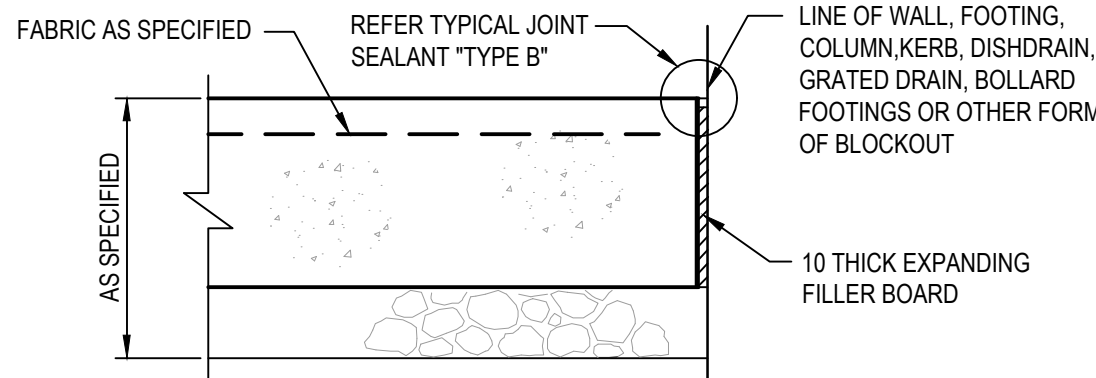
ROLL KERB AND GUTTER (RK&G)

SCALE 1:10
NOTE:
'd' = SUBBASE THICKNESS TO MATCH DEPTH OF PAVEMENT SUBBASE, BUT NOT LESS THAN 75





EXPANSION JOINT TYPE '2'

CONSTRUCTION AT POUR END
SCALE 1:10
SHOWN AS 'EJ2' ON PLAN




TYPICAL ISOLATION JOINT DETAIL

SHOWN AS 'IJ' ON PLAN AND TO ALSO BE CONSTRUCTED IN LOCATIONS WHERE CONCRETE PAVEMENTS ABUT FORMS OF BLOCKOUT AS SPECIFIED BY THIS ISOLATION JOINT DETAIL UNLESS NOTIFIED OTHERWISE.
N.T.S.

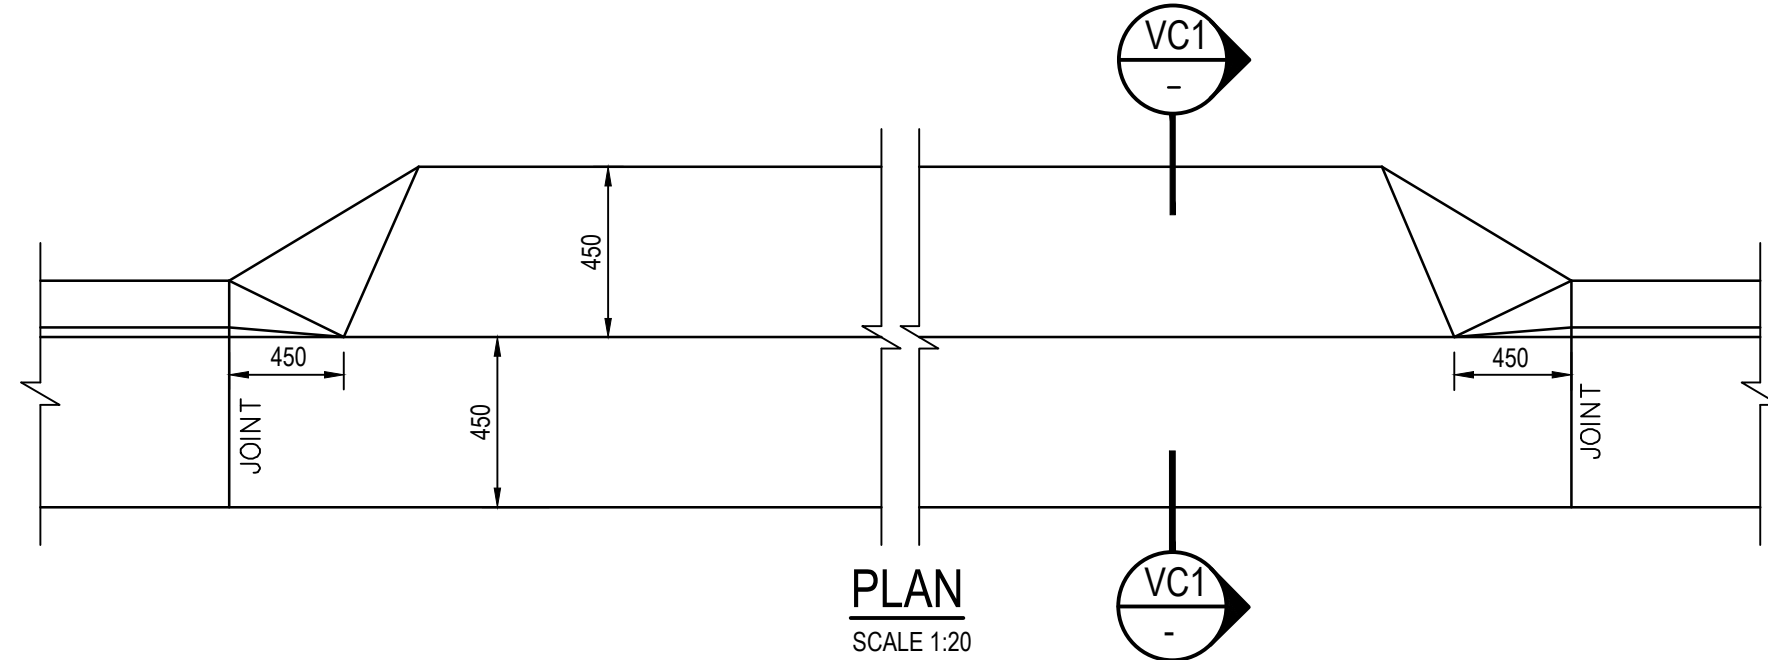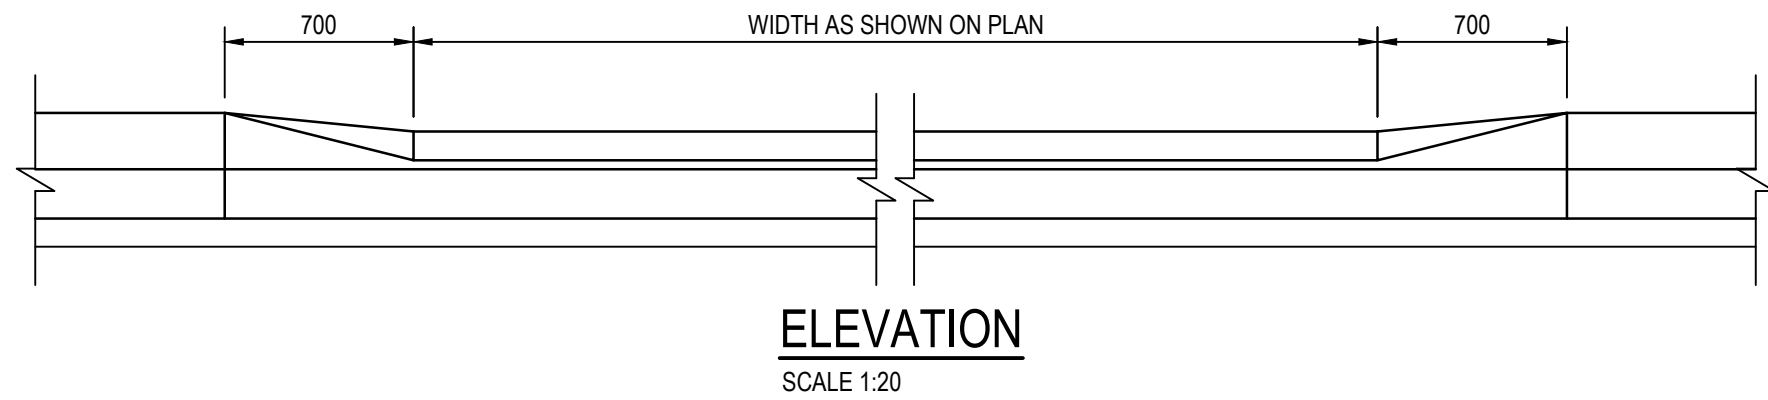


VEHICULAR CROSSING

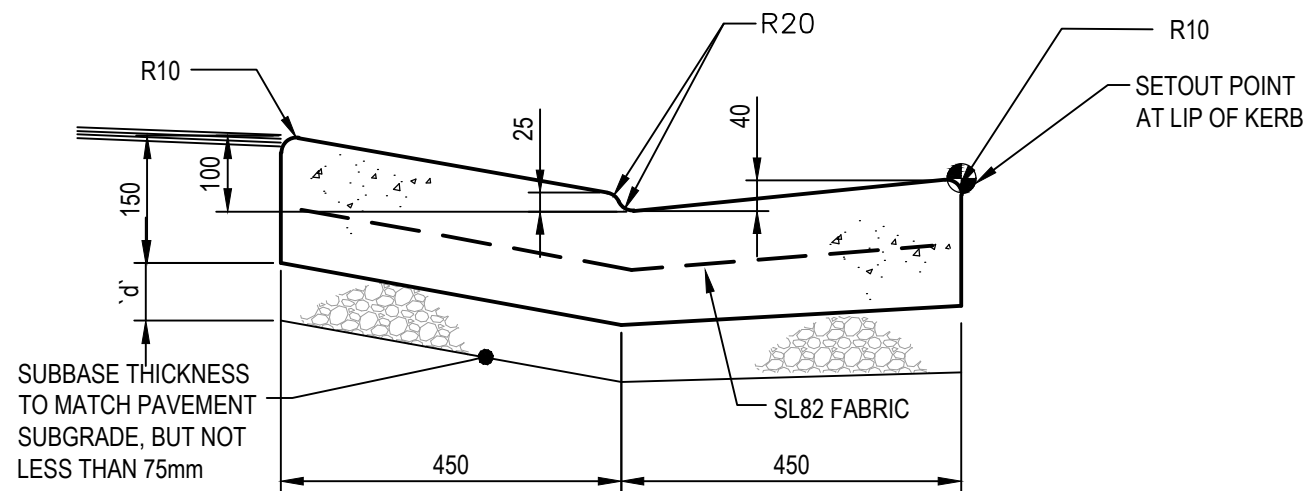

SECTION VC1


SCALE 1:10
SHOWN AS 'VC' ON PLAN
NOTE:
'd' = SUBBASE THICKNESS TO MATCH DEPTH OF PAVEMENT SUBBASE, BUT NOT LESS THAN 75

NOTES:
1. CONSTRUCT 10mm WIDE FULL DEPTH EXPANDING FILLER BOARD JOINTS WITH TYPE 'B' JOINT SEALANT TO BE PLACED AT NO MORE THAN 6m AND NOT LESS THAN 4m INTERVALS.
2. INDICATED ON PLAN WHERE DOWELS ARE REQUIRED.

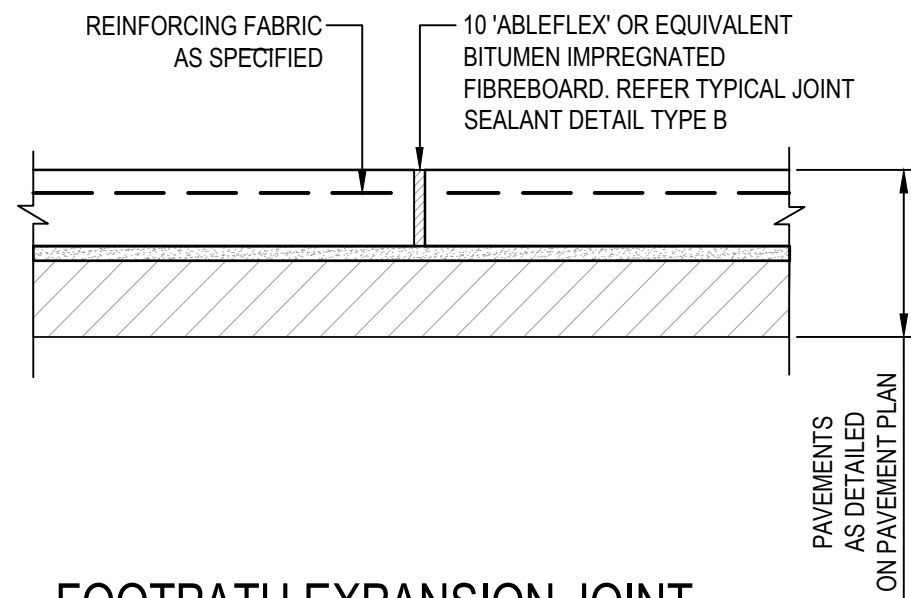

FOOTPATH EXPANSION JOINT

SHOWN AS 'EJ' ON 'TYPICAL JOINT PLAN FOR FOOTPATHS' DETAIL
SCALE 1:10

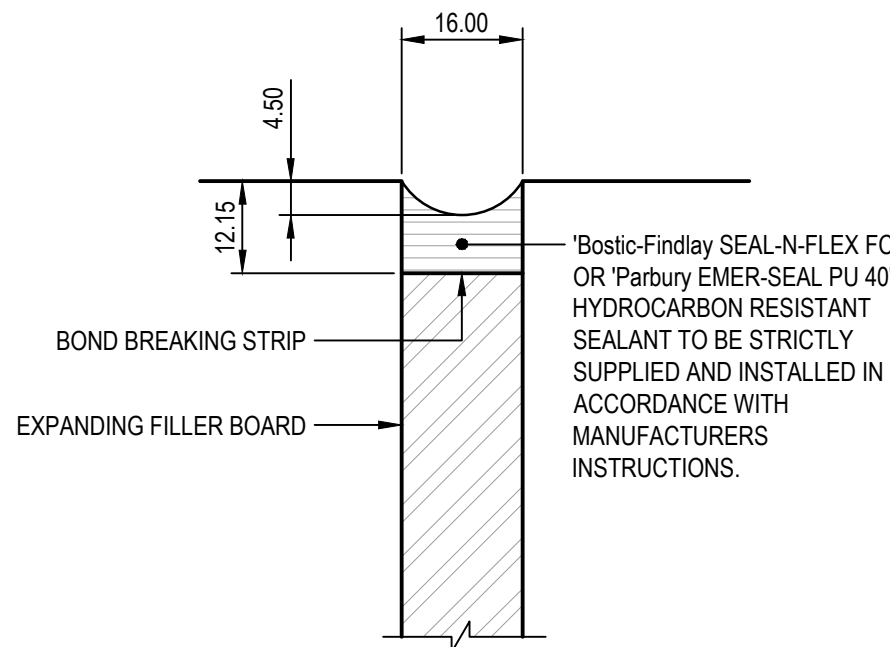

TYPICAL JOINT SEALANT TYPE 'B'

SCALE 1:1
NOTE: REFER SPECIFICATION FOR SEALANT TYPES WHICH SHALL BE SUPPLIED AND INSTALLED STRICTLY WITH MANUFACTURERS INSTRUCTIONS

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03	ISSUED FOR TENDER	16.12.20
02	ISSUED FOR TENDER	10.12.20
01	ISSUED FOR TENDER	27.11.20
Rev	Revision Description	Date

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www.scpsconsult.com.au

Client
PARITER PTY LTD

Project
**HEATHCOTE GROUNDS
MAIN WORKS**

Title
SITWORKS DETAILS

Scale
AS SHOWN AT A1

Drawn JE	Checked BK	Approved JC	Project Number S201117	Drawing Number C-03-51	Revision 03
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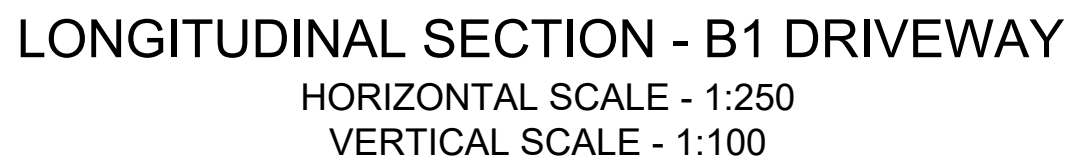



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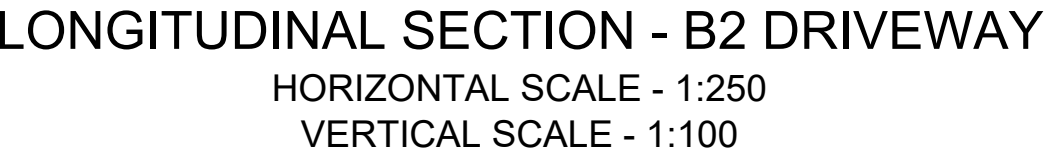
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Project Number	Drawing Number	Revision
S201117	C-04-11	03



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Client PARITER PTY LTD			
Project HEATHCOTE GROUNDS MAIN WORKS			
Title DRIVEWAY LONG SECTIONS - SHEET 01 OF 03			
Scale AS SHOWN AT A1			
Drawn JE	Checked BK	Approved JC	
Project Number S201117			Revision 03
Drawing Number C-04-21			




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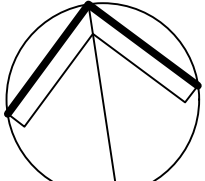
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507 Kent St Sydney NSW 2000
ABN 80 003 076 024


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www.scpsconsult.com.au

Client PARITER PTY LTD			
Project HEATHCOTE GROUNDS MAIN WORKS			
Title DRIVEWAY LONG SECTIONS - SHEET 02 OF 03			
Scale AS SHOWN AT A1			
Drawn JE	Checked BK	Approved JC	
Project Number S201117		Drawing Number C-04-22	Revision 03

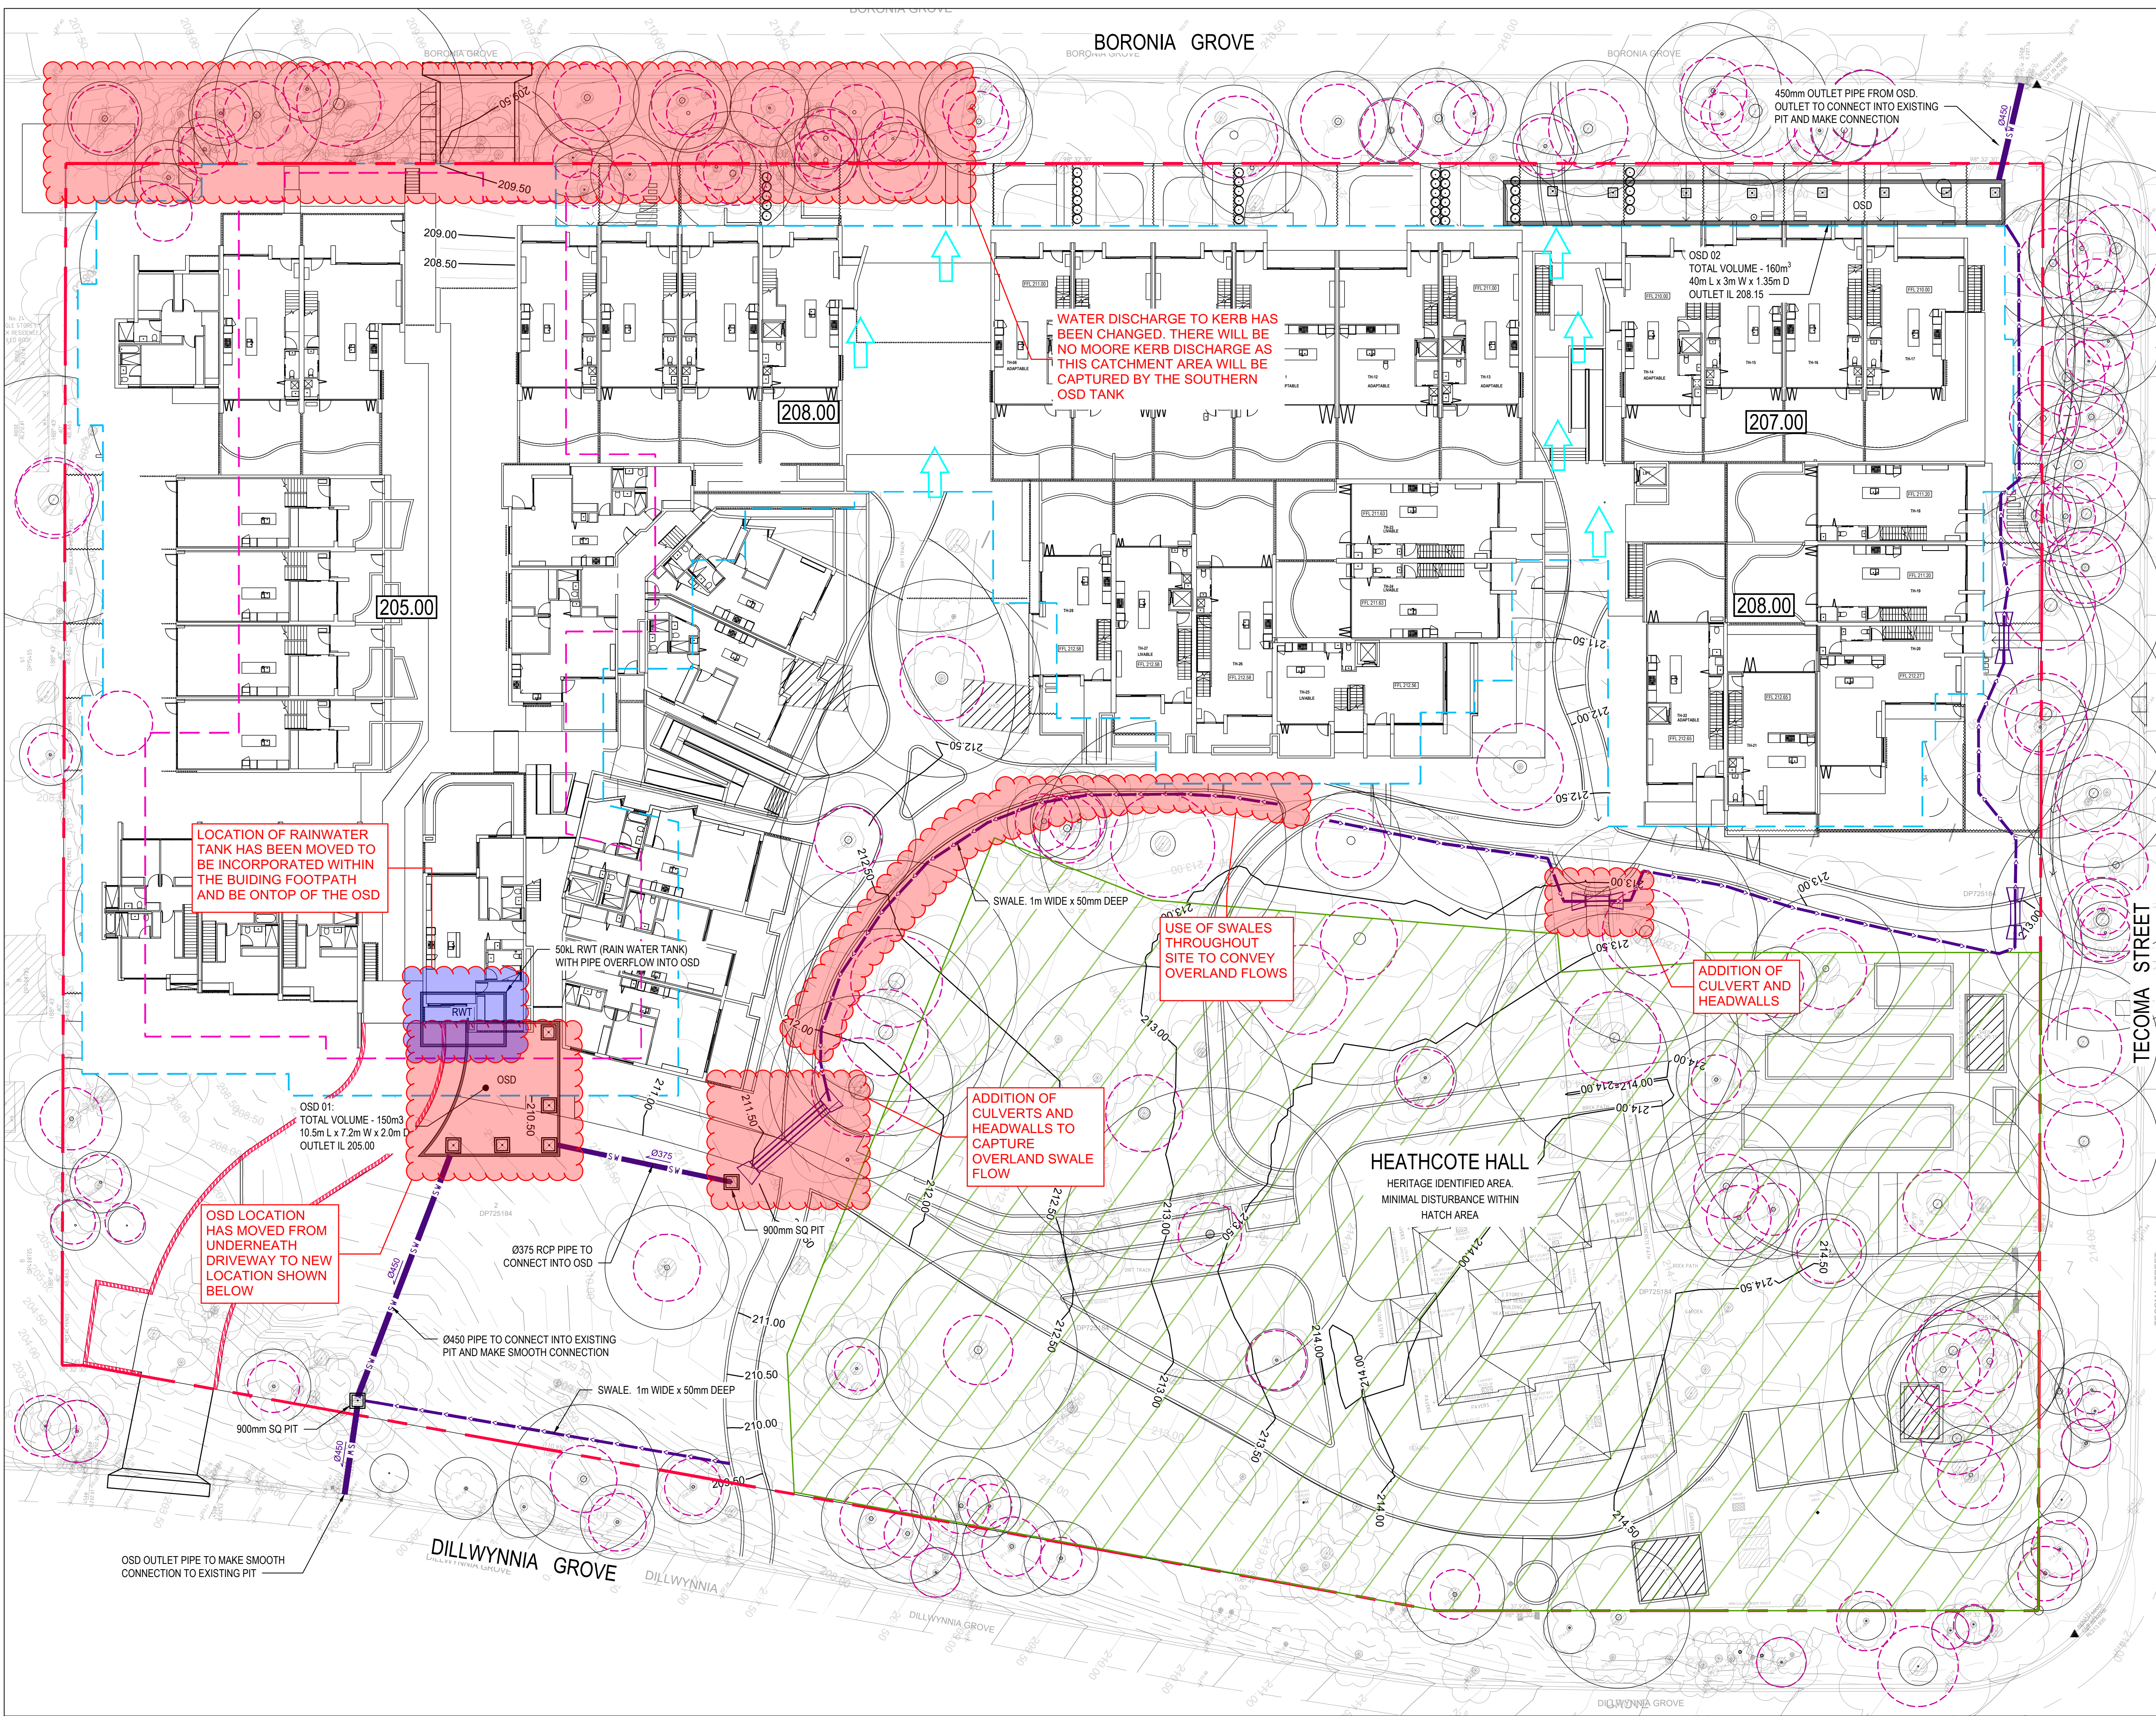


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Rev	Revision Description	Date
04	ISSUED FOR TENDER	16.12.20
03	ISSUED FOR TENDER	10.12.20
02	ISSUED FOR TENDER	27.11.20
01	ISSUED FOR INFORMATION	23.11.20

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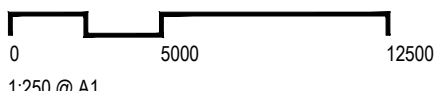
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Client: **PARITER PTY LTD**


Project: **HEATHCOTE GROUNDS MAIN WORKS**

Title: **STORMWATER DRAINAGE LAYOUT PLAN**

Scale: 
0 5000 12500
1:250 @ A1

Drawn	Checked	Approved	Revision
JE	BK	JC	04

Project Number: **S201117** Drawing Number: **C-05-01**

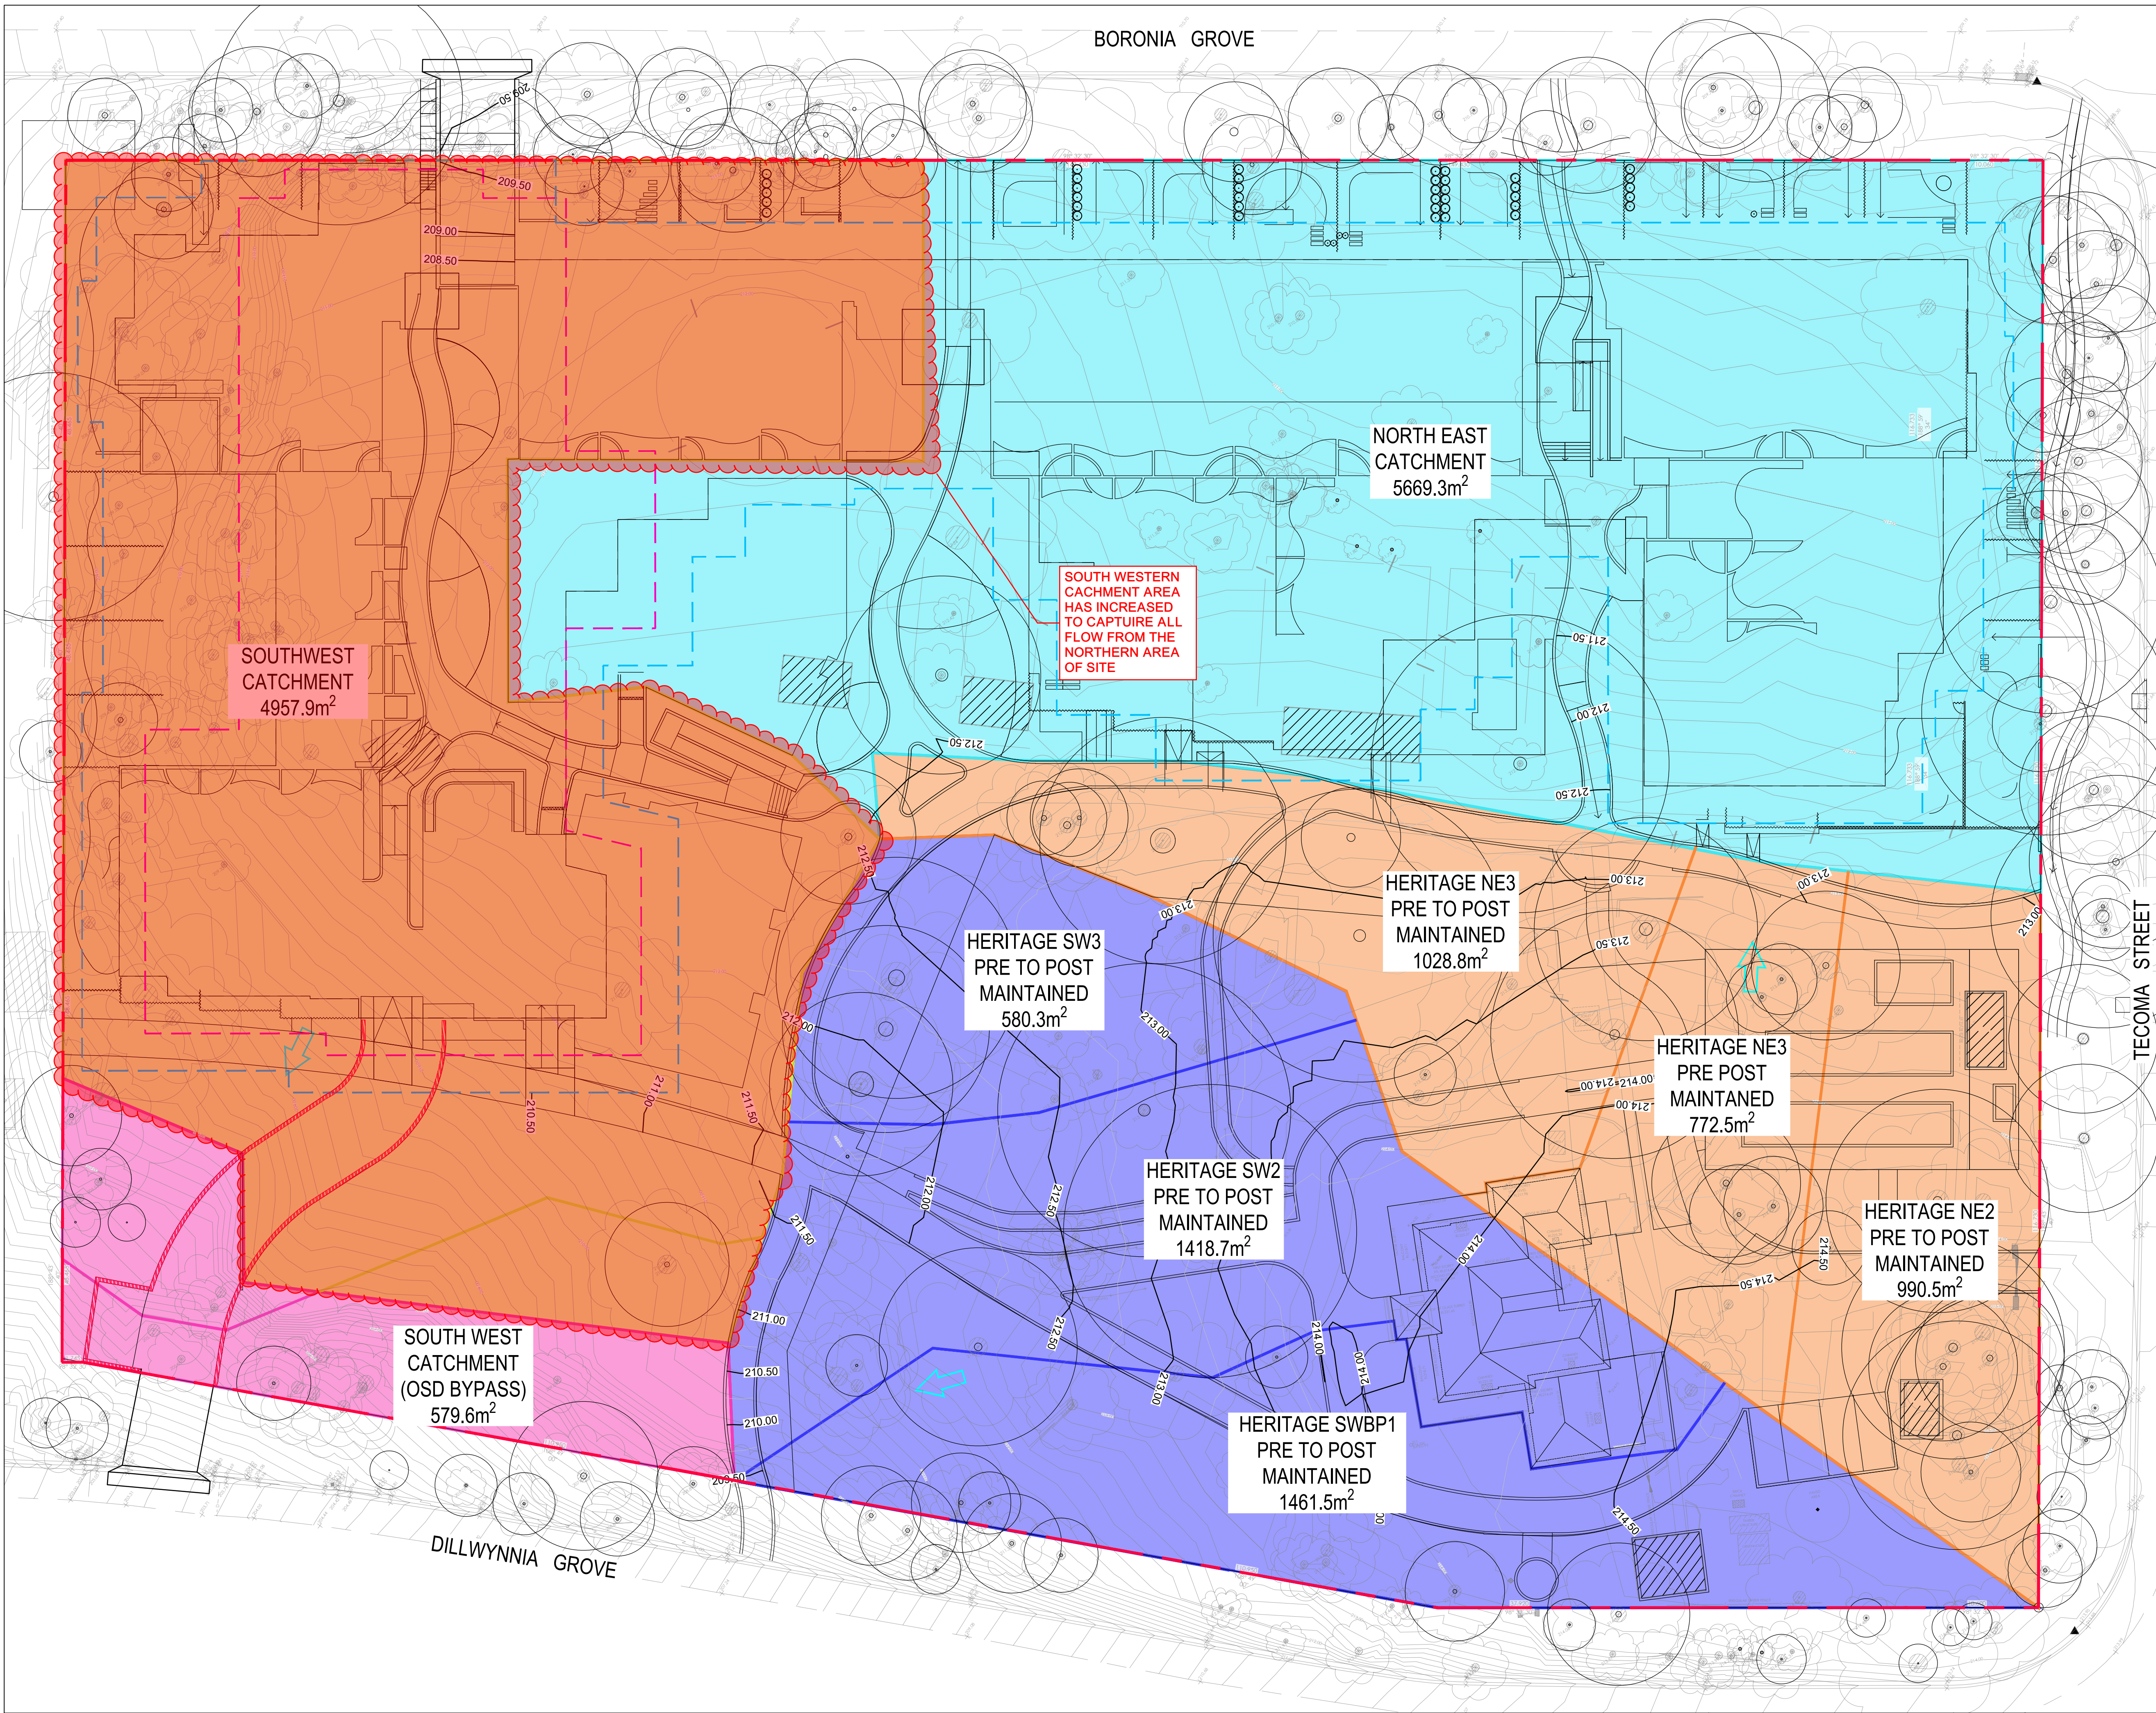

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Rev	Revision Description	Date

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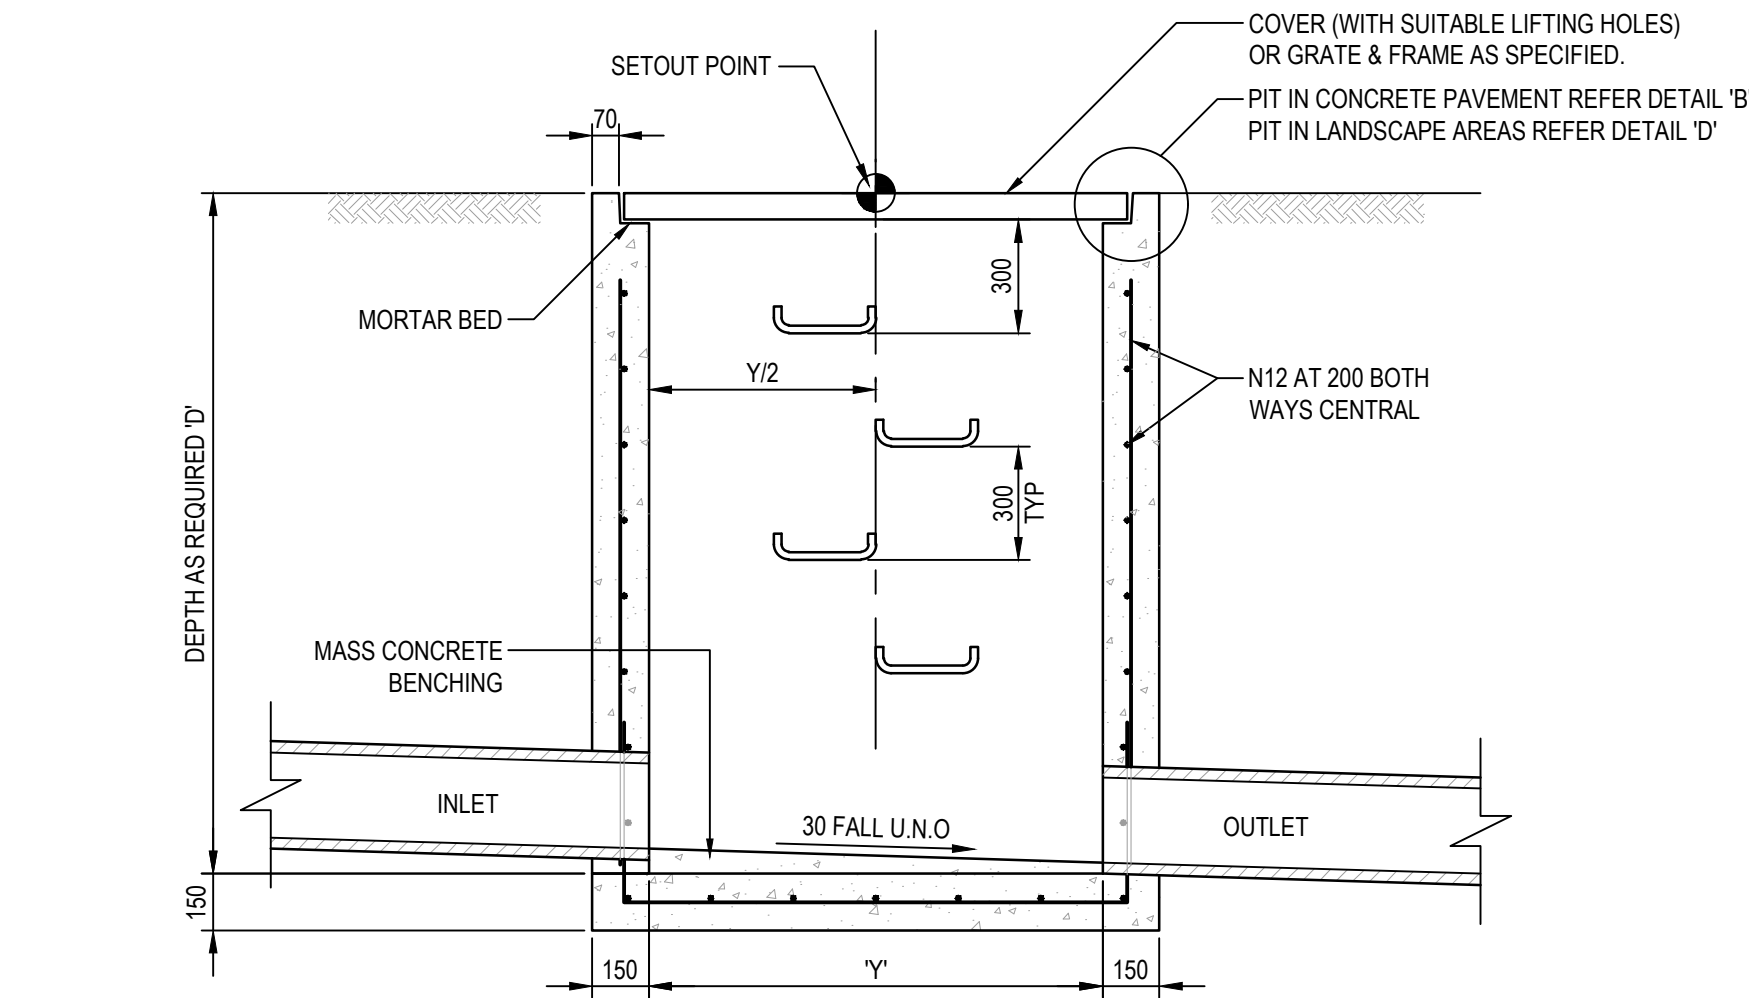
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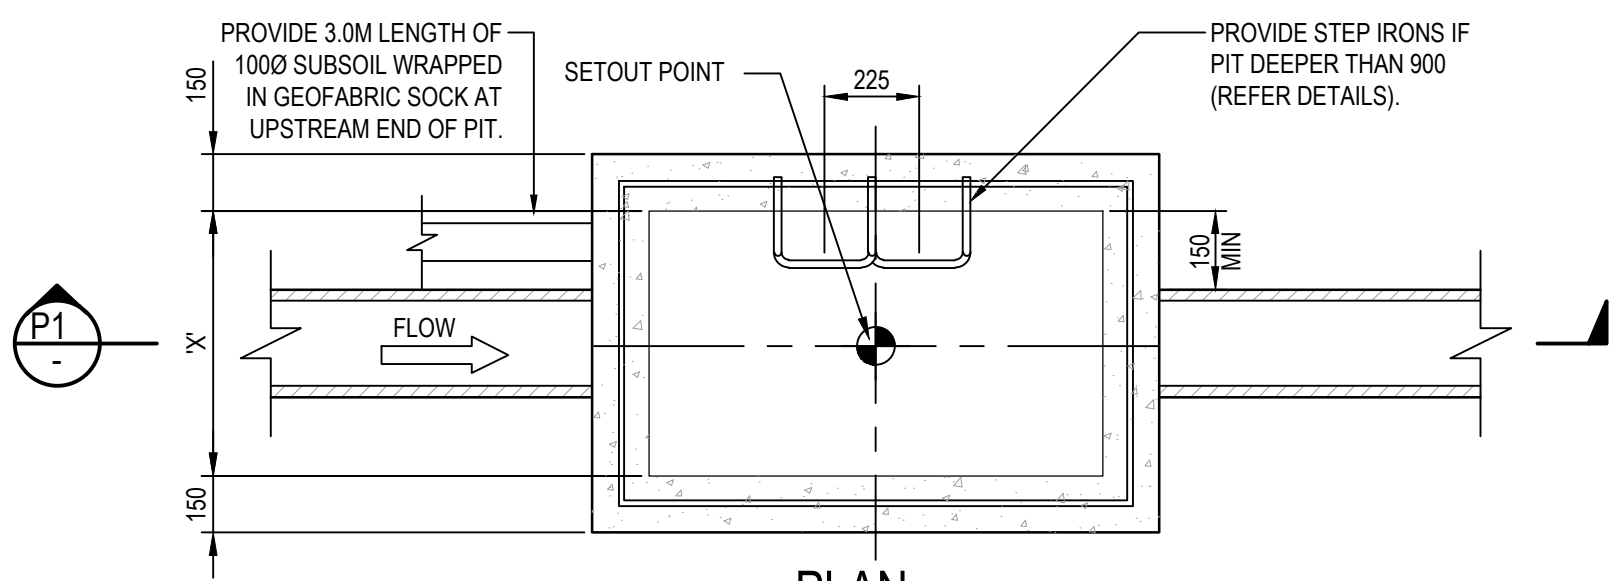
Project
**HEATHCOTE GROUNDS
MAIN WORKS**

Title
STORMWATER CATCHMENT PLAN

Scale 0 1250 @ A1 5000 12500		
Drawn JE	Checked BK	Approved JC
Project Number S201117	Drawing Number C-05-21	Revision 03




SECTION P1
SCALE 1:20



PLAN
SURFACE INLET/JUNCTION PIT
SCALE 1:20

MINIMUM INTERNAL PIT DIMENSIONS		
'D'	'X'	'Y'
D ≤ 600	450	450*
D ≤ 900	600	600*
D ≤ 1200	600	900
D > 1200	900	900


NOTE: PITS DENOTED * SHALL BE USED ONLY WHERE SPECIFIED IN DRAINAGE SCHEDULE OR ON PLAN.

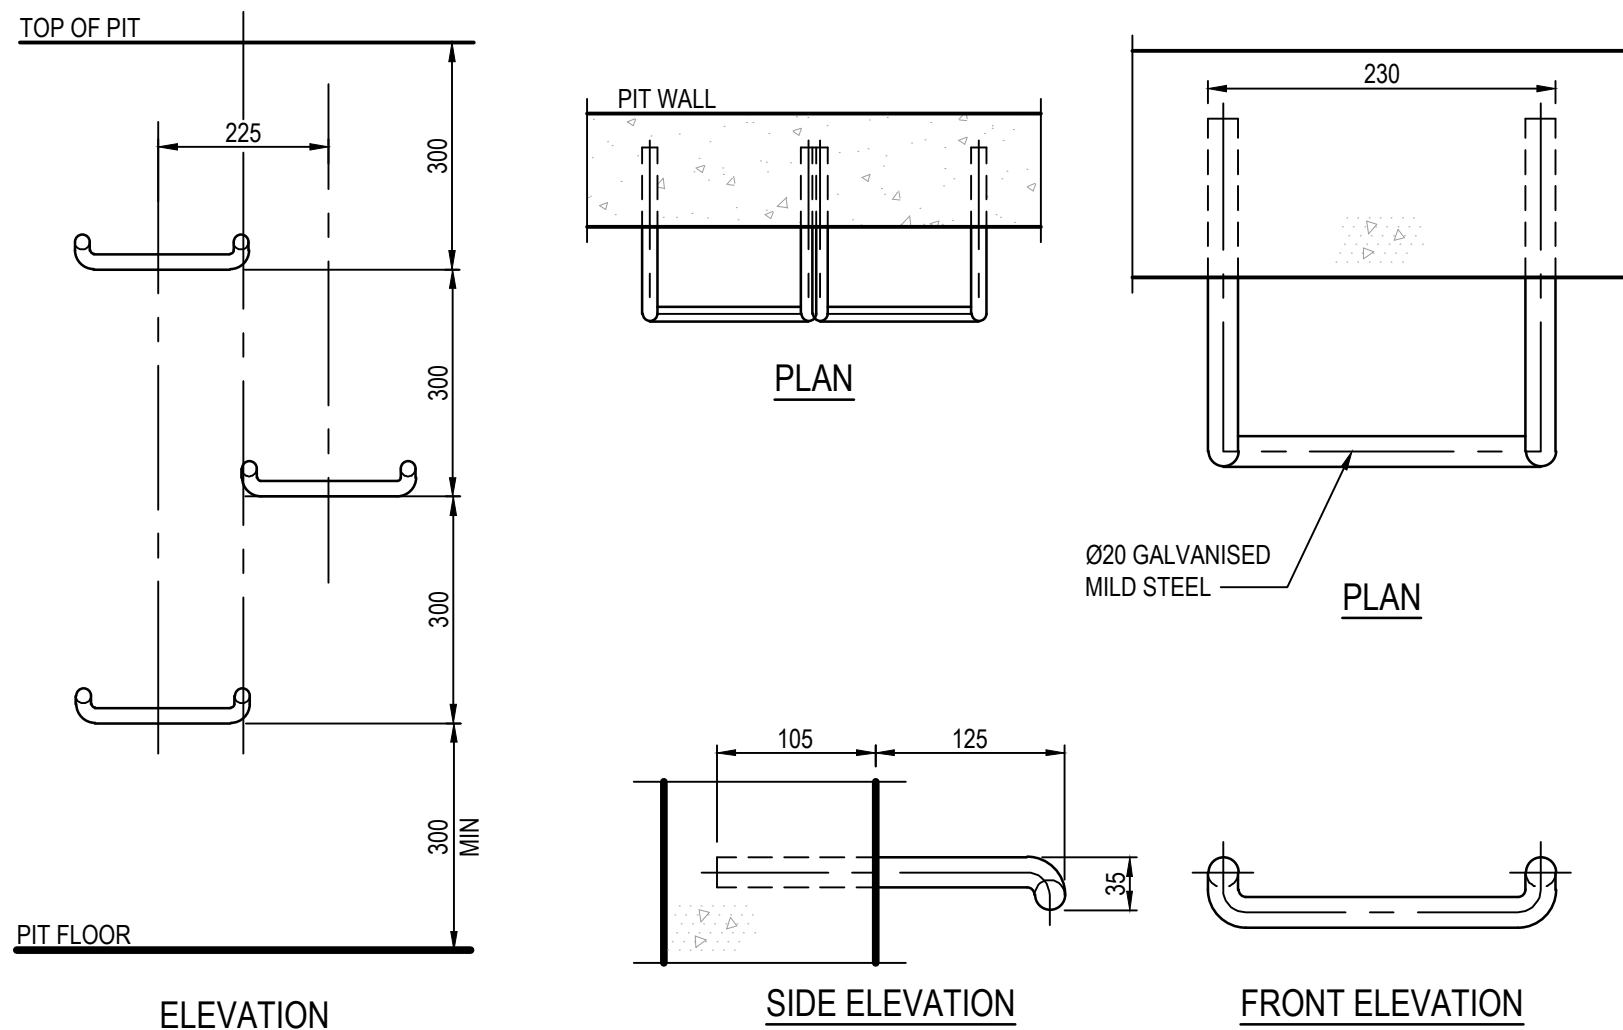


ELEVATION
STEP IRON
PLACEMENT TO PIT WALL
SCALE NTS

STEP IRON DETAIL
SCALE 1:5


NOTE: ALL STEPS IRON TO BE PLASTIC COATED

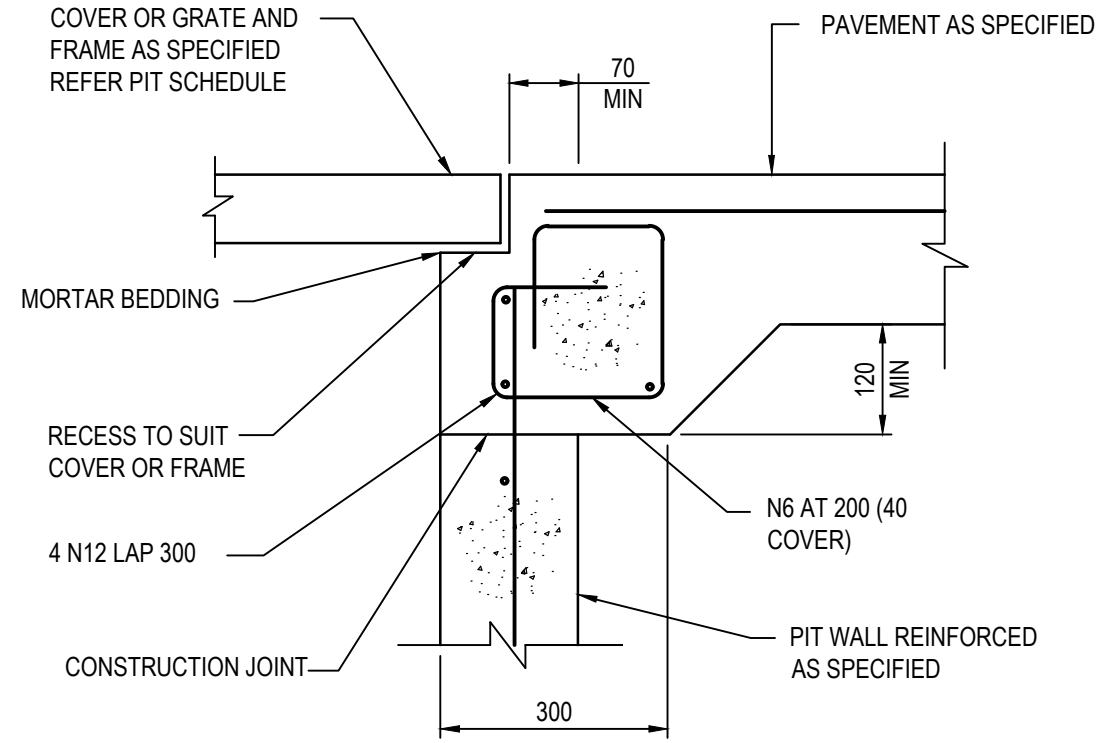


PIT EDGE DETAIL 'B'
SCALE 1:10

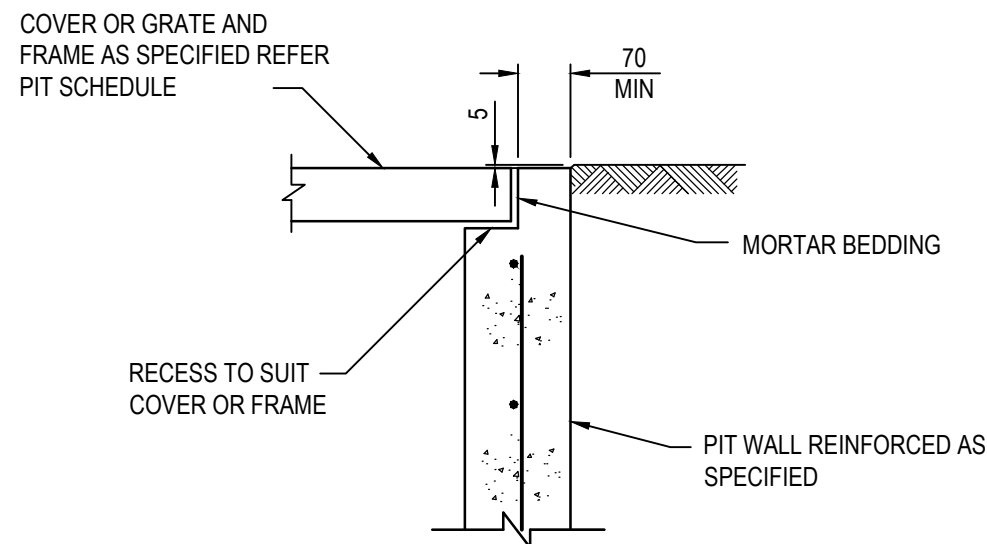


PIT EDGE DETAIL 'D'
SCALE 1:10

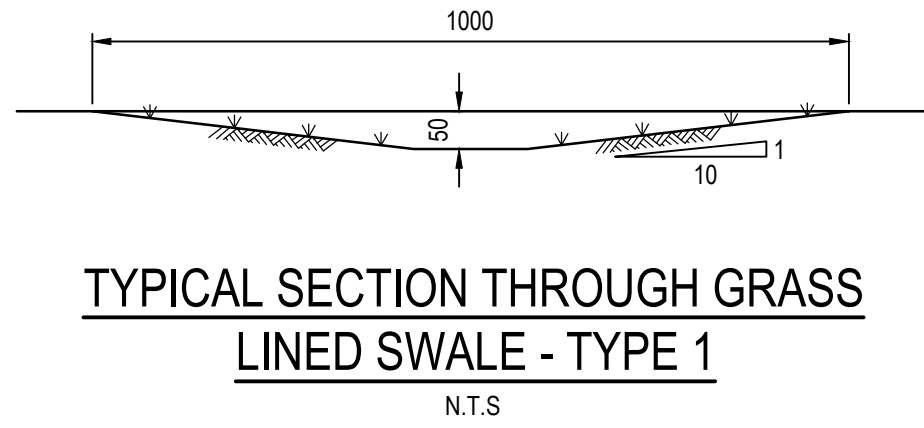

TYPICAL SECTION THROUGH GRASS
LINED SWALE - TYPE 1
N.T.S

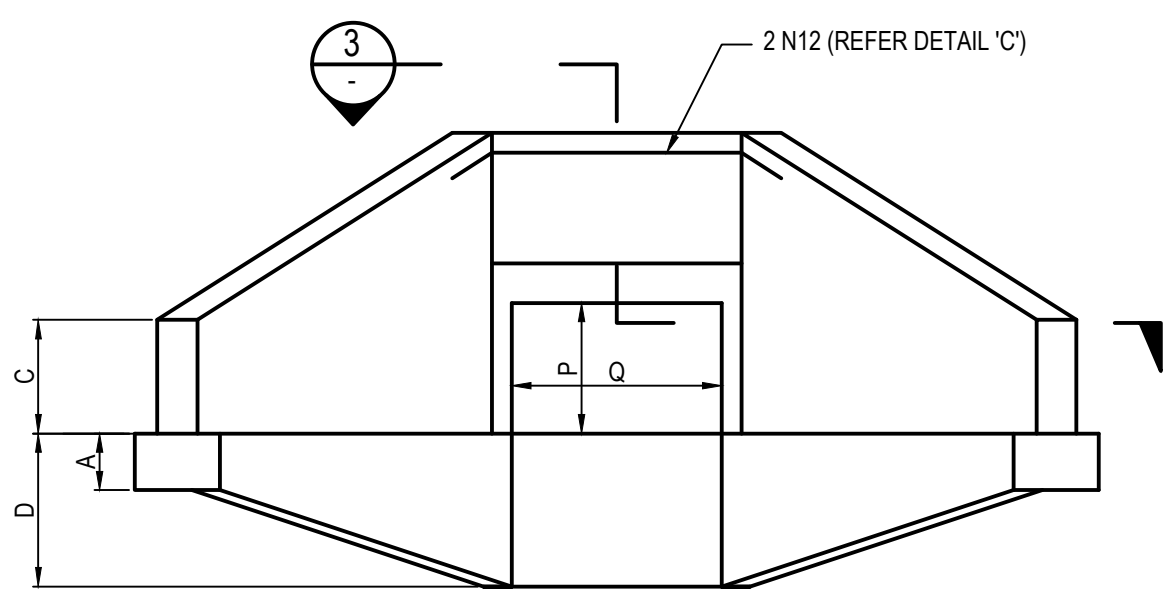


ELEVATION

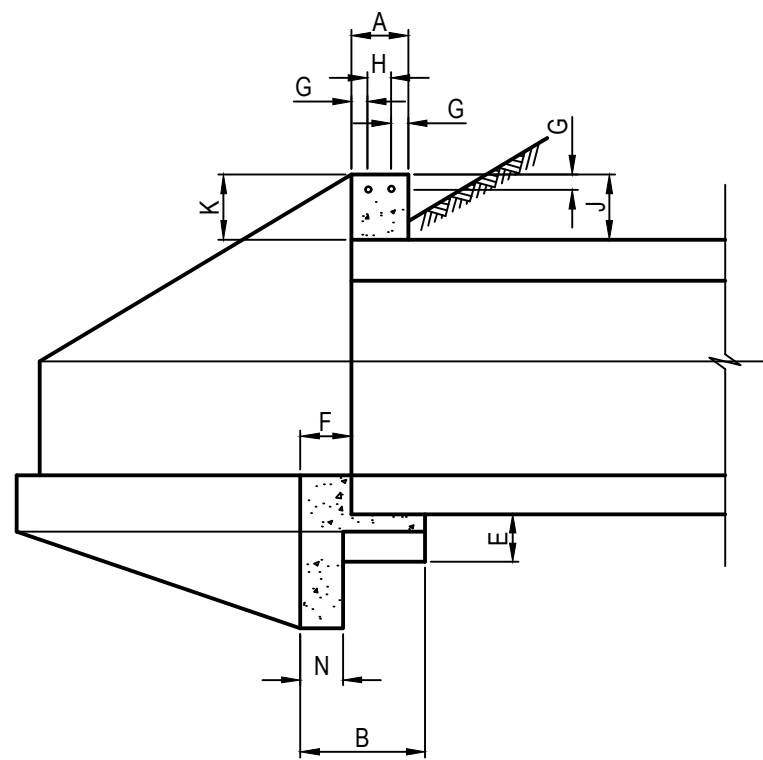

SECTION 4

DESIGNER NOTE CHECK SCOUR PROTECTION REQUIREMENTS PARTICULARLY FOR LARGER DIAMETER PIPES.

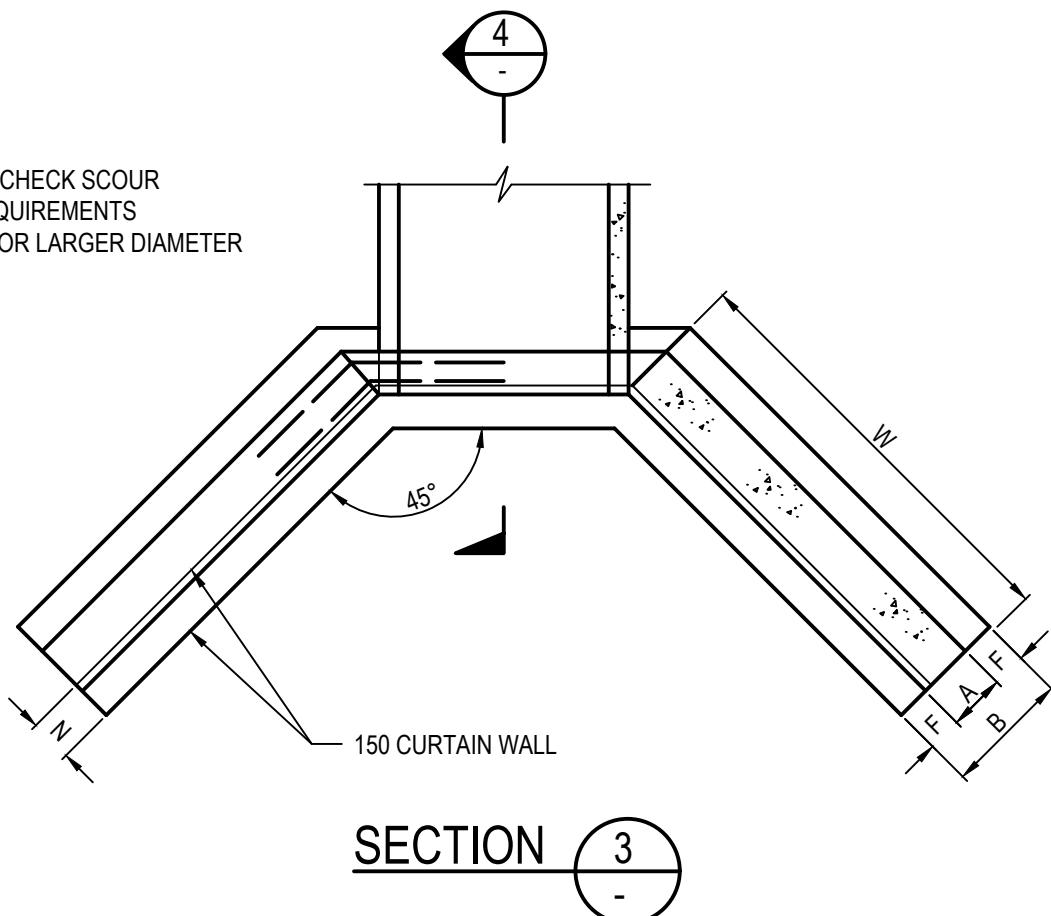

SECTION 3

NOTE 25mm CHAMFER ON ALL EXPOSED SURFACES CONCRETE GRADE 20 MPa.

HEADWALL TYPE 'D'
SCALE 1:20

HEADWALL TYPE 'D'												
CULVERT SIZE (P) x (Q)	A	B	C	D	E	F	G	H	J	K	N	W
300 x 150	150	300	150	375	100	75	40	70	100	200	150	820
300 x 225	150	300	225	375	100	75	40	70	100	200	150	820
375 x 150	150	300	150	375	100	75	40	70	100	200	150	900
375 x 225	150	300	225	375	100	75	40	70	100	200	150	900
450 x 150	150	300	150	375	100	75	40	70	100	200	150	850
450 x 225	150	300	225	375	100	75	40	70	100	200	150	850
450 x 300	150	300	300	375	100	75	40	70	100	200	150	850
600 x 225	175	450	225	530	100	100	50	75	100	300	150	1100
600 x 300	175	450	300	530	100	100	50	75	100	300	150	1100
600 x 450	175	450	450	530	100	100	50	75	100	300	150	1100
750 x 225	200	450	225	530	100	100	50	100	100	300	150	1450
750 x 300	200	450	300	530	100	100	50	100	100	300	150	1450
750 x 450	200	450	350	530	100	100	50	100	100	300	150	1450
750 x 600	200	450	350	530	100	100	50	100	100	300	150	1450
900 x 225	225	450	225	530	100	100	50	125	100	300	150	1750
900 x 300	225	450	300	530	100	100	50	125	100	300	150	1750
900 x 450	225	450	350	530	100	100	50	125	100	300	150	1750
900 x 600	225	450	350	530	100	100	50	125	100	300	150	1750
900 x 750	225	450	350	530	100	100	50	125	100	300	150	1750
1200 x 225	260	700	225	600	150	130	50	160	100	300	200	2300
1200 x 300	260	700	300	600	150	130	50	160	100	300	200	2300
1200 x 450	260	700	450	600	150	130	50	160	100	300	200	2300
1200 x 600	260	700	450	600	150	130	50	160	100	300	200	2300
1200 x 900	260	700	450	600	150	130	50	160	100	300	200	2300

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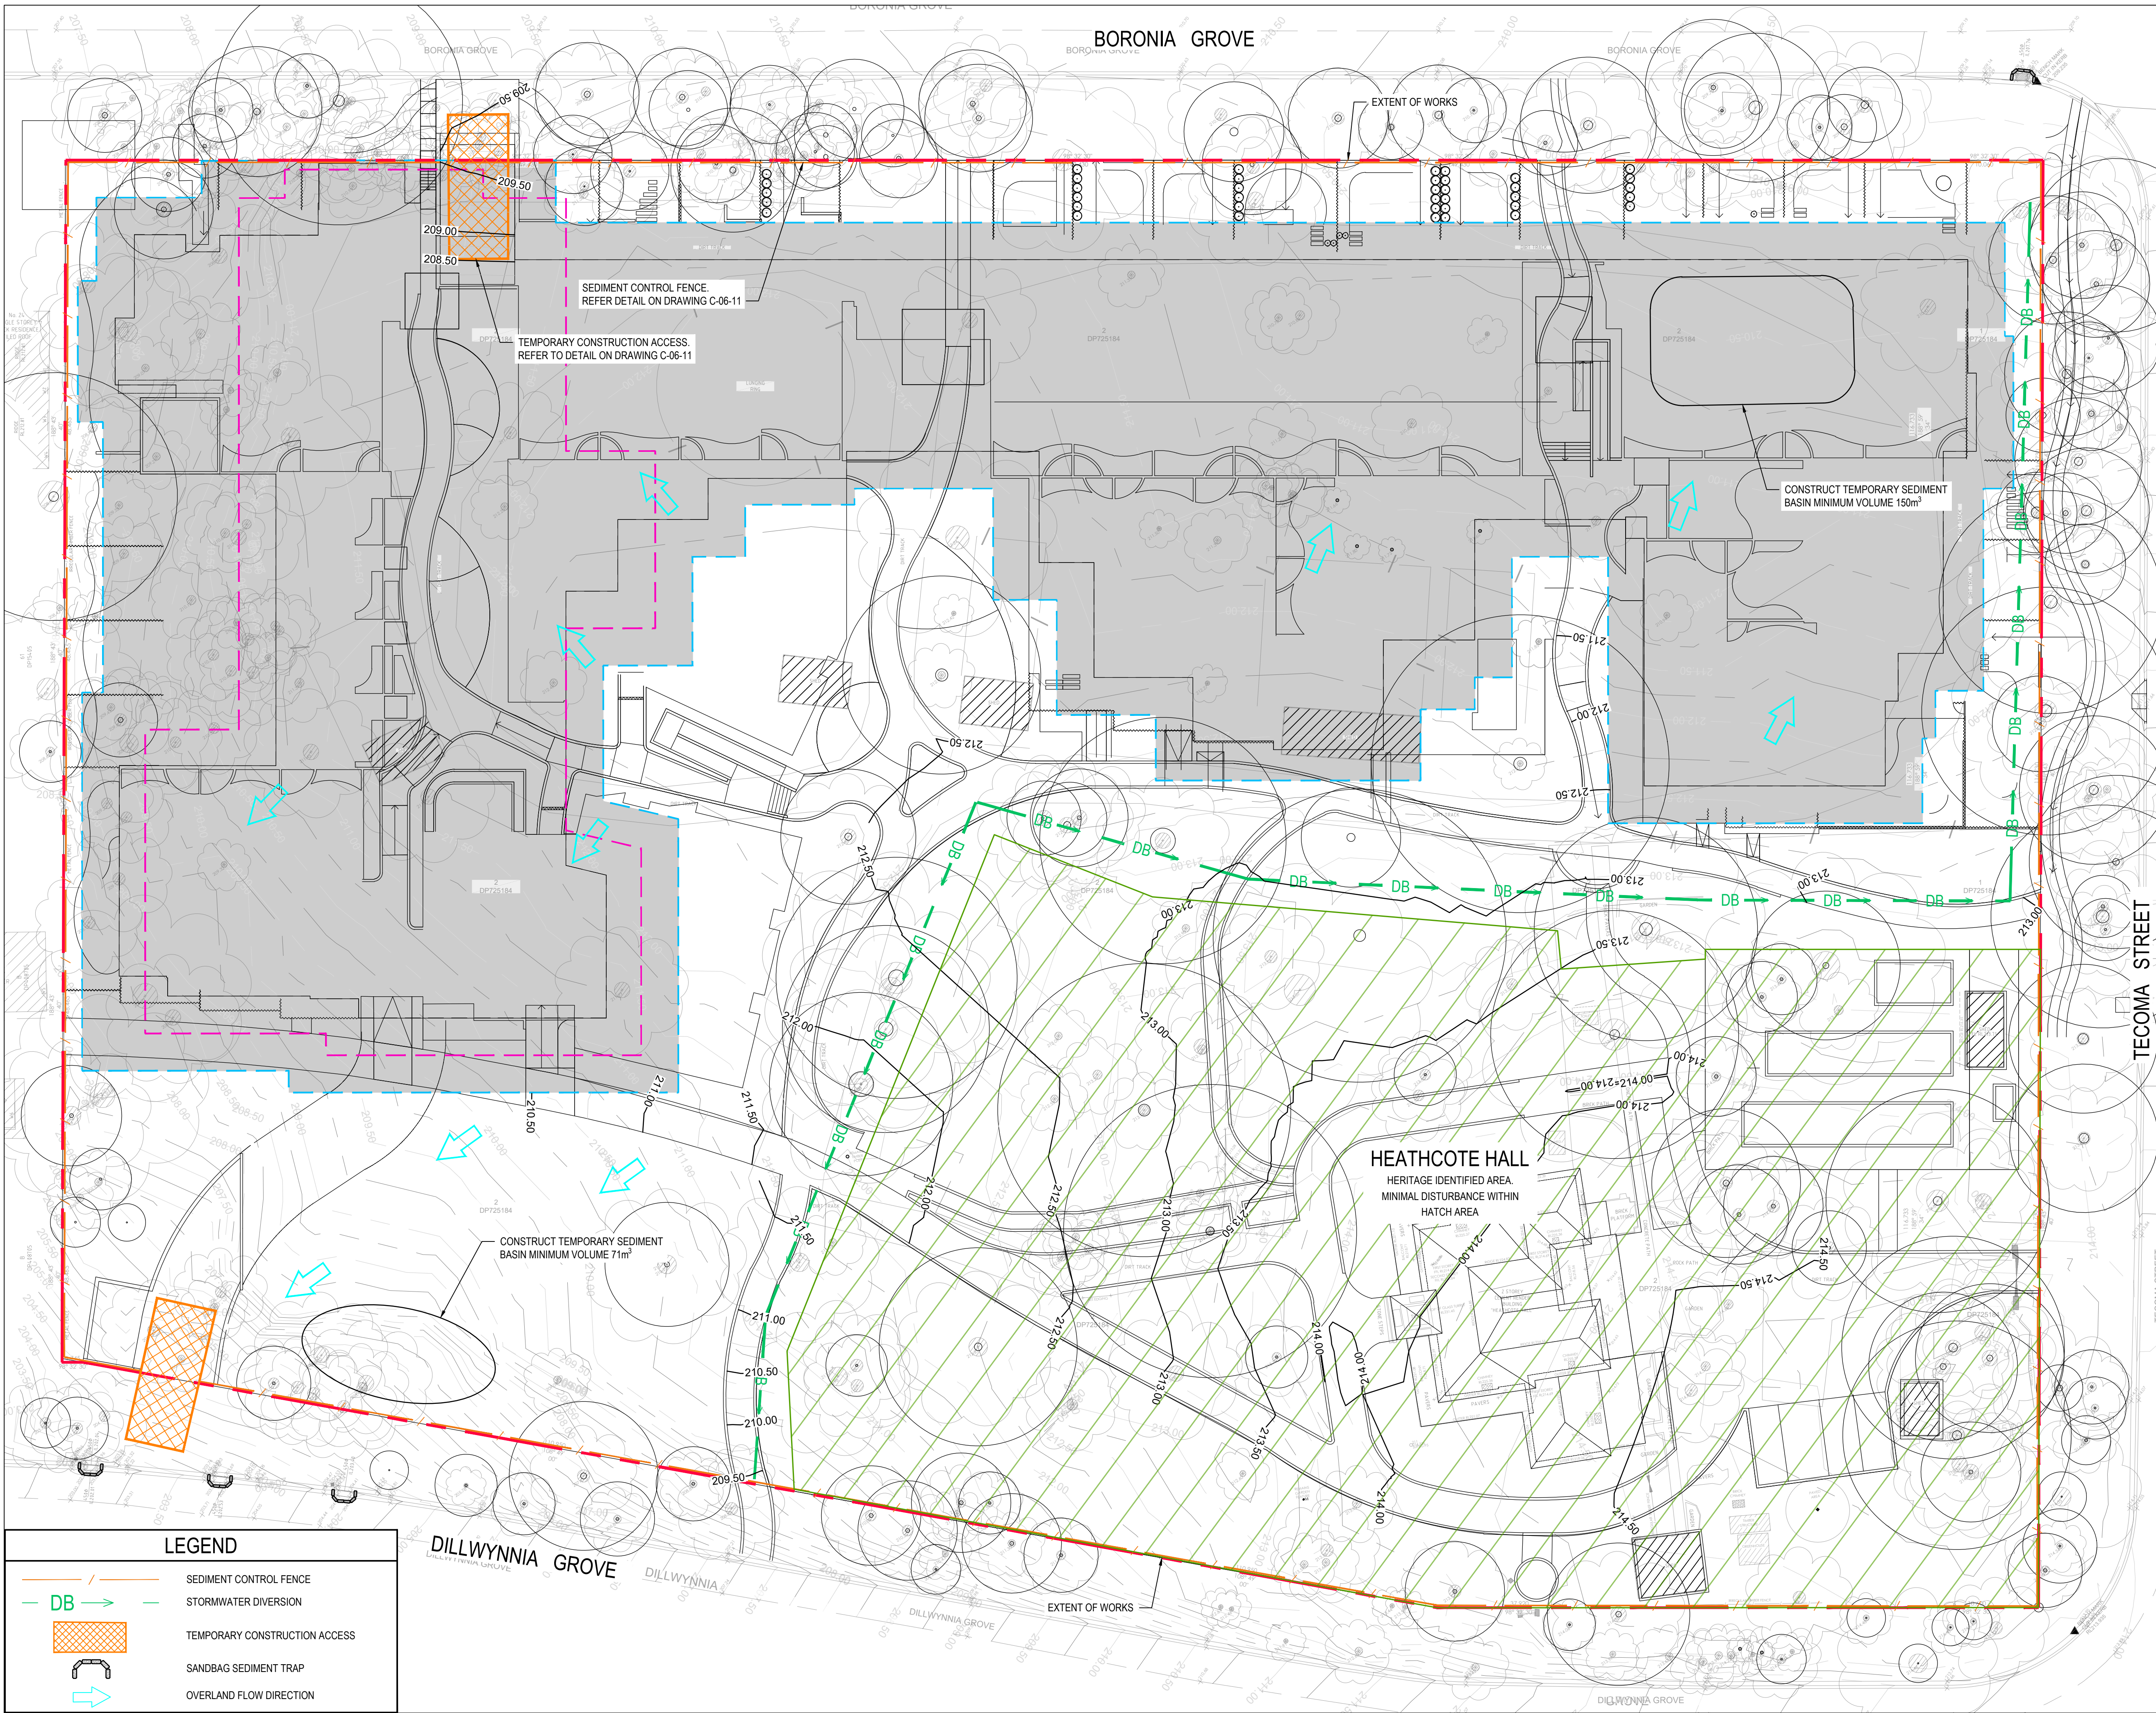
Project
**HEATHCOTE GROUNDS
MAIN WORKS**

Title
STORMWATER DETAILS

Scale
AS SHOWN AT A1

Drawn JE	Checked BK	Approved JC
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Project Number S201117	Drawing Number C-05-61	Revision 03
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Project
HEATHCOTE GROUNDS MAIN WORKS

Title
SEDIMENT AND EROSION CONTROL PLAN

Scale

Drawn	Checked	Approved	Revision
JE	BK	JC	04

Project Number	Drawing Number	Revision
S201117	C-06-01	04

LEGEND

	SEDIMENT CONTROL FENCE
	STORMWATER DIVERSION
	TEMPORARY CONSTRUCTION ACCESS
	SANDBAG SEDIMENT TRAP
	OVERLAND FLOW DIRECTION

EROSION AND SEDIMENT CONTROL NOTES

GENERAL INSTRUCTIONS

- E1. THIS PLAN IS TO BE READ IN CONJUNCTION WITH THE ENGINEERING PLANS, AND ANY OTHER PLANS OR WRITTEN INSTRUCTIONS THAT MAY BE ISSUED AND RELATING TO DEVELOPMENT AT THE SUBJECT SITE.
- E2. THE SITE SUPERINTENDENT WILL ENSURE THAT ALL SOIL AND WATER MANAGEMENT WORKS ARE LOCATED AS INSTRUCTED IN THIS SPECIFICATION.
- E3. ALL BUILDERS AND SUB-CONTRACTORS WILL BE INFORMED OF THEIR RESPONSIBILITIES IN MINIMISING THE POTENTIAL FOR SOIL EROSION AND POLLUTION TO DOWNSLOPE LANDS AND WATERWAYS.

CONSTRUCTION SEQUENCE

- E4. THE SOIL EROSION POTENTIAL ON THIS SITE SHALL BE MINIMISED. HENCE WORKS SHALL BE UNDERTAKEN IN THE FOLLOWING SEQUENCE :
- a. INSTALL SEDIMENT FENCES, TEMPORARY CONSTRUCTION EXIT AND SANDBAG KERB INLET SEDIMENT TRAP.
- b. UNDERTAKE SITE DEVELOPMENT WORKS IN ACCORDANCE WITH THE ENGINEERING PLANS. PHASE DEVELOPMENT SO THAT LAND DISTURBANCE IS CONFINED TO AREAS OF WORKABLE SIZE.

EROSION CONTROL

- E5. DURING WINDY CONDITIONS, LARGE, UNPROTECTED AREAS WILL BE KEPT MOIST (NOT WET) BY SPRINKLING WITH WATER TO KEEP DUST UNDER CONTROL.
- E6. FINAL SITE LANDSCAPING WILL BE UNDERTAKEN AS SOON AS POSSIBLE AND WITHIN 20 WORKING DAYS FROM COMPLETION OF CONSTRUCTION ACTIVITIES.

FENCING


- E7. STOCKPILES WILL NOT BE LOCATED WITHIN 2 METRES OF HAZARD AREAS, INCLUDING LIKELY AREAS OF CONCENTRATED OR HIGH VELOCITY FLOWS SUCH AS WATERWAYS. WHERE THEY ARE BETWEEN 2 AND 5 METRES FROM SUCH AREAS, SPECIAL SEDIMENT CONTROL MEASURES SHOULD BE TAKEN TO MINIMISE POSSIBLE POLLUTION TO DOWNSLOPE WATERS, E.G. THROUGH INSTALLATION OF SEDIMENT FENCING.
- E8. ANY SAND USED IN THE CONCRETE CURING PROCESS (SPREAD OVER THE SURFACE) WILL BE REMOVED AS SOON AS POSSIBLE AND WITHIN 10 WORKING DAYS FROM PLACEMENT.
- E9. WATER WILL BE PREVENTED FROM ENTERING THE PERMANENT DRAINAGE SYSTEM UNLESS IT IS RELATIVELY SEDIMENT FREE, I.E. THE CATCHMENT AREA HAS BEEN PERMANENTLY LANDSCAPED AND/OR ANY LIKELY SEDIMENT HAS BEEN FILTERED THROUGH AN APPROVED STRUCTURE.
- E10. TEMPORARY SOIL AND WATER MANAGEMENT STRUCTURES WILL BE REMOVED ONLY AFTER THE LANDS THEY ARE PROTECTING ARE REHABILITATED.

OTHER MATTERS

- E11. ACCEPTABLE RECEPTORS WILL BE PROVIDED FOR CONCRETE AND MORTAR SLURRIES, PAINTS, ACID WASHINGS, LIGHT-WEIGHT WASTE MATERIALS AND LITTER.
- E12. RECEPTORS FOR CONCRETE AND MORTAR SLURRIES, PAINTS, ACID WASHINGS, LIGHT-WEIGHT WASTE MATERIALS AND LITTER ARE TO BE EMPTIED AS NECESSARY. DISPOSAL OF WASTE SHALL BE IN A MANNER APPROVED BY THE SITE SUPERINTENDENT.

SITE INSPECTION & MAINTENANCE

- E13. EROSION AND SEDIMENT CONTROL MEASURES SHALL BE INSPECTED AFTER RAINFALL EVENTS TO ENSURE THAT THEY OPERATE EFFECTIVELY. REPAIR AND OR MAINTENANCE SHALL BE UNDERTAKEN AS REQUIRED.

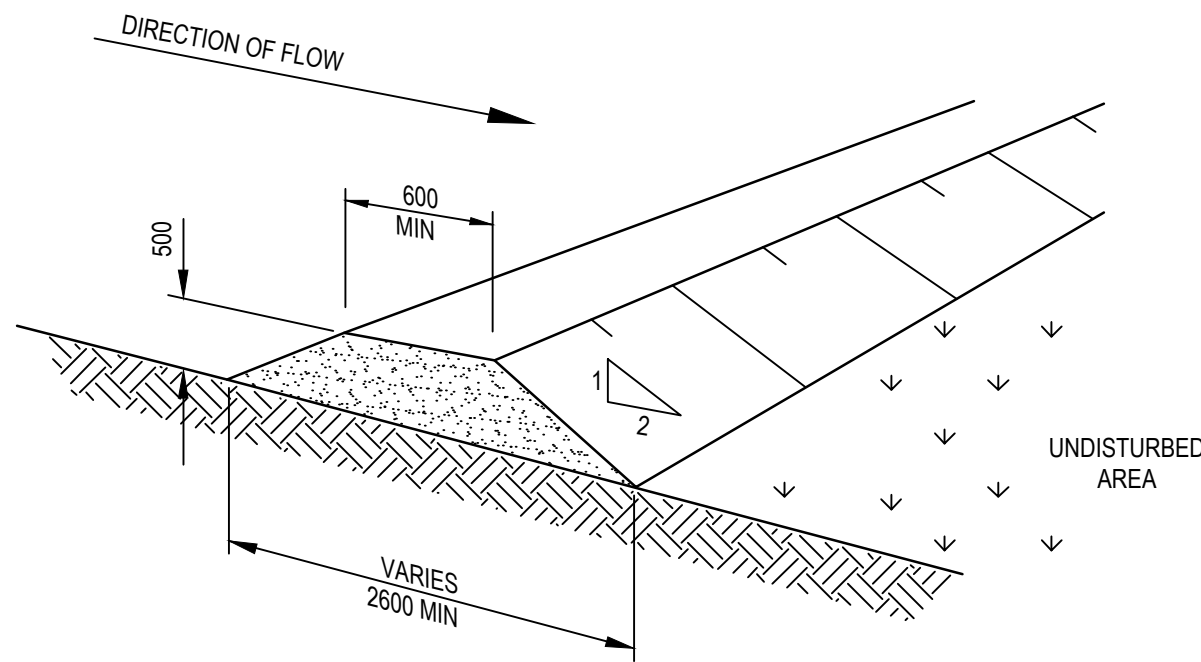


DIVERSION MOUND

NTS

NOTE:
ENSURE THAT ALL COUNCIL AND PUBLIC UTILITY ASSETS ARE MAINTAINED AND PROTECTED AT ALL TIMES IN THE VICINITY OF THE TEMPORARY CONSTRUCTION EXIT

GEOTEXTILE FABRIC DESIGNED TO PREVENT INTERMIXING OF SUBGRADE AND BASE MATERIALS AND TO MAINTAIN GOOD PROPERTIES OF THE SUB-BASE LAYERS. GEOTEXTILE MAY BE WOVEN OR NEEDLE PUNCHED PRODUCT WITH A MINIMUM CBR BURST STRENGTH (AS3706.4-90) OF 2500N.

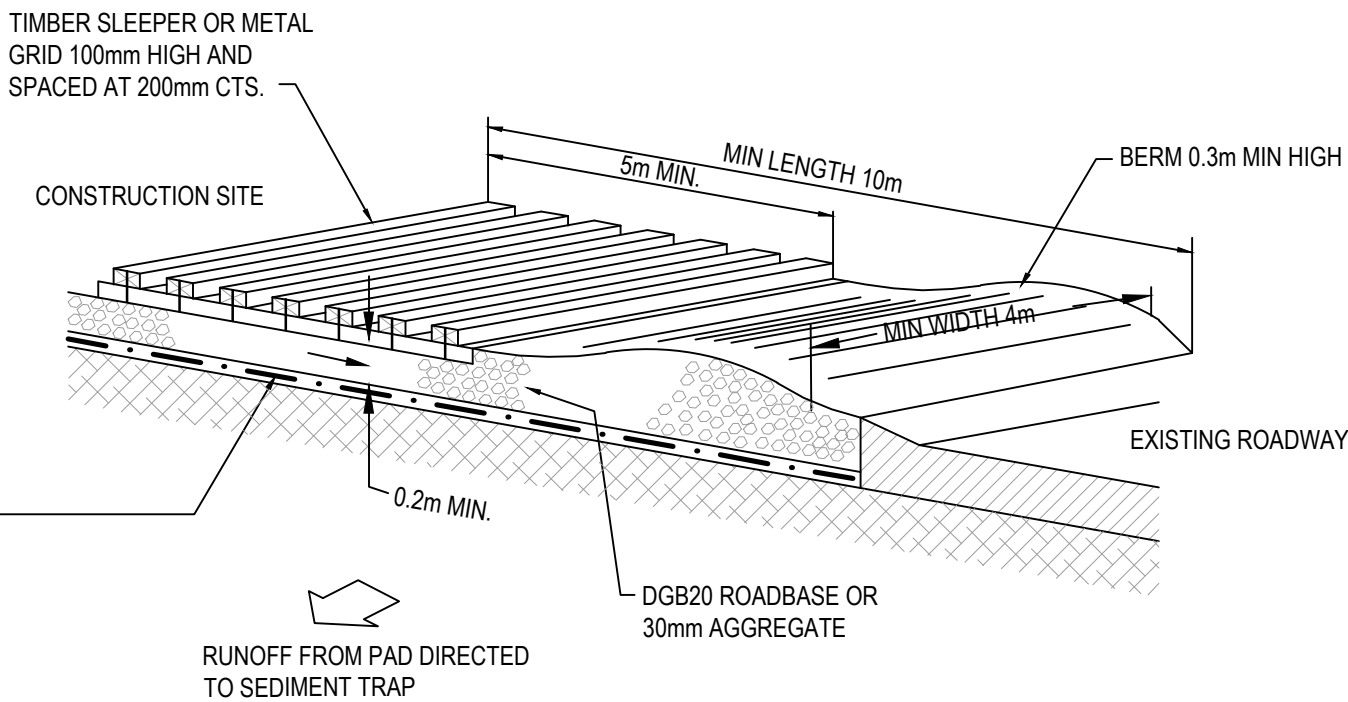


CONSTRUCTION NOTES

1. STRIP TOPSOIL AND LEVEL SITE.
2. COMPACT SUBGRADE.
3. COVER AREA WITH NEEDLE-PUNCHED GEOTEXTILE.
4. CONSTRUCT 200MM THICK PAD OVER GEOTEXTILE USING ROADBASE OR 30MM AGGREGATE.
5. CONSTRUCT HUMP IMMEDIATELY WITHIN BOUNDARY TO DIVERT WATER TO A SEDIMENT FENCE OR OTHER SEDIMENT TRAP WHERE THE SEDIMENT IS COLLECTED AND REMOVED.

MAINTENANCE NOTES


THE EXIT SHALL BE MAINTAINED IN A CONDITION WHICH PREVENTS TRACKING OR FLOWING OF SEDIMENT OFF THE CONSTRUCTION SITE. THIS MAY REQUIRE PERIODIC TOP DRESSING WITH ADDITIONAL GRAVEL AS CONDITIONS DEMAND AND REPAIR AND/OR CLEANOUT OF ANY MEASURES USED TO TRAP SEDIMENT. ALL SEDIMENT SPILLED, DROPPED, WASHED OR TRACKED OFF THE CONSTRUCTION SITE MUST BE REMOVED IMMEDIATELY.

TEMPORARY STABILISED CONSTRUCTION EXIT

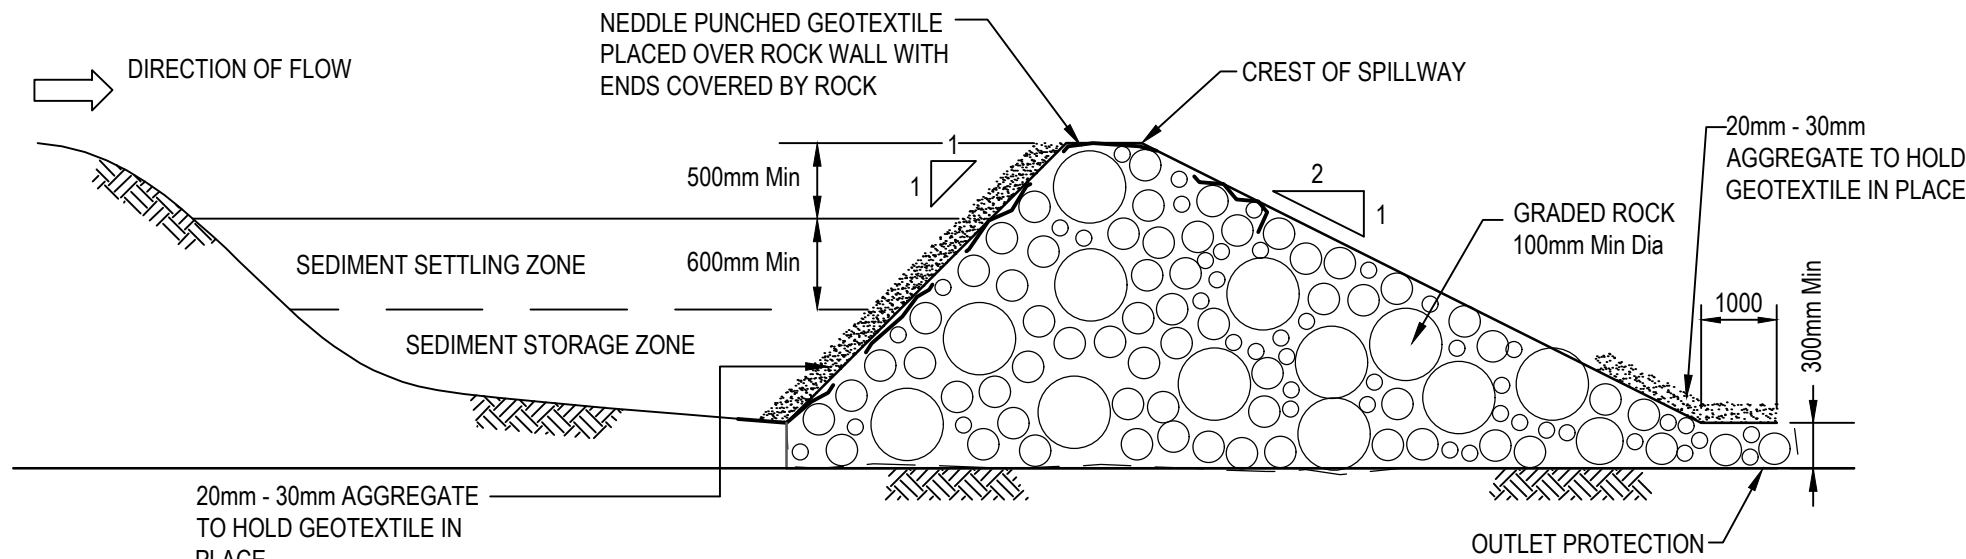



SEDIMENT BASIN DETAIL

NTS

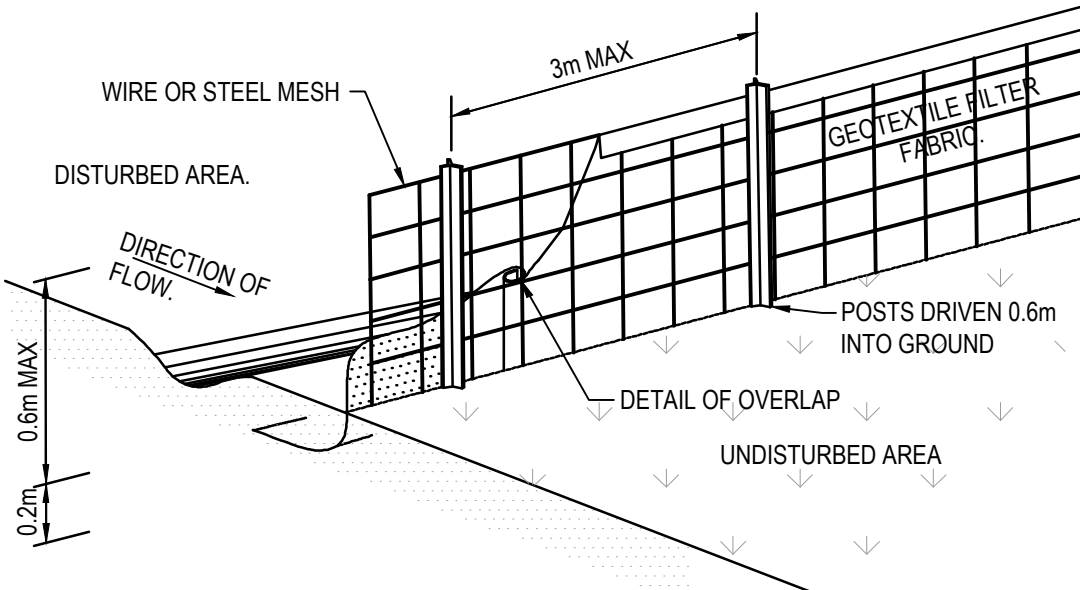

SEDIMENT CONTROL FENCE

NTS

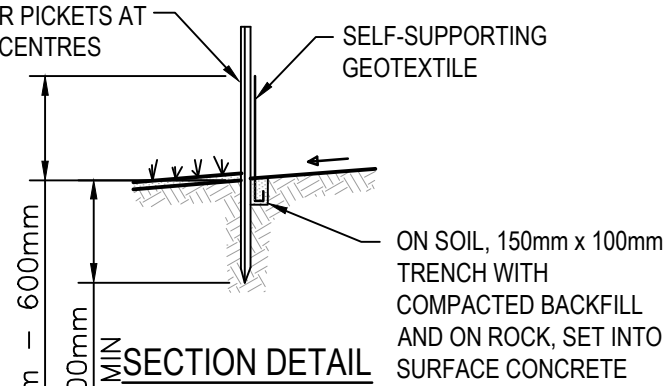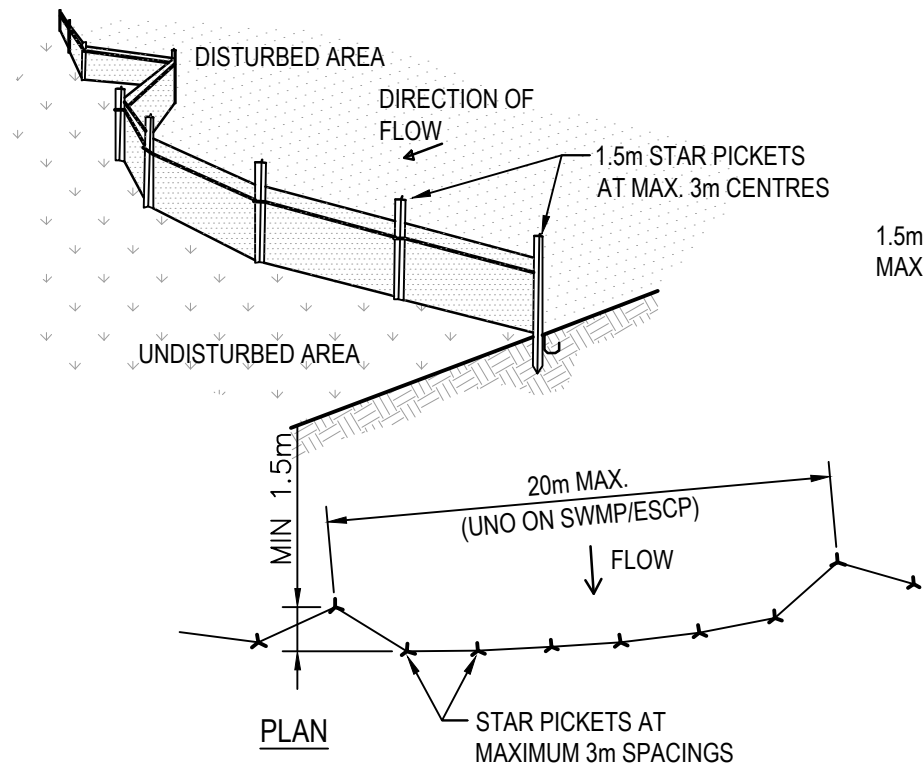


CONSTRUCTION NOTES


1. CONSTRUCT SEDIMENT FENCE AS CLOSE AS POSSIBLE TO PARALLEL TO THE CONTOURS OF THE SITE.
2. DRIVE 1.5m LONG STAR PICKETS INTO GROUND, 3 METRES APART.
3. DIG A 150mm DEEP TRENCH ALONG THE UPSLOPE LINE OF THE FENCE FOR THE BOTTOM OF THE FABRIC TO BE ENTRENCHED.
4. BACKFILL TRENCH OVER BASE OF FABRIC.
5. FIX SELF-SUPPORTING GEOTEXTILE TO UPSLOPE SIDE OF POSTS WITH WIRE TIES OR AS RECOMMENDED BY GEOTEXTILE MANUFACTURER.
6. JOIN SECTIONS OF FABRIC AT A SUPPORT POST WITH A 150mm OVERLAP.

SEDIMENT CONTROL FENCE

NTS

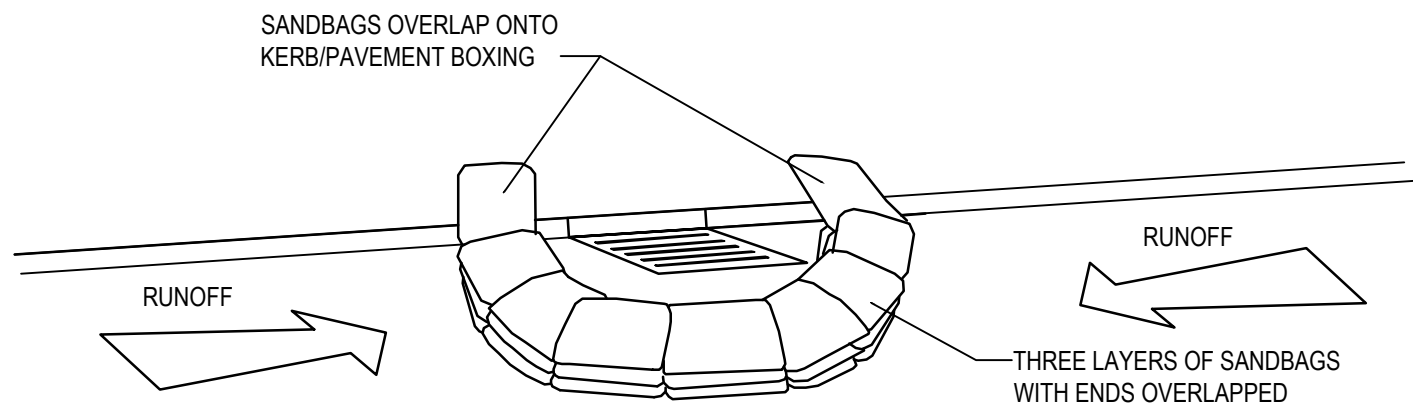

SANDBAG SEDIMENT TRAP - AT KERB SAG PIT

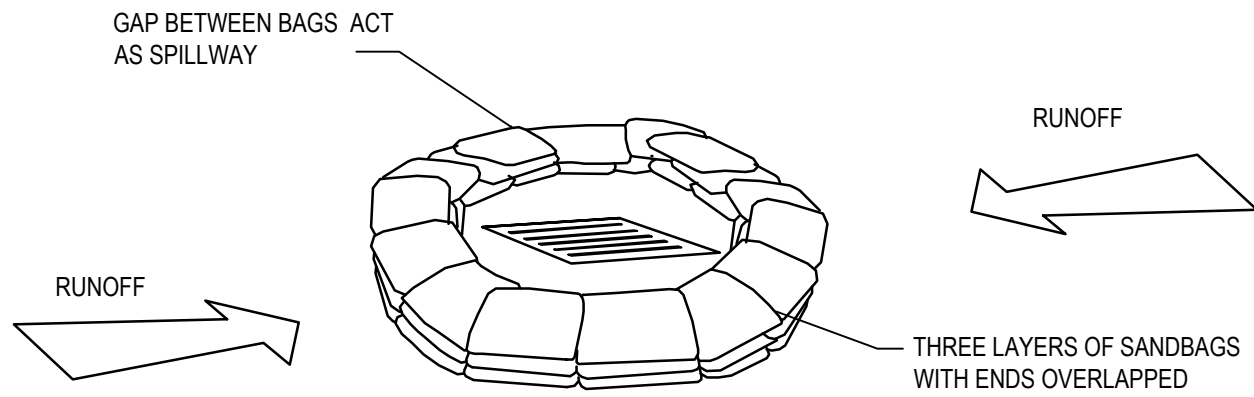

SANDBAG SEDIMENT TRAP - AT OTHER THAN KERB SAG PIT

SANDBAG SEDIMENT TRAP DETAILS

NTS

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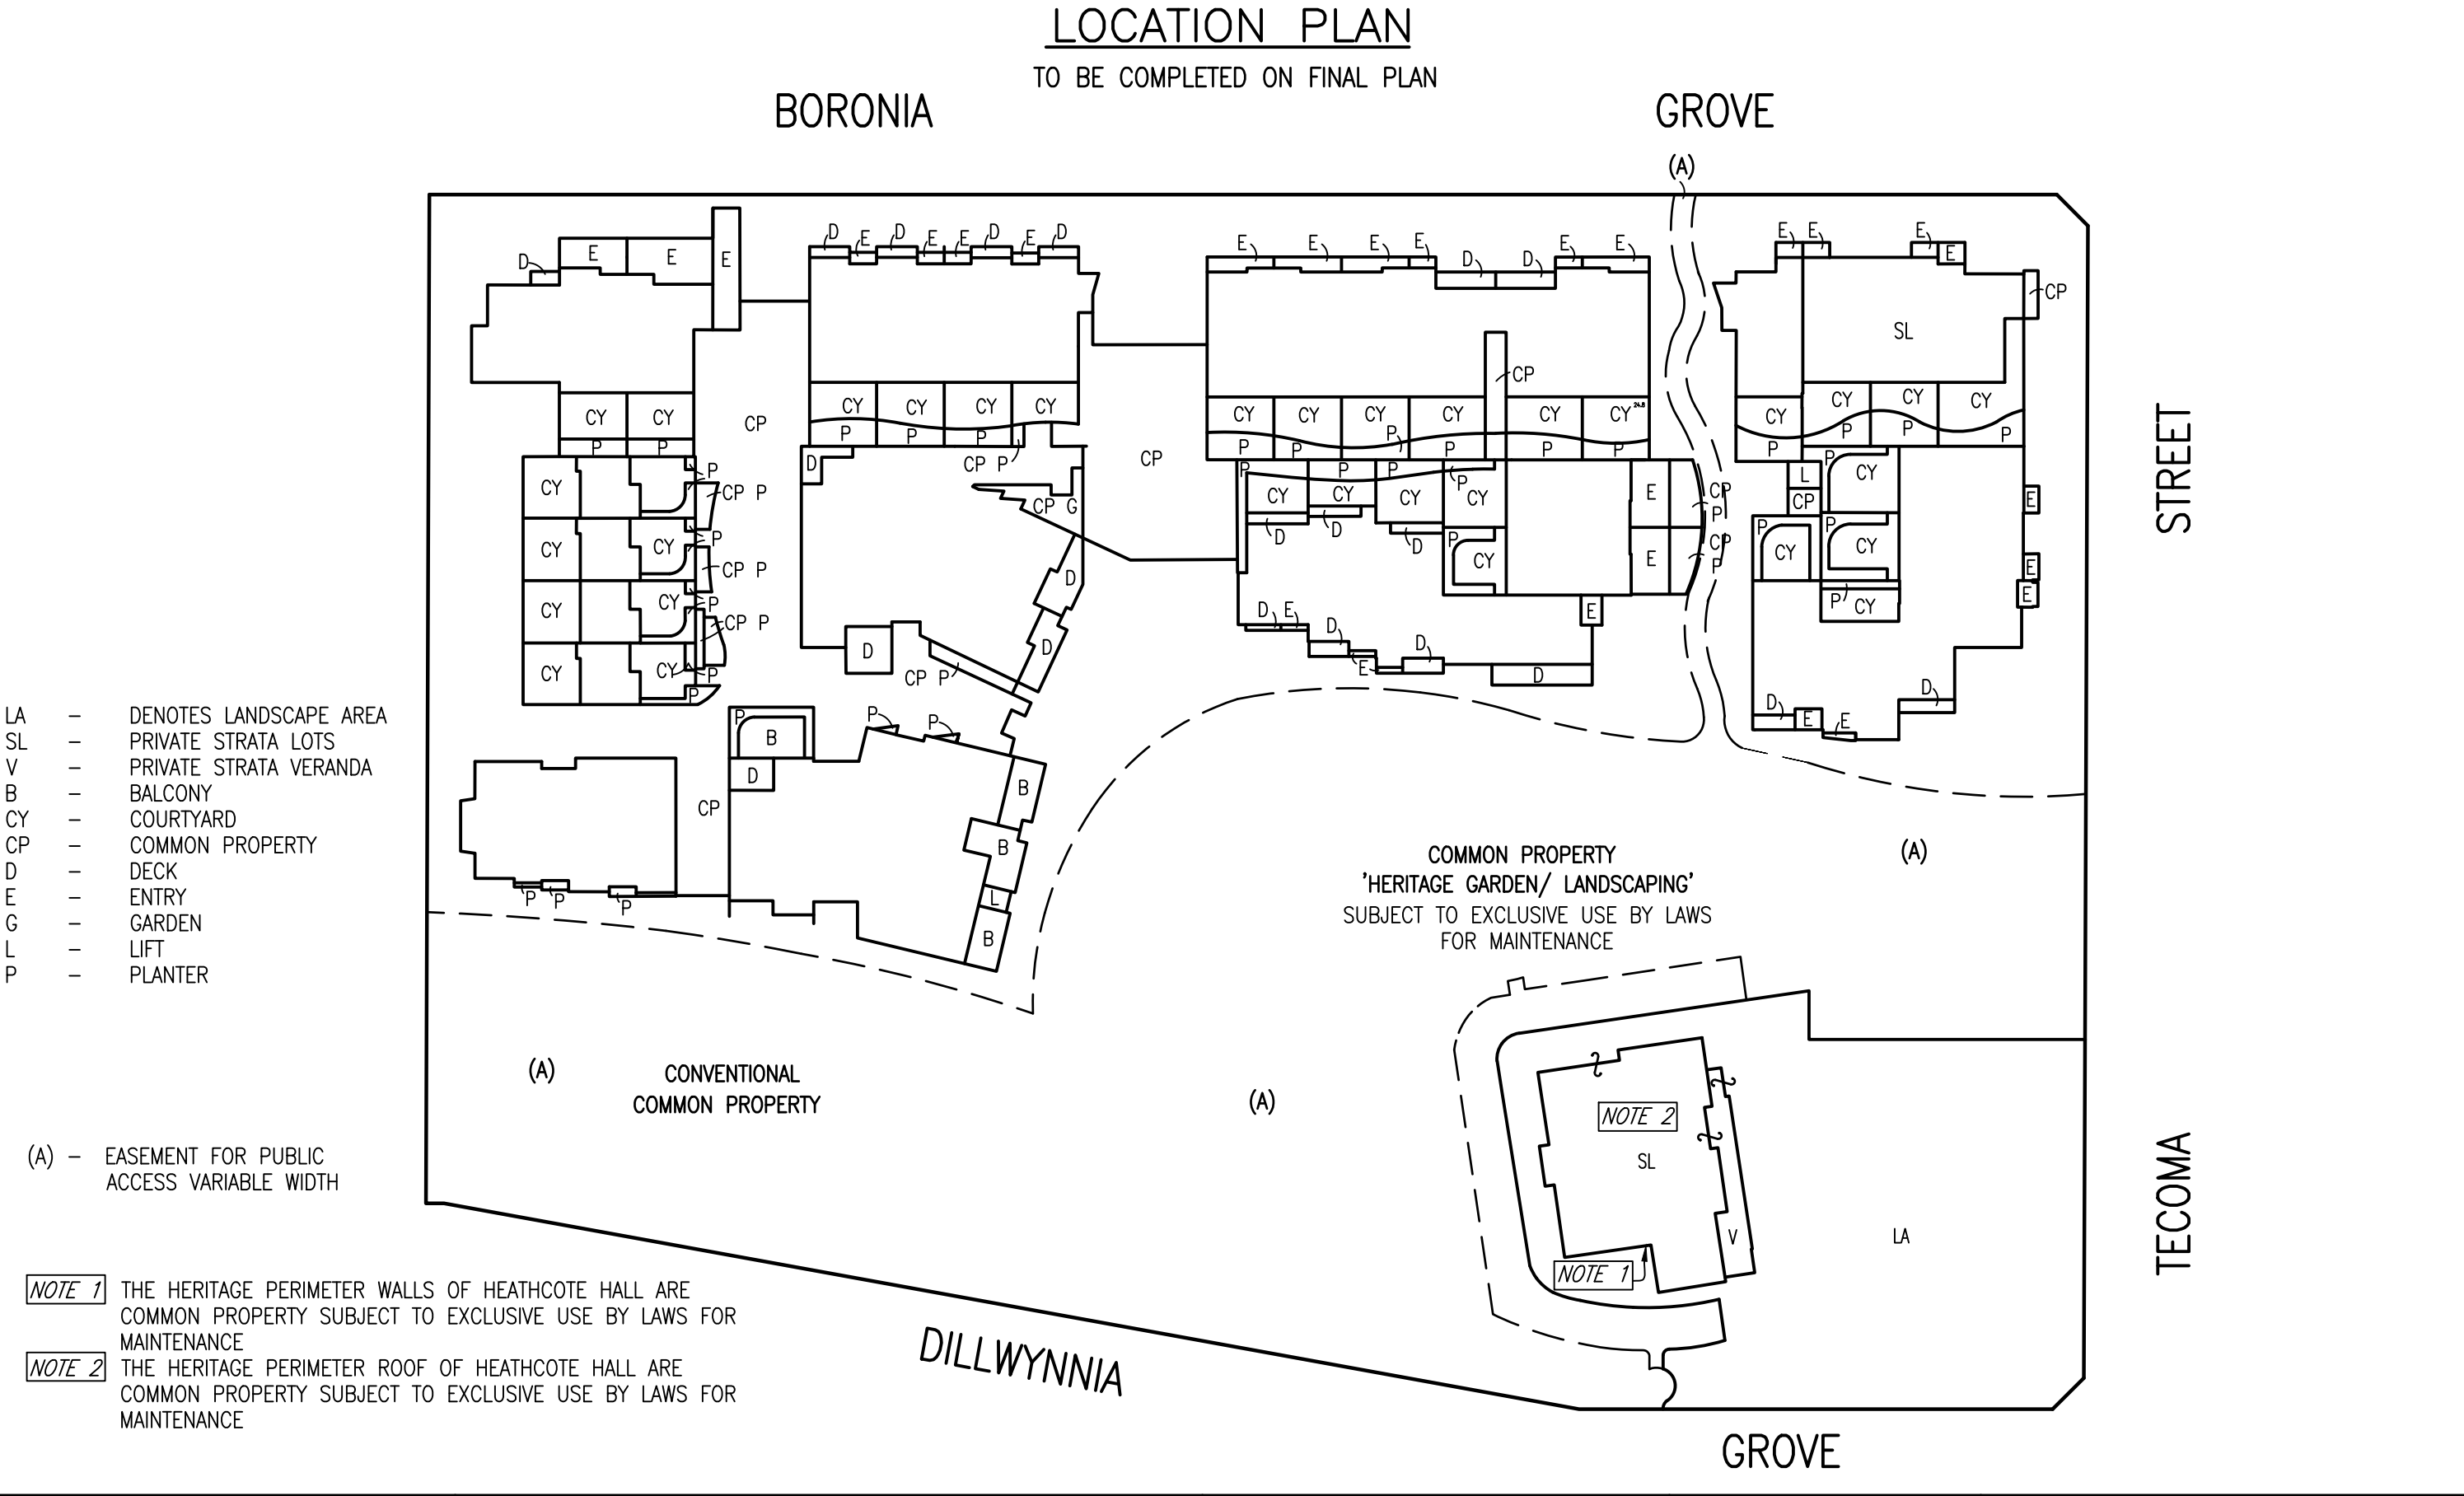
Client
PARITER PTY LTD

Project
**HEATHCOTE GROUNDS
MAIN WORKS**

Title
**SEDIMENT AND EROSION
CONTROL DETAILS**

Scale
AS SHOWN AT A1



Drawn JE	Checked BK	Approved JC	Project Number S201117	Drawing Number C-06-11	Revision 04
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Name: ADAM RICHARDSON	PLAN OF SUBDIVISION OF 1-21 DILLWYNNIA GROVE	LGA: SUTHERLAND SHIRE Locality: HEATHCOTE Reduction Ratio: 1:600 Lengths are in metres.	REGISTERED CONTRACT PLAN Plan compiled from architectural CAD data. Plan is subject to final survey after completion of construction.	DRAFT PRINTED 23 NOV 2020 ISSUE 10
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THIS PLAN IS BASED ON PLANS BY
ARCHITECT
DWG No.: 1-201026_HG_OVERALL MARKETING_B2_DWG FOR STRATA
RECEIVED: 26 OCT 2020

BASEMENT LEVEL 2



AREAS SHOWN ON THE FLOOR PLAN HAVE BEEN CALCULATED FOR THE PURPOSE OF THE STRATA SCHEMES DEVELOPMENT ACT 2015 ONLY. THEY MAY DIFFER FROM FLOOR AREAS FOR OTHER PURPOSES.

THOSE PARTS OF SERVICE LINES WHICH SERVICE ONE LOT ONLY AND ARE LOCATED OUTSIDE OF THAT LOT ARE COMMON PROPERTY. FOR CLARITY NOT ALL COMMON PROPERTY STRUCTURES ARE SHOWN.

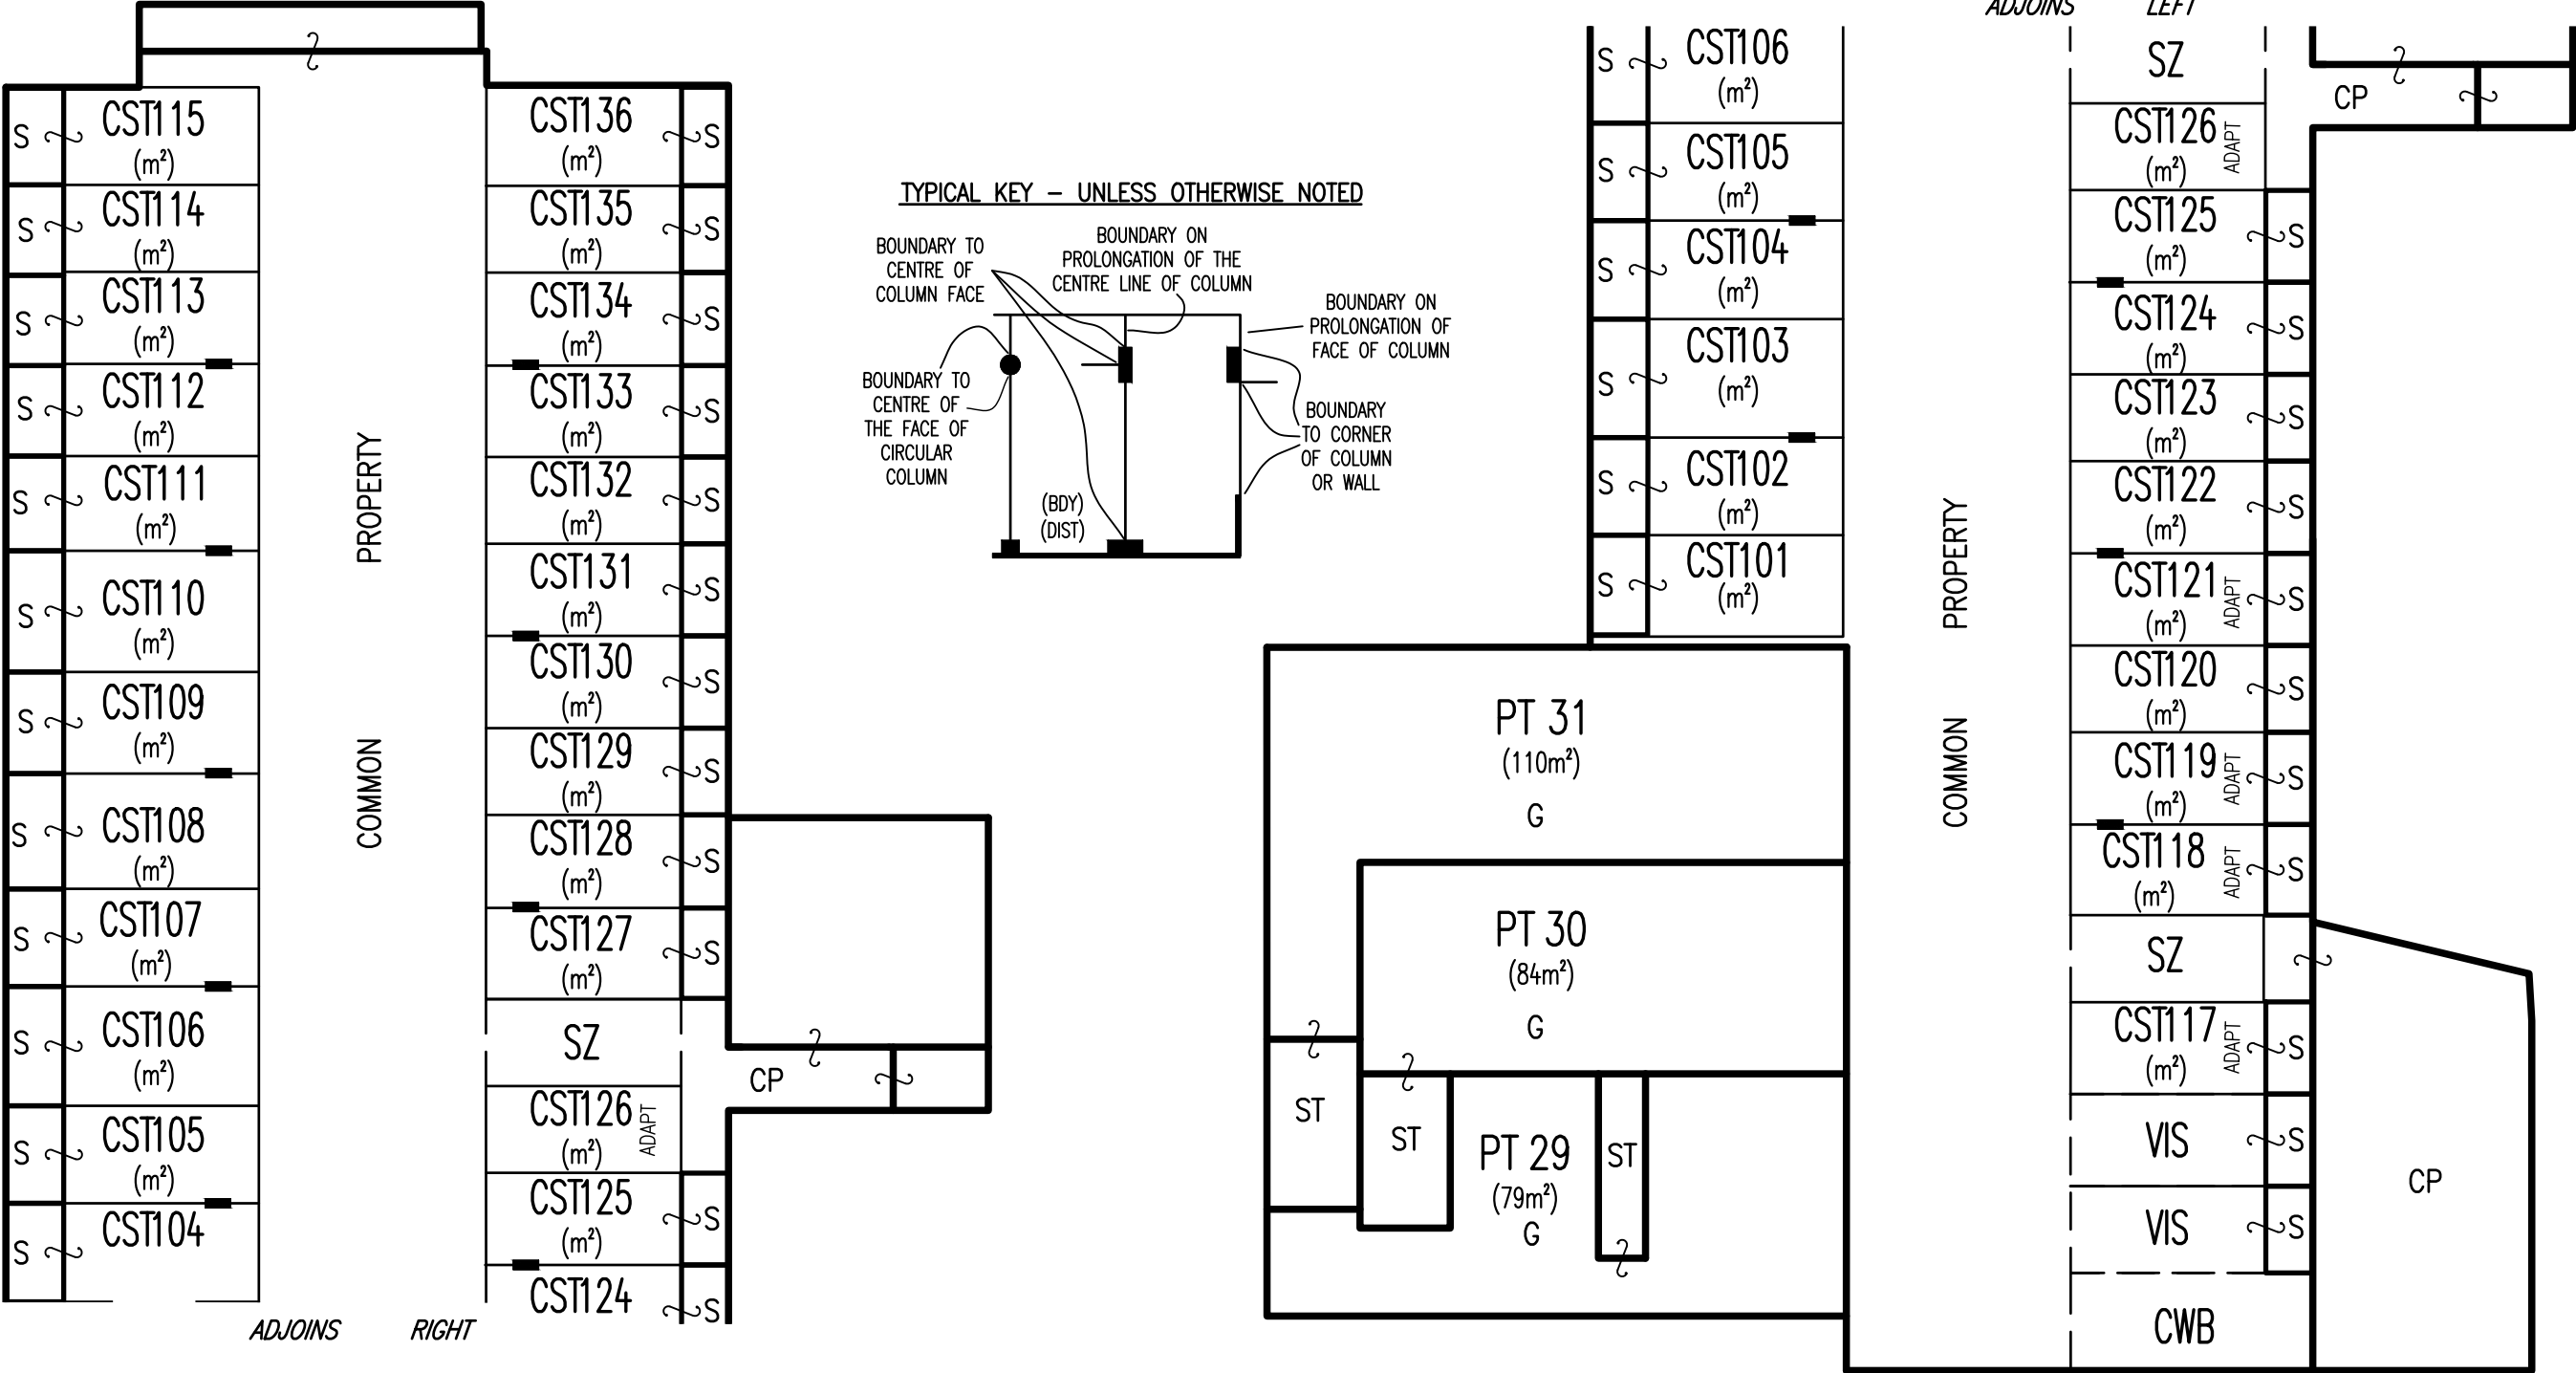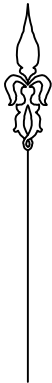- ADAPT – DENOTES ADAPTABLE UNIT CAR SPACE

CP – DENOTES COMMON PROPERTY

G – DENOTES GARAGE

CST – DENOTES CAR SPACE TO BE ALLOCATED
- S – DENOTES STORAGE SPACE

ST – DENOTES STAIRS


SZ – DENOTES SHARED ZONE

VIS – DENOTES VISITOR CAR SPACE WITHIN COMMOM PROPERTY

<div>Name: ADAM RICHARDSON</div> <div>Date: XX/XXX/XX</div> <div>Reference: 170224 DSP</div>	<div>PLAN OF SUBDIVISION OF 1-21</div> <div>DILLWYNNIA GROVE</div>	<div>LGA: SUTHERLAND SHIRE</div> <div>Locality: HEATHCOTE</div> <div>Reduction Ratio: 1:200</div> <div>Lengths are in metres.</div>	<div>REGISTERED</div> <div>CONTRACT PLAN</div> <div>Plan compiled from architectural CAD data.</div> <div>Plan is subject to final survey after completion of construction.</div>	<div>DRAFT</div> <div>PRINTED 23 NOV 2020</div> <div>ISSUE 10</div>
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THIS PLAN IS BASED ON PLANS BY
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DWG No.: 2-201026_HG_OVERALL MARKETING_B1_DWG FOR STRATA
RECEIVED: 26 OCT 2020

BASEMENT LEVEL 1

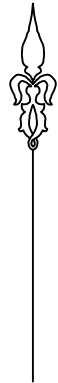

- ADAPT- DENOTES ADAPTABLE UNIT CAR SPACE

CP - DENOTES COMMON PROPERTY

CY - DENOTES COURTYARD

CS - DENOTES CAR SPACE

CST - DENOTES CAR SPACE TO BE ALLOCATED

D - DENOTES DECK

E - DENOTES ENTRY

G - DENOTES GARAGE
- L - DENOTES LIFT

LA - DENOTES LANDSCAPE AREA

P - DENOTES PLANTER




S - STORAGE AREA

ST - DENOTES STAIRS

STR - DENOTES STORAGE TO BE ALLOCATED

SZ - DENOTES SHARED ZONE

VIS - DENOTES VISITOR CAR SPACE WITHIN COMMON PROPERTY

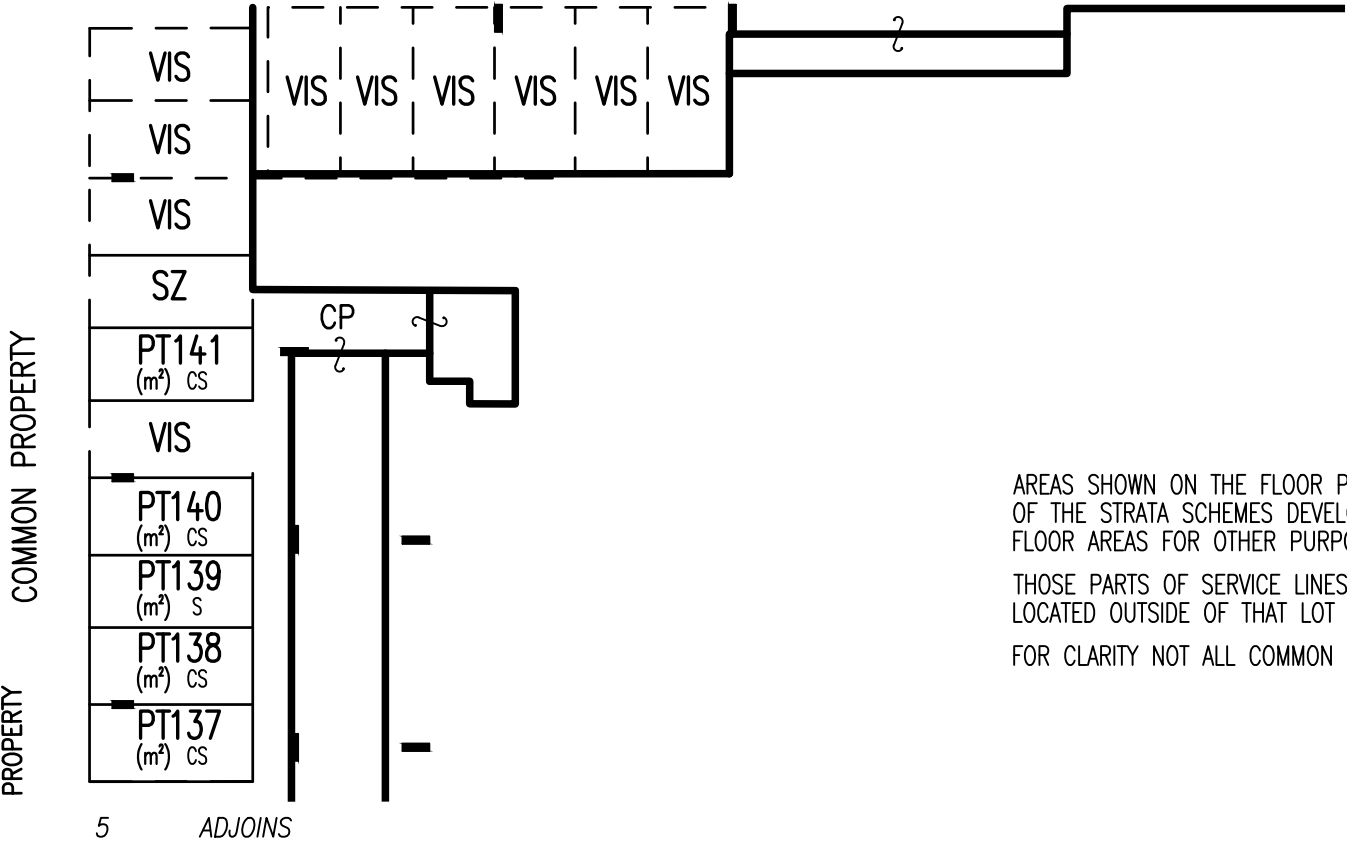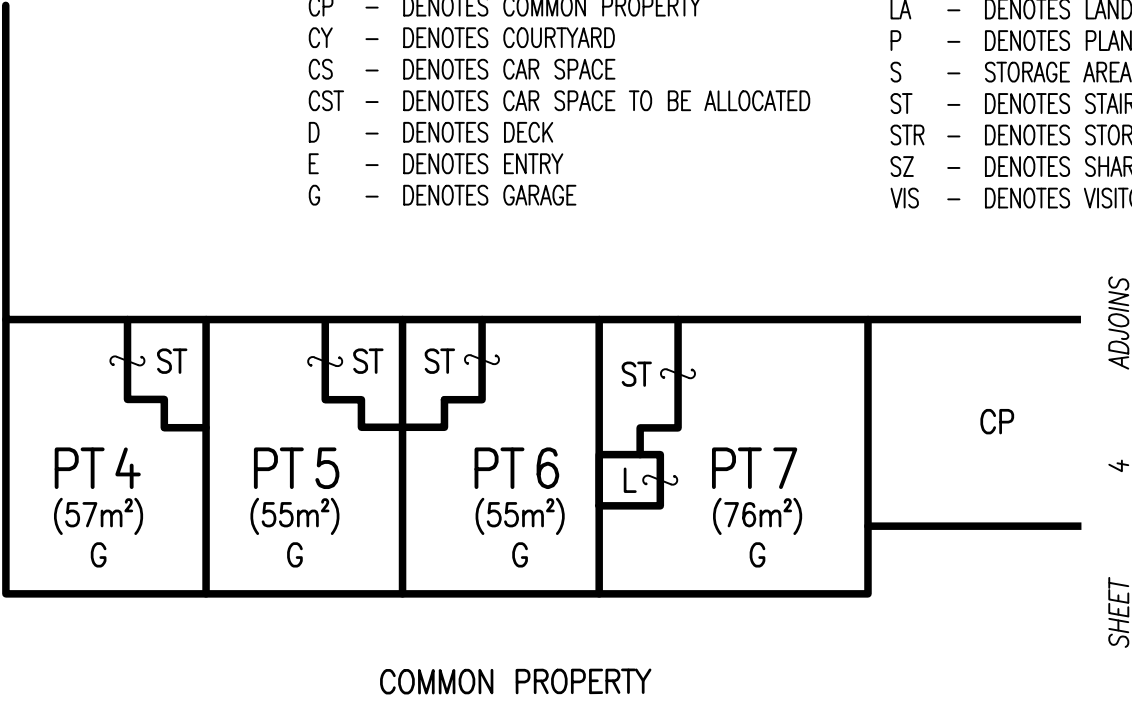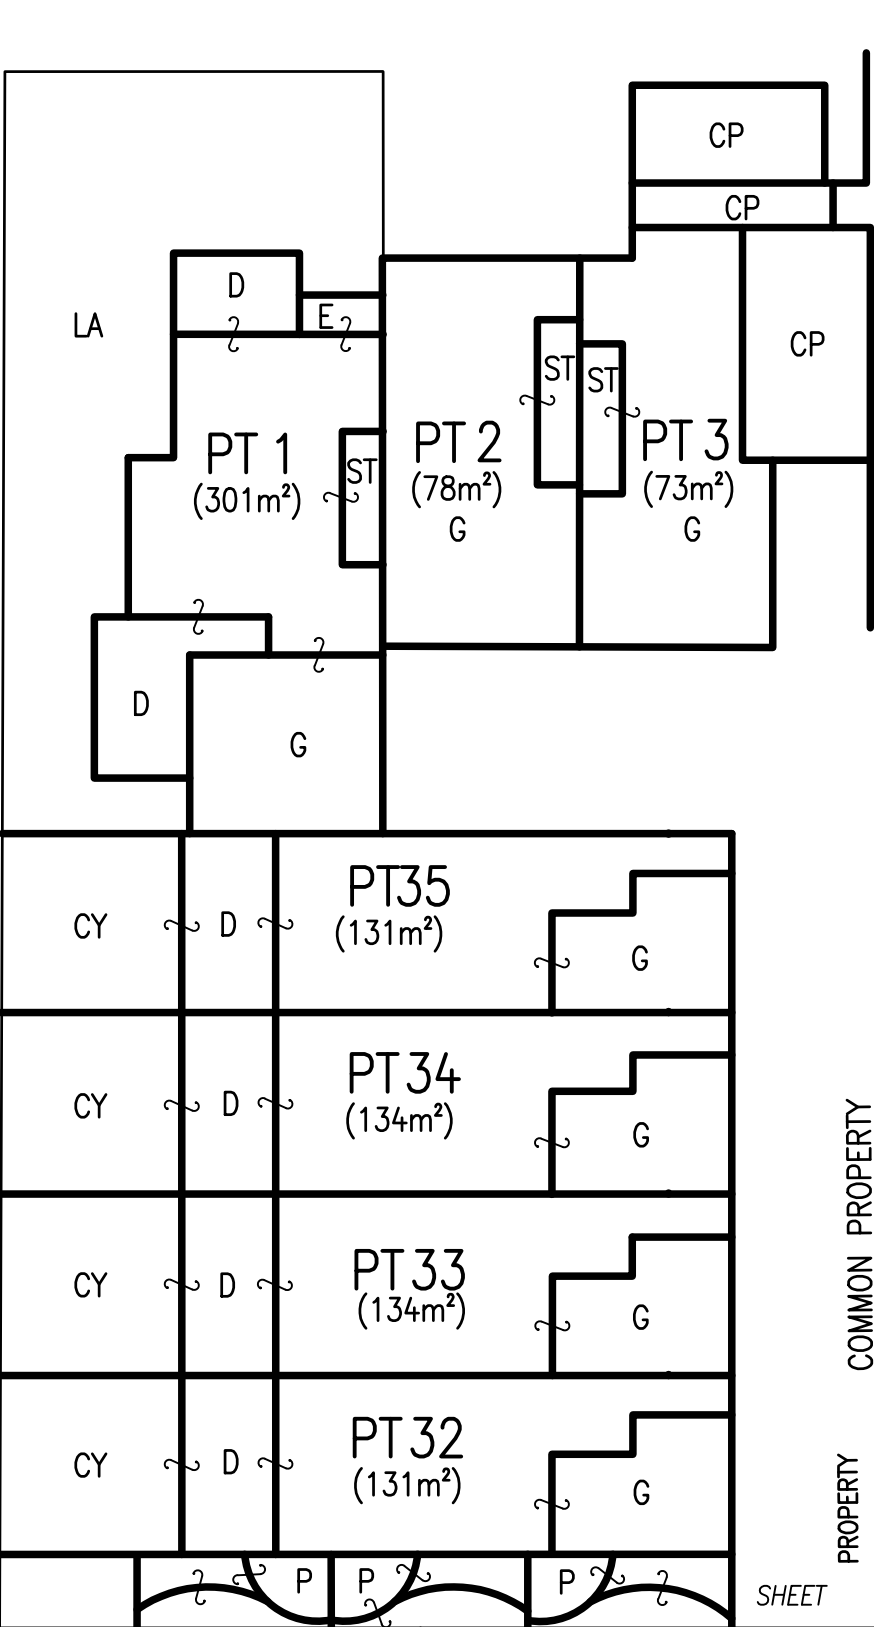

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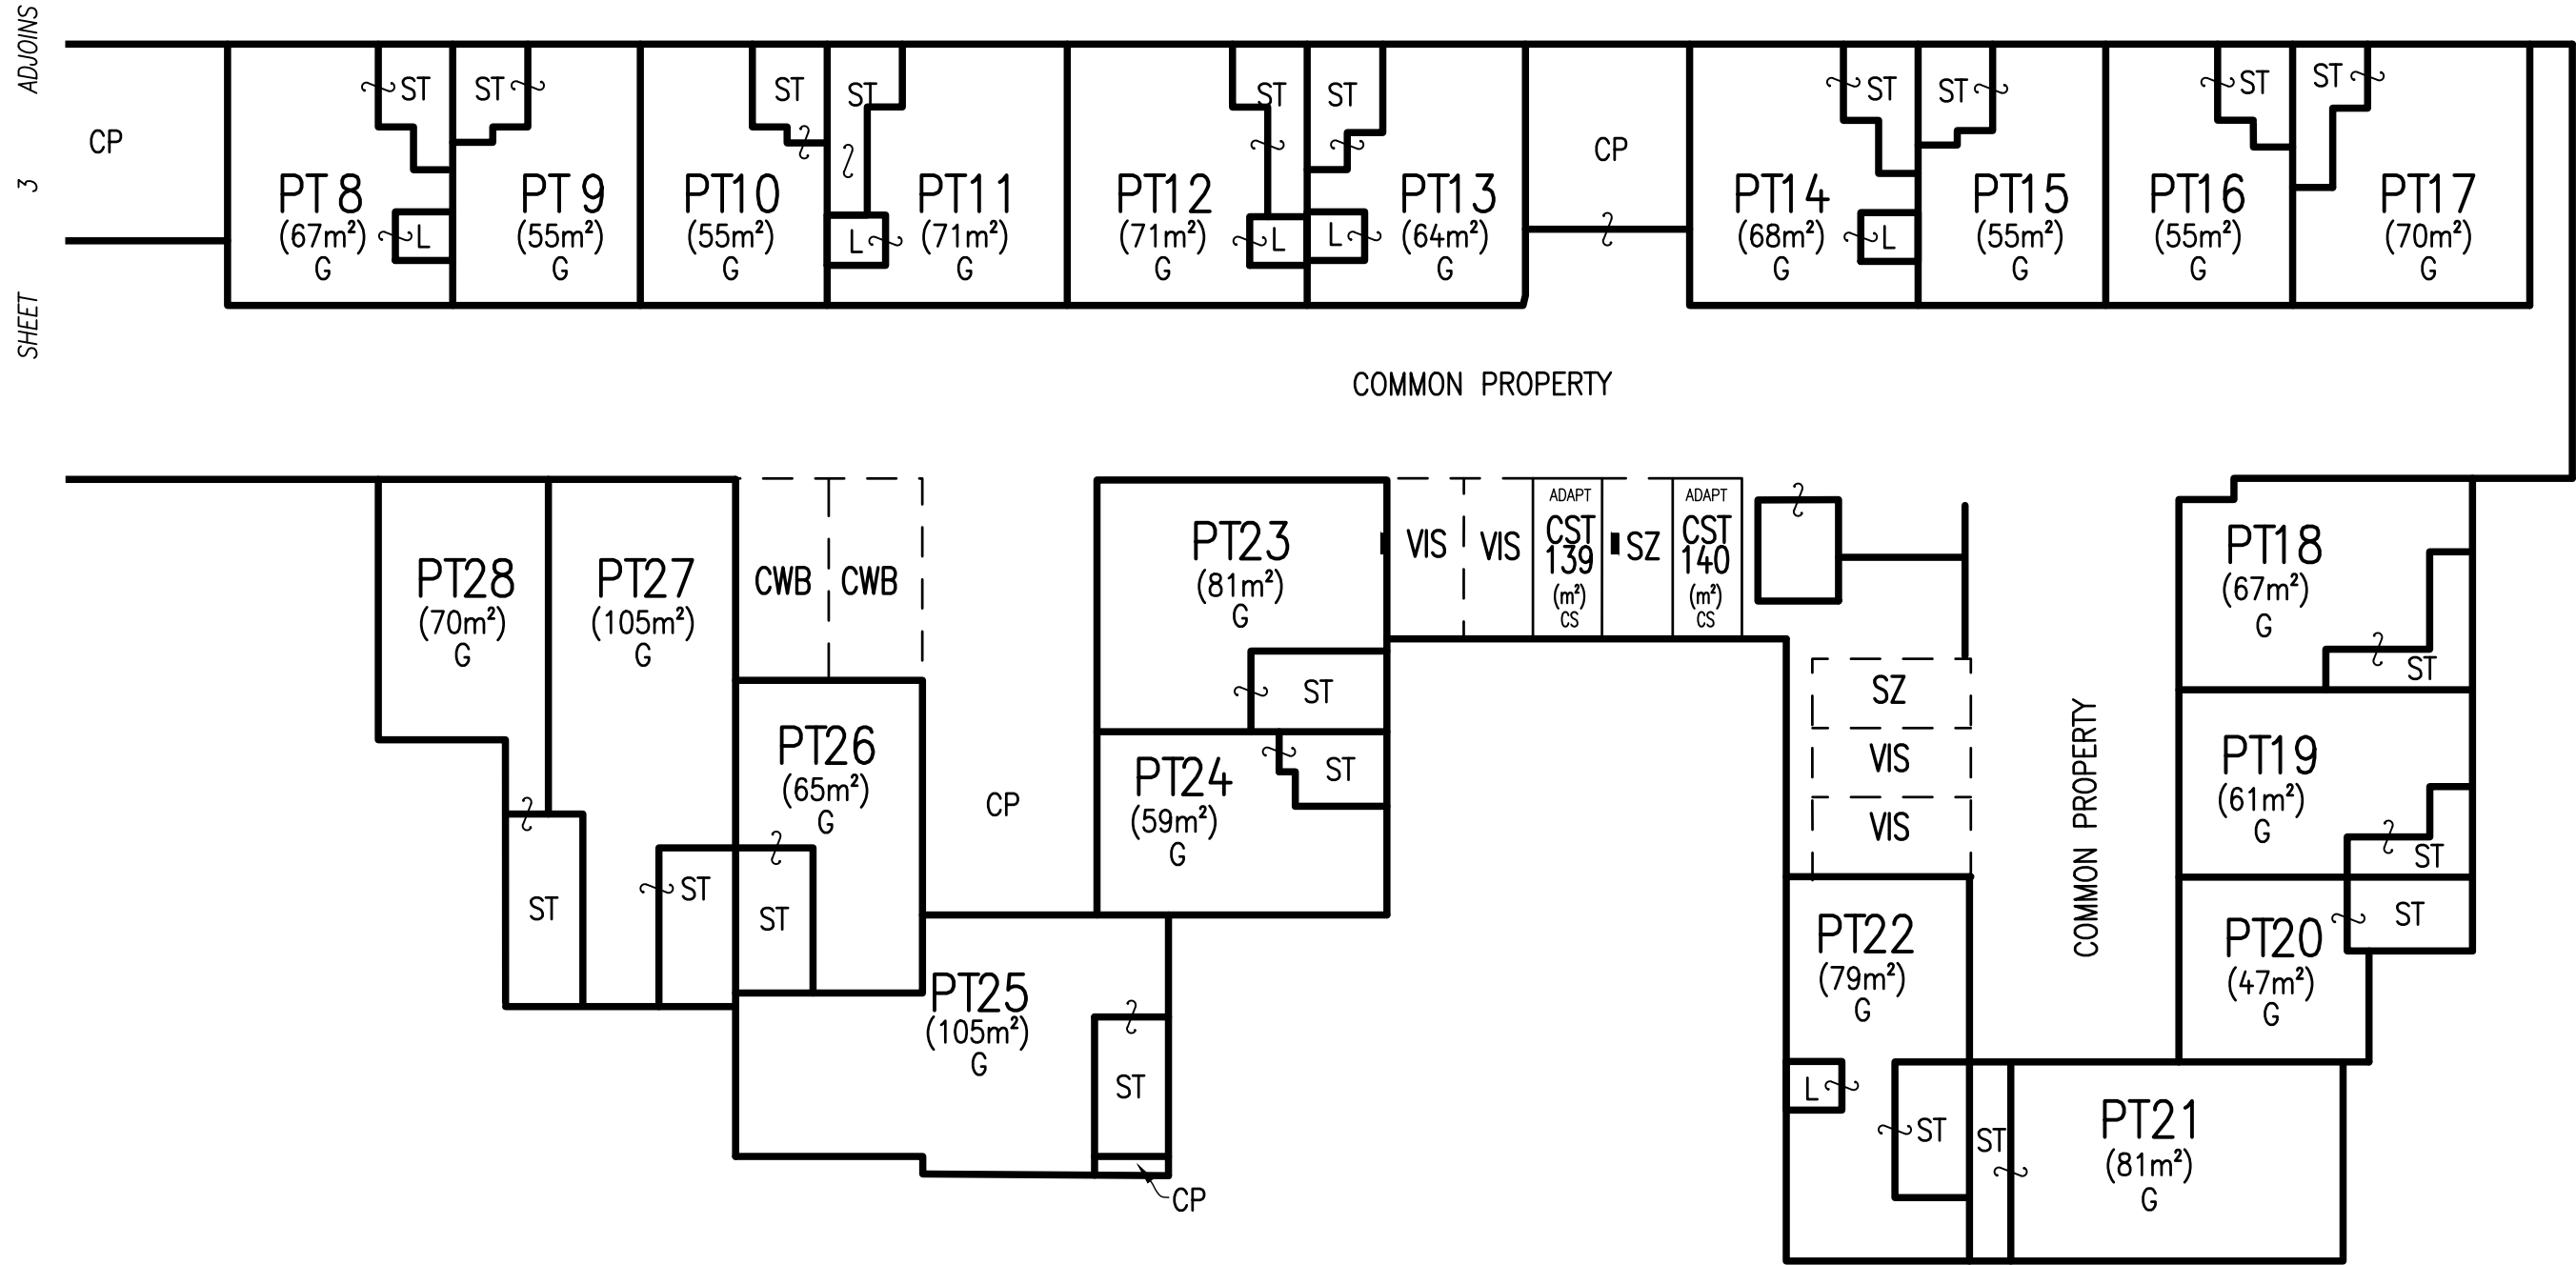
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<div>Name: ADAM RICHARDSON</div> <div>Date: XX/XXX/XX</div> <div>Reference: 170224 DSP</div>	<div>PLAN OF SUBDIVISION OF 1-21</div> <div>DILLWYNNIA GROVE</div>	<div>LGA: SUTHERLAND SHIRE</div> <div>Locality: HEATHCOTE</div> <div>Reduction Ratio: 1:250</div> <div>Lengths are in metres.</div>	<div>REGISTERED</div> <div>CONTRACT PLAN</div> <div>Plan compiled from architectural CAD data.</div> <div>Plan is subject to final survey after completion of construction.</div>	<div>DRAFT</div> <div>PRINTED 23 NOV 2020</div> <div>ISSUE 10</div>
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THIS PLAN IS BASED ON PLANS BY
ARCHITECT
DWG No.: 2-201026_HG_OVERALL MARKETING_B1_DWG FOR STRATA
RECEIVED: 26 OCT 2020

BASEMENT LEVEL 1



- ADAPT- DENOTES ADAPTABLE UNIT CAR SPACE

CP - DENOTES COMMON PROPERTY

CY - DENOTES COURTYARD

CS - DENOTES CAR SPACE

CST - DENOTES CAR SPACE TO BE ALLOCATED

D - DENOTES DECK

E - DENOTES ENTRY

G - DENOTES GARAGE
- L - DENOTES LIFT

LA - DENOTES LANDSCAPE AREA

P - DENOTES PLANTER

S - STORAGE AREA

ST - DENOTES STAIRS

STR - DENOTES STORAGE TO BE ALLOCATED

SZ - DENOTES SHARED ZONE

VIS - DENOTES VISITOR CAR SPACE WITHIN COMMON PROPERTY

AREAS SHOWN ON THE FLOOR PLAN HAVE BEEN CALCULATED FOR THE PURPOSE OF THE STRATA SCHEMES DEVELOPMENT ACT 2015 ONLY. THEY MAY DIFFER FROM FLOOR AREAS FOR OTHER PURPOSES.


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Name: ADAM RICHARDSON	PLAN OF SUBDIVISION OF 1-21 DILLWYNNIA GROVE	LGA: SUTHERLAND SHIRE Locality: HEATHCOTE Reduction Ratio: 1:250 Lengths are in metres.	REGISTERED CONTRACT PLAN Plan compiled from architectural CAD data. Plan is subject to final survey after completion of construction.	DRAFT PRINTED 23 NOV 2020 ISSUE 10
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BASEMENT LEVEL 1



- ADAPT – DENOTES ADAPTABLE UNIT CAR SPACE
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CY – DENOTES COURTYARD
G – DENOTES GARAGE
LA – DENOTES LANDSCAPED AREA
S – DENOTES ALLOCATED STORAGE SPACE
VIS – DENOTES VISITOR CAR SPACE WITHIN COMMON PROPERTY

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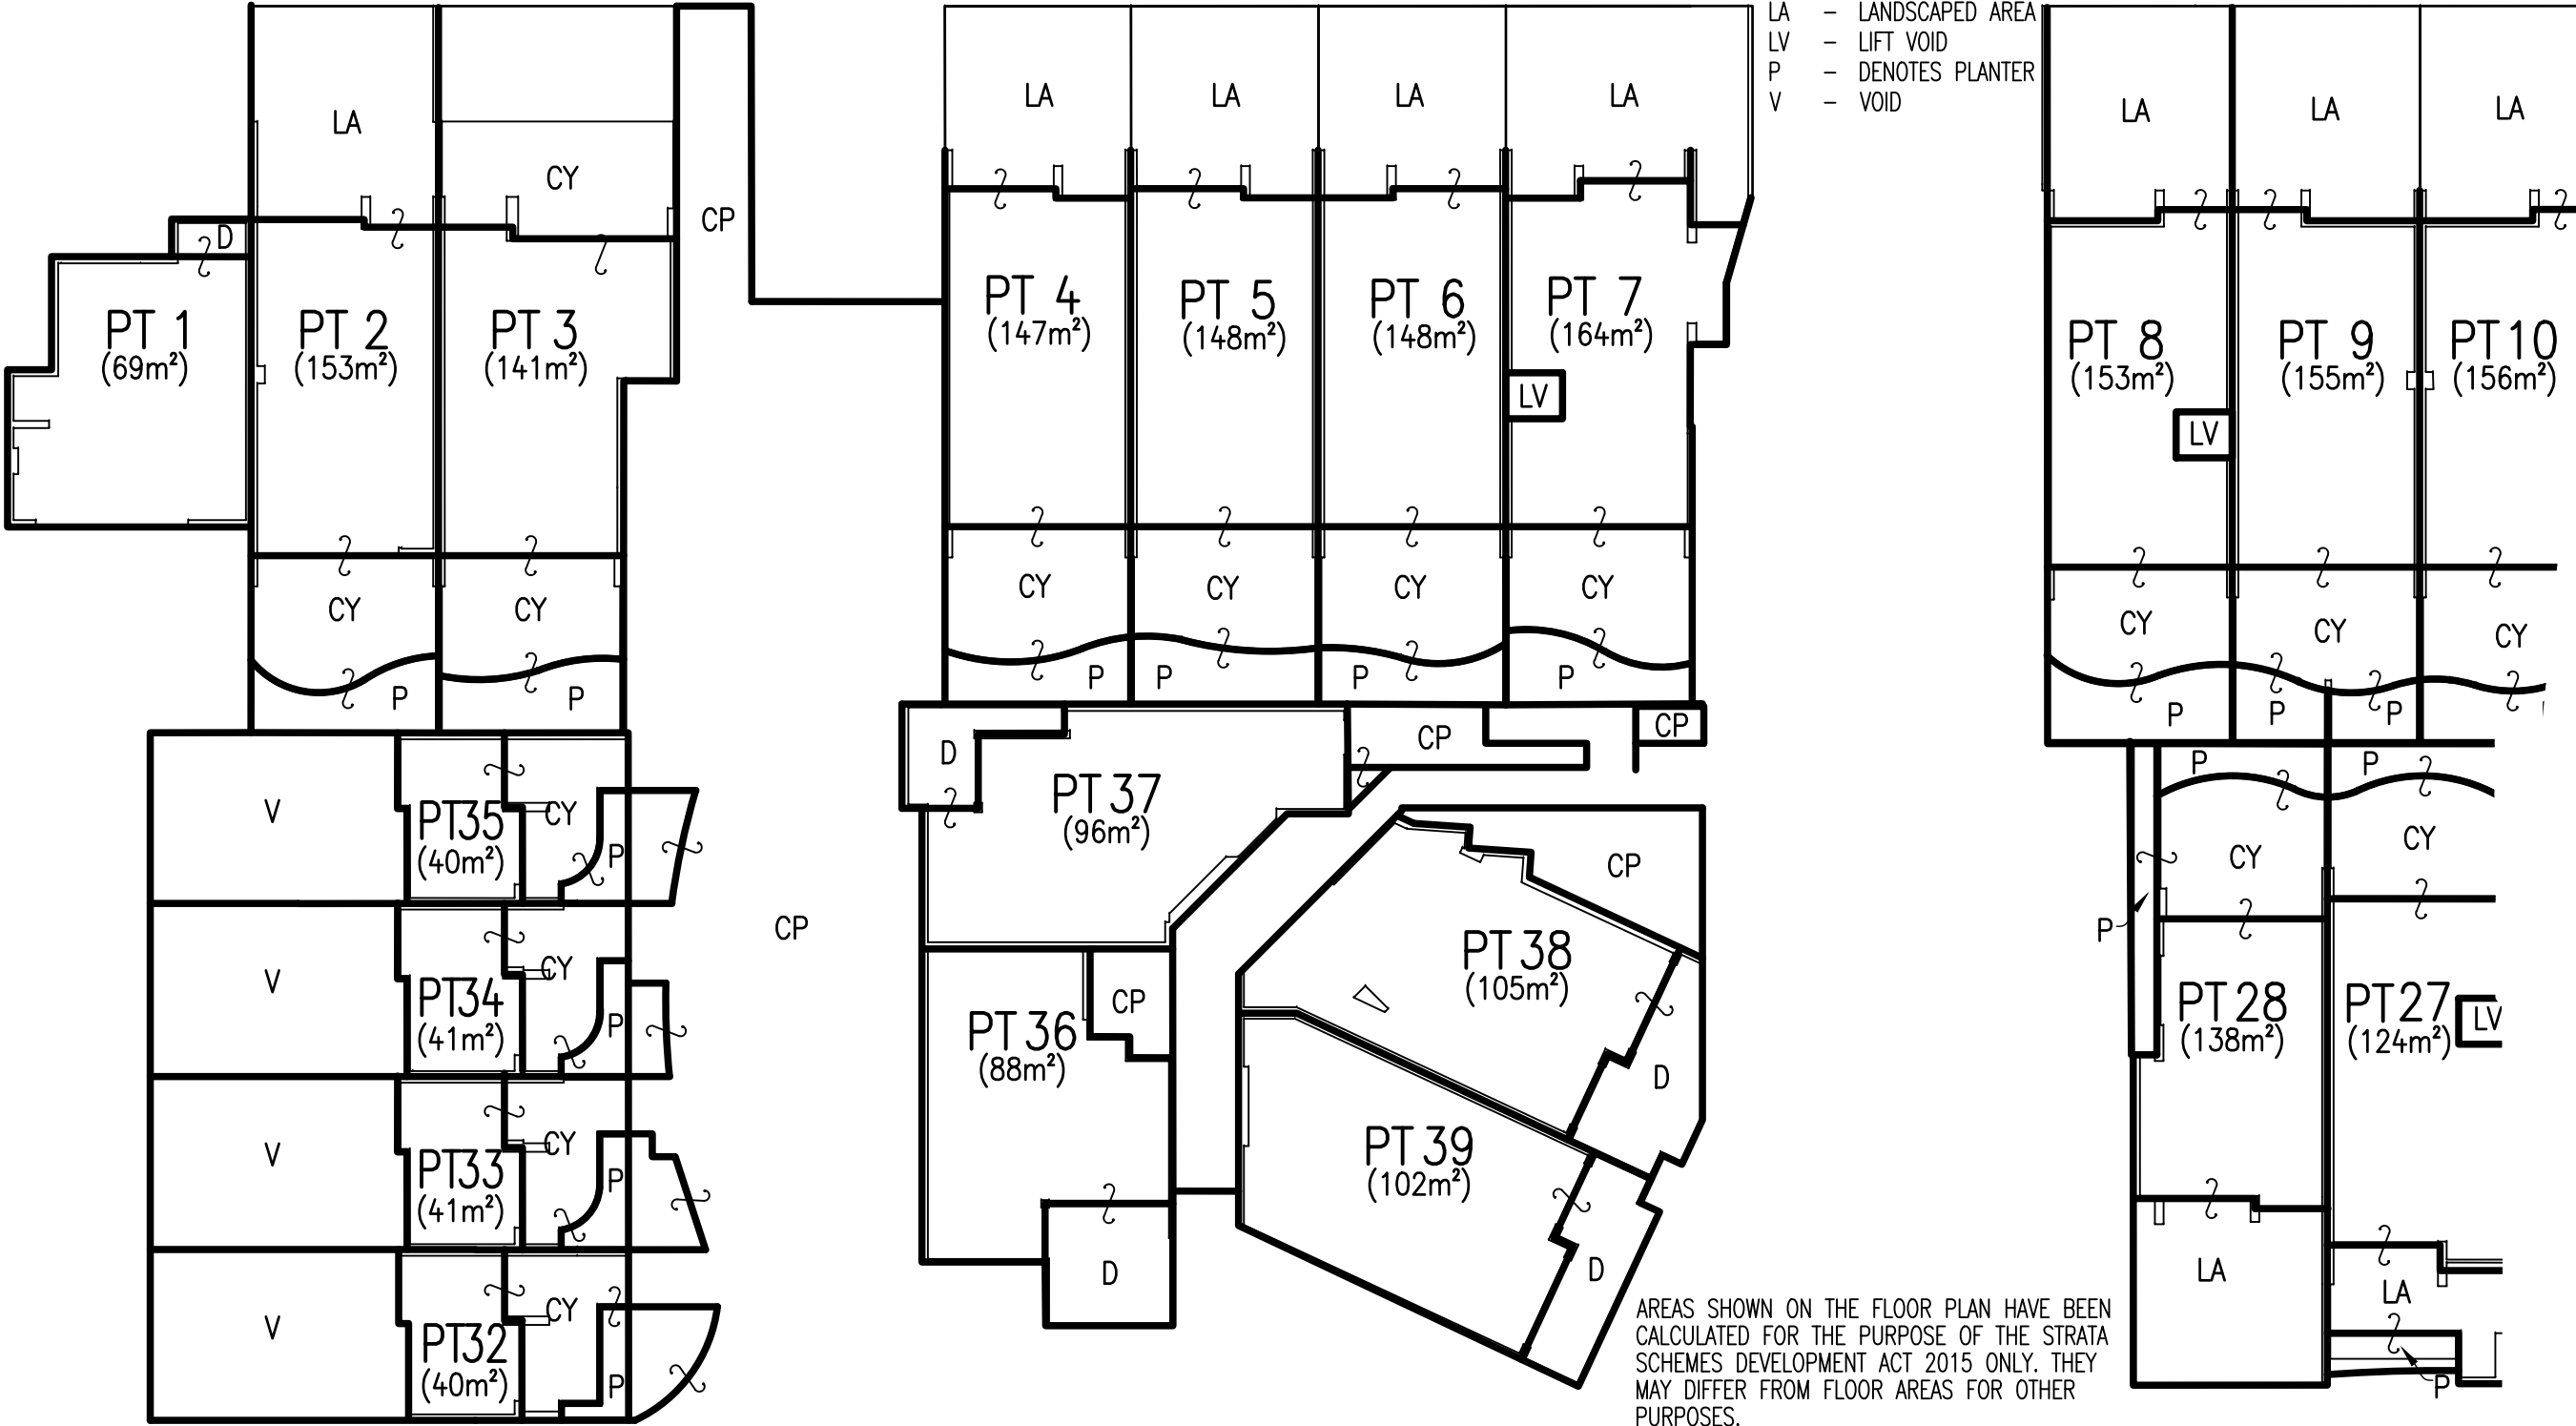
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DWG No.: 3-201026_HG_OVERALL MARKETING_LEVEL GROUND_DWG FOR STRATA
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GROUND LEVEL

- CP - DENOTES COMMON PROPERTY
- CY - DENOTES COURTYARD
- D - DENOTES DECK
- E - DENOTES ENTRY
- LA - LANDSCAPED AREA
- LV - LIFT VOID
- P - DENOTES PLANTER
- V - VOID

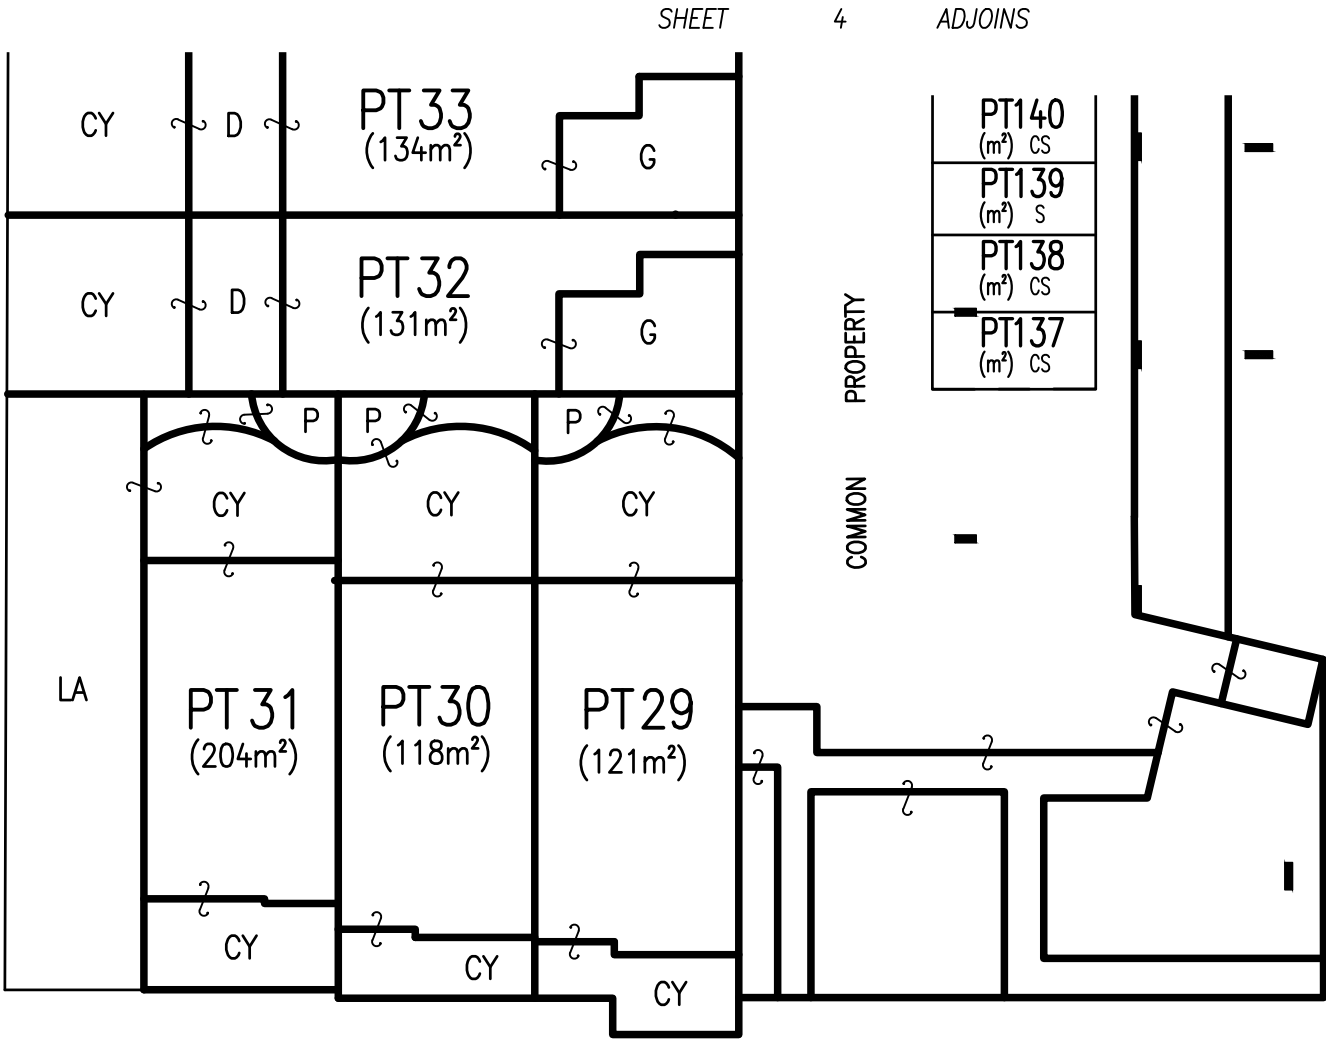

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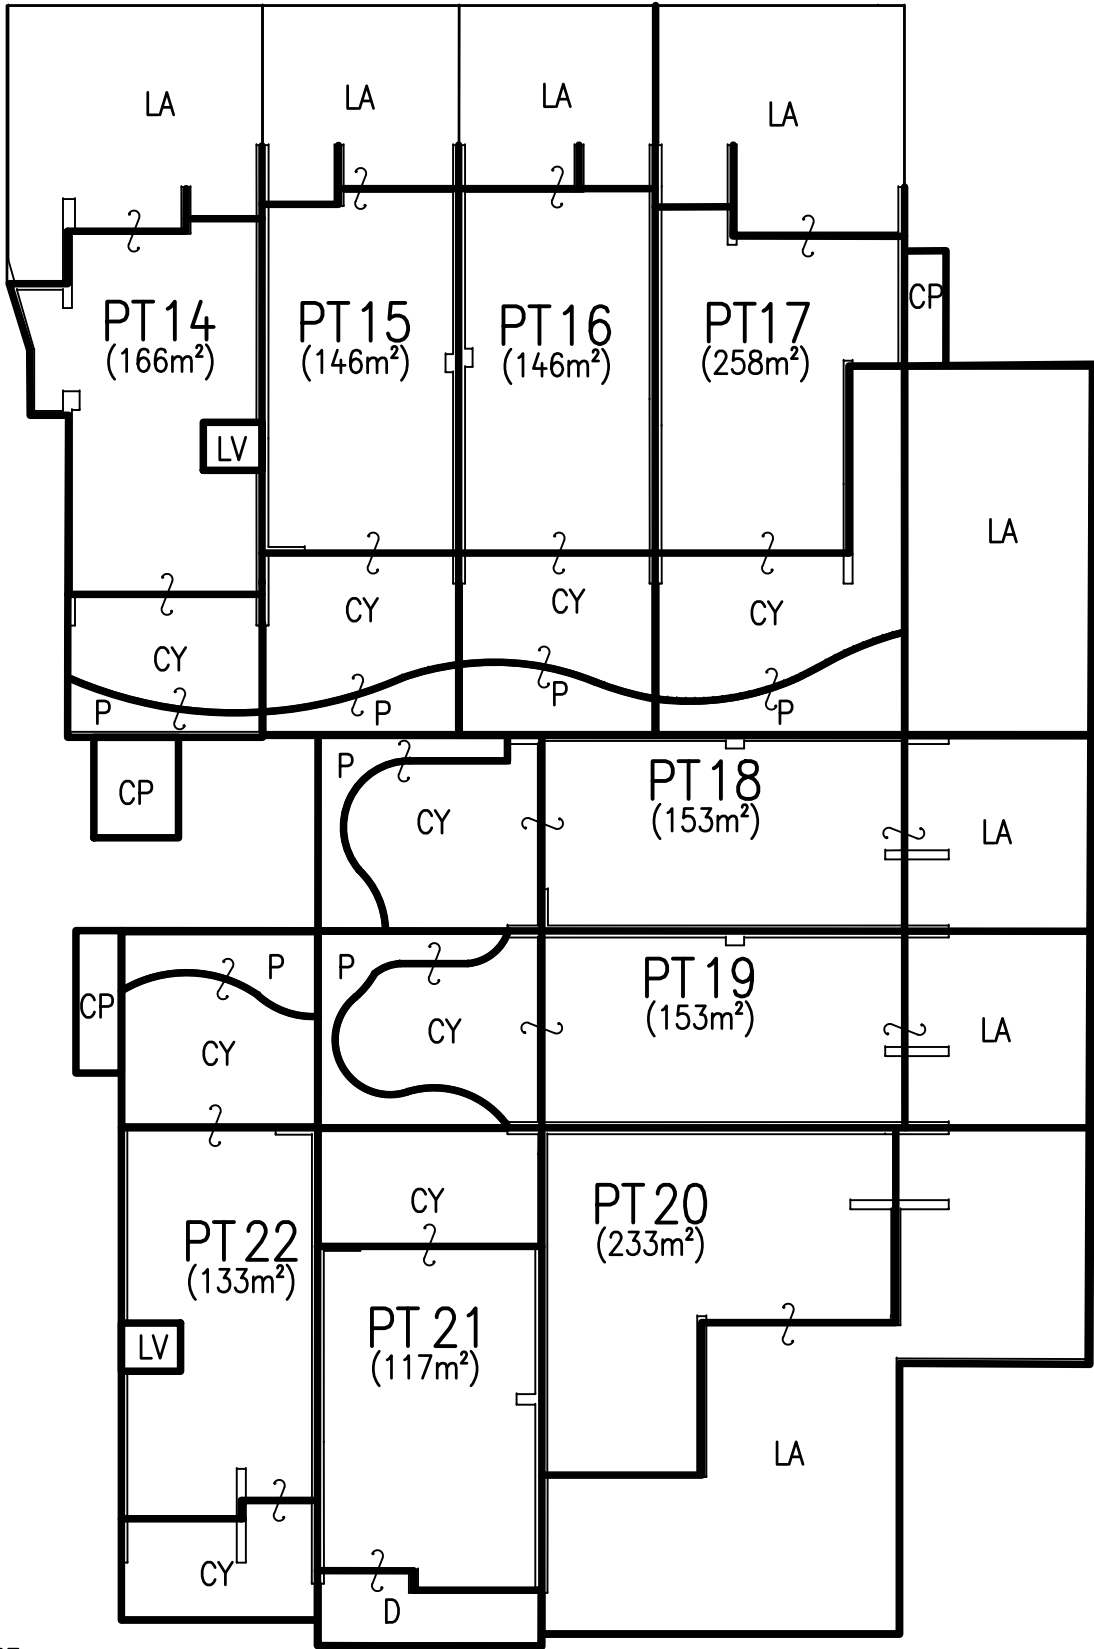
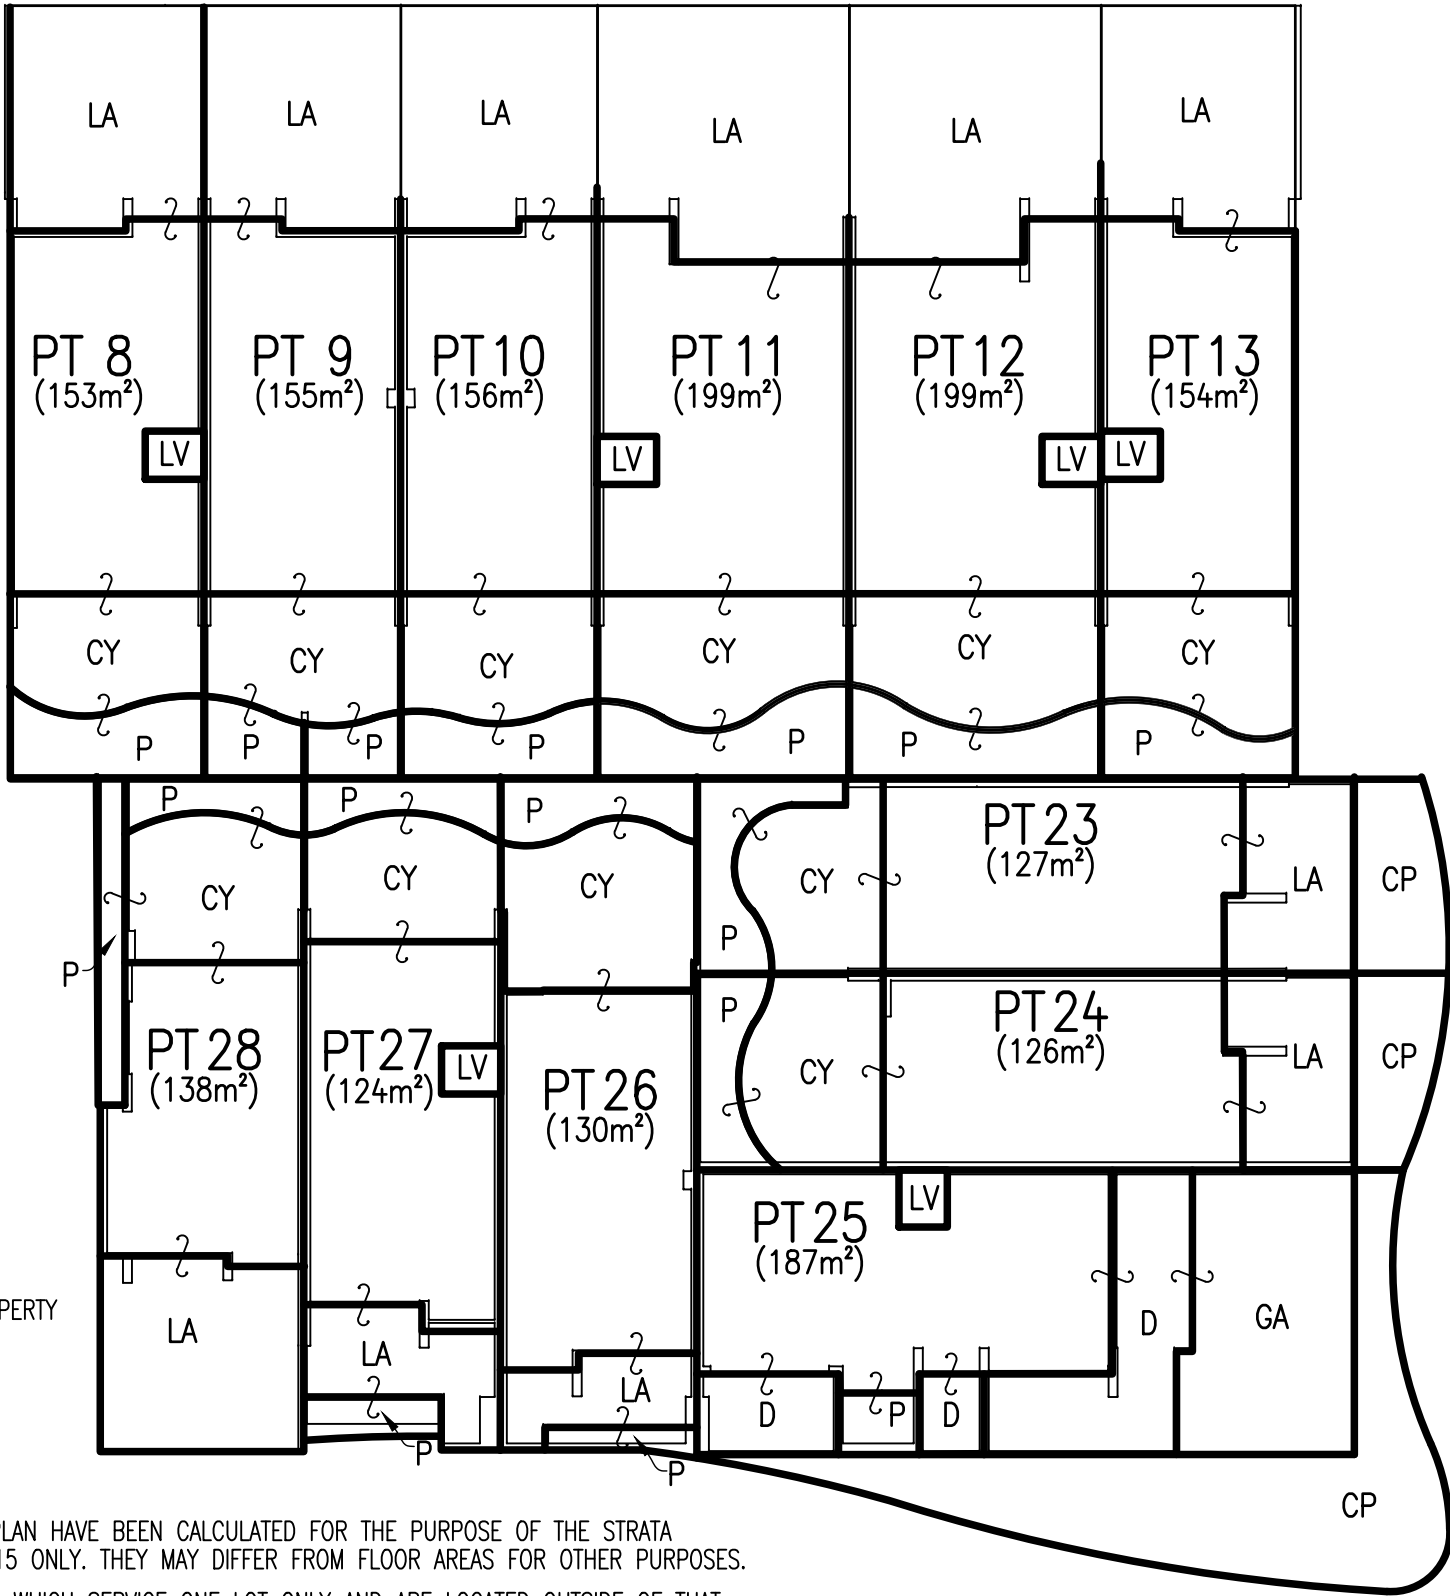
CONTINUED ON SHEET 8

THE AREAS BELOW STAIRS FORM PART OF THE RESPECTIVE LOT.

Name: ADAM RICHARDSON Date: XX/XXX/XX Reference: 170224 DSP	PLAN OF SUBDIVISION OF 1-21 DILLWYNNIA GROVE	LGA: SUTHERLAND SHIRE Locality: HEATHCOTE Reduction Ratio: 1:250 Lengths are in metres.	REGISTERED CONTRACT PLAN Plan compiled from architectural CAD data. Plan is subject to final survey after completion of construction.	DRAFT PRINTED 23 NOV 2020 ISSUE 10
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GROUND LEVEL



- CP - DENOTES COMMON PROPERTY
- CY - DENOTES COURTYARD
- D - DENOTES DECK
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- P - DENOTES PLANTER
- V - VOID

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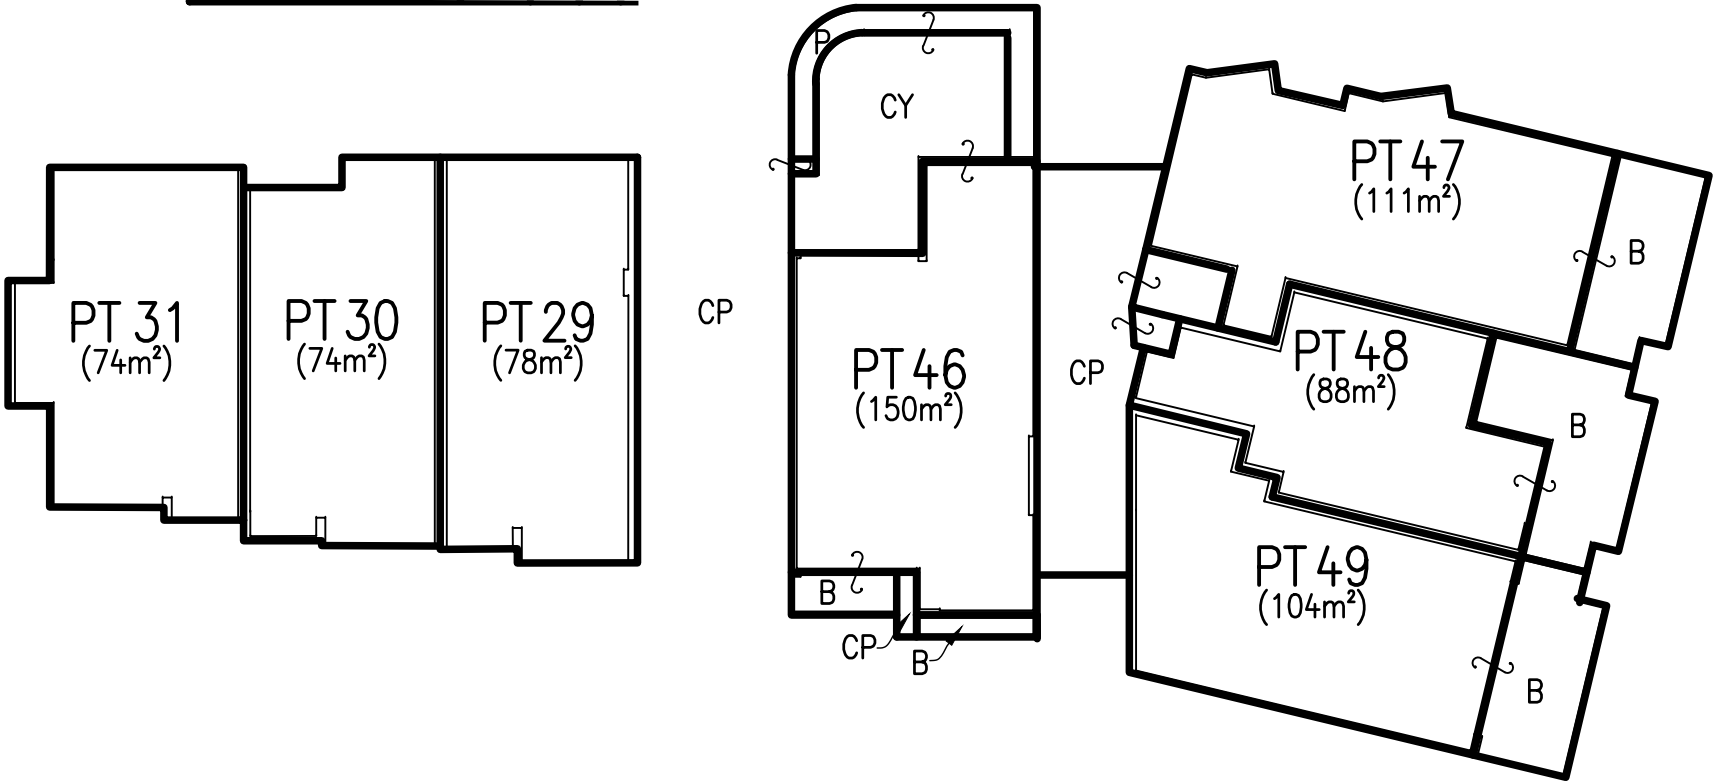
THE AREAS BELOW STAIRS FORM PART OF THE RESPECTIVE LOT.

Name: ADAM RICHARDSON	PLAN OF SUBDIVISION OF 1-21 DILLWYNNIA GROVE	LGA: SUTHERLAND SHIRE Locality: HEATHCOTE Reduction Ratio: 1:250 Lengths are in metres.	REGISTERED CONTRACT PLAN Plan compiled from architectural CAD data. Plan is subject to final survey after completion of construction.	DRAFT PRINTED 23 NOV 2020 ISSUE 10
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RECEIVED: 26 OCT 2020

GROUND LEVEL

CONTINUED FROM SHEET 6




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- CP – DENOTES COMMON PROPERTY
- CY – DENOTES COURTYARD
- D – DECK
- P – DENOTES PLANTER
- V – DENOTES VOID

Name: ADAM RICHARDSON Date: XX/XXX/XX Reference: 170224 DSP	PLAN OF SUBDIVISION OF 1-21 DILLWYNNIA GROVE	LGA: SUTHERLAND SHIRE Locality: HEATHCOTE Reduction Ratio: 1:250 Lengths are in metres.	REGISTERED CONTRACT PLAN Plan compiled from architectural CAD data. Plan is subject to final survey after completion of construction.	DRAFT PRINTED 23 NOV 2020 ISSUE 10
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DWG No.: 4-201026_HG_OVERALL MARKETING_LEVEL 1_DWG FOR STRATA
RECEIVED: 26 OCT 2020

LEVEL 1



CP - COMMON PROPERTY
D - DECK
E - ENTRY
T - TERRACE
LV - LIFT VOID
P - PLANTER
V - VOID

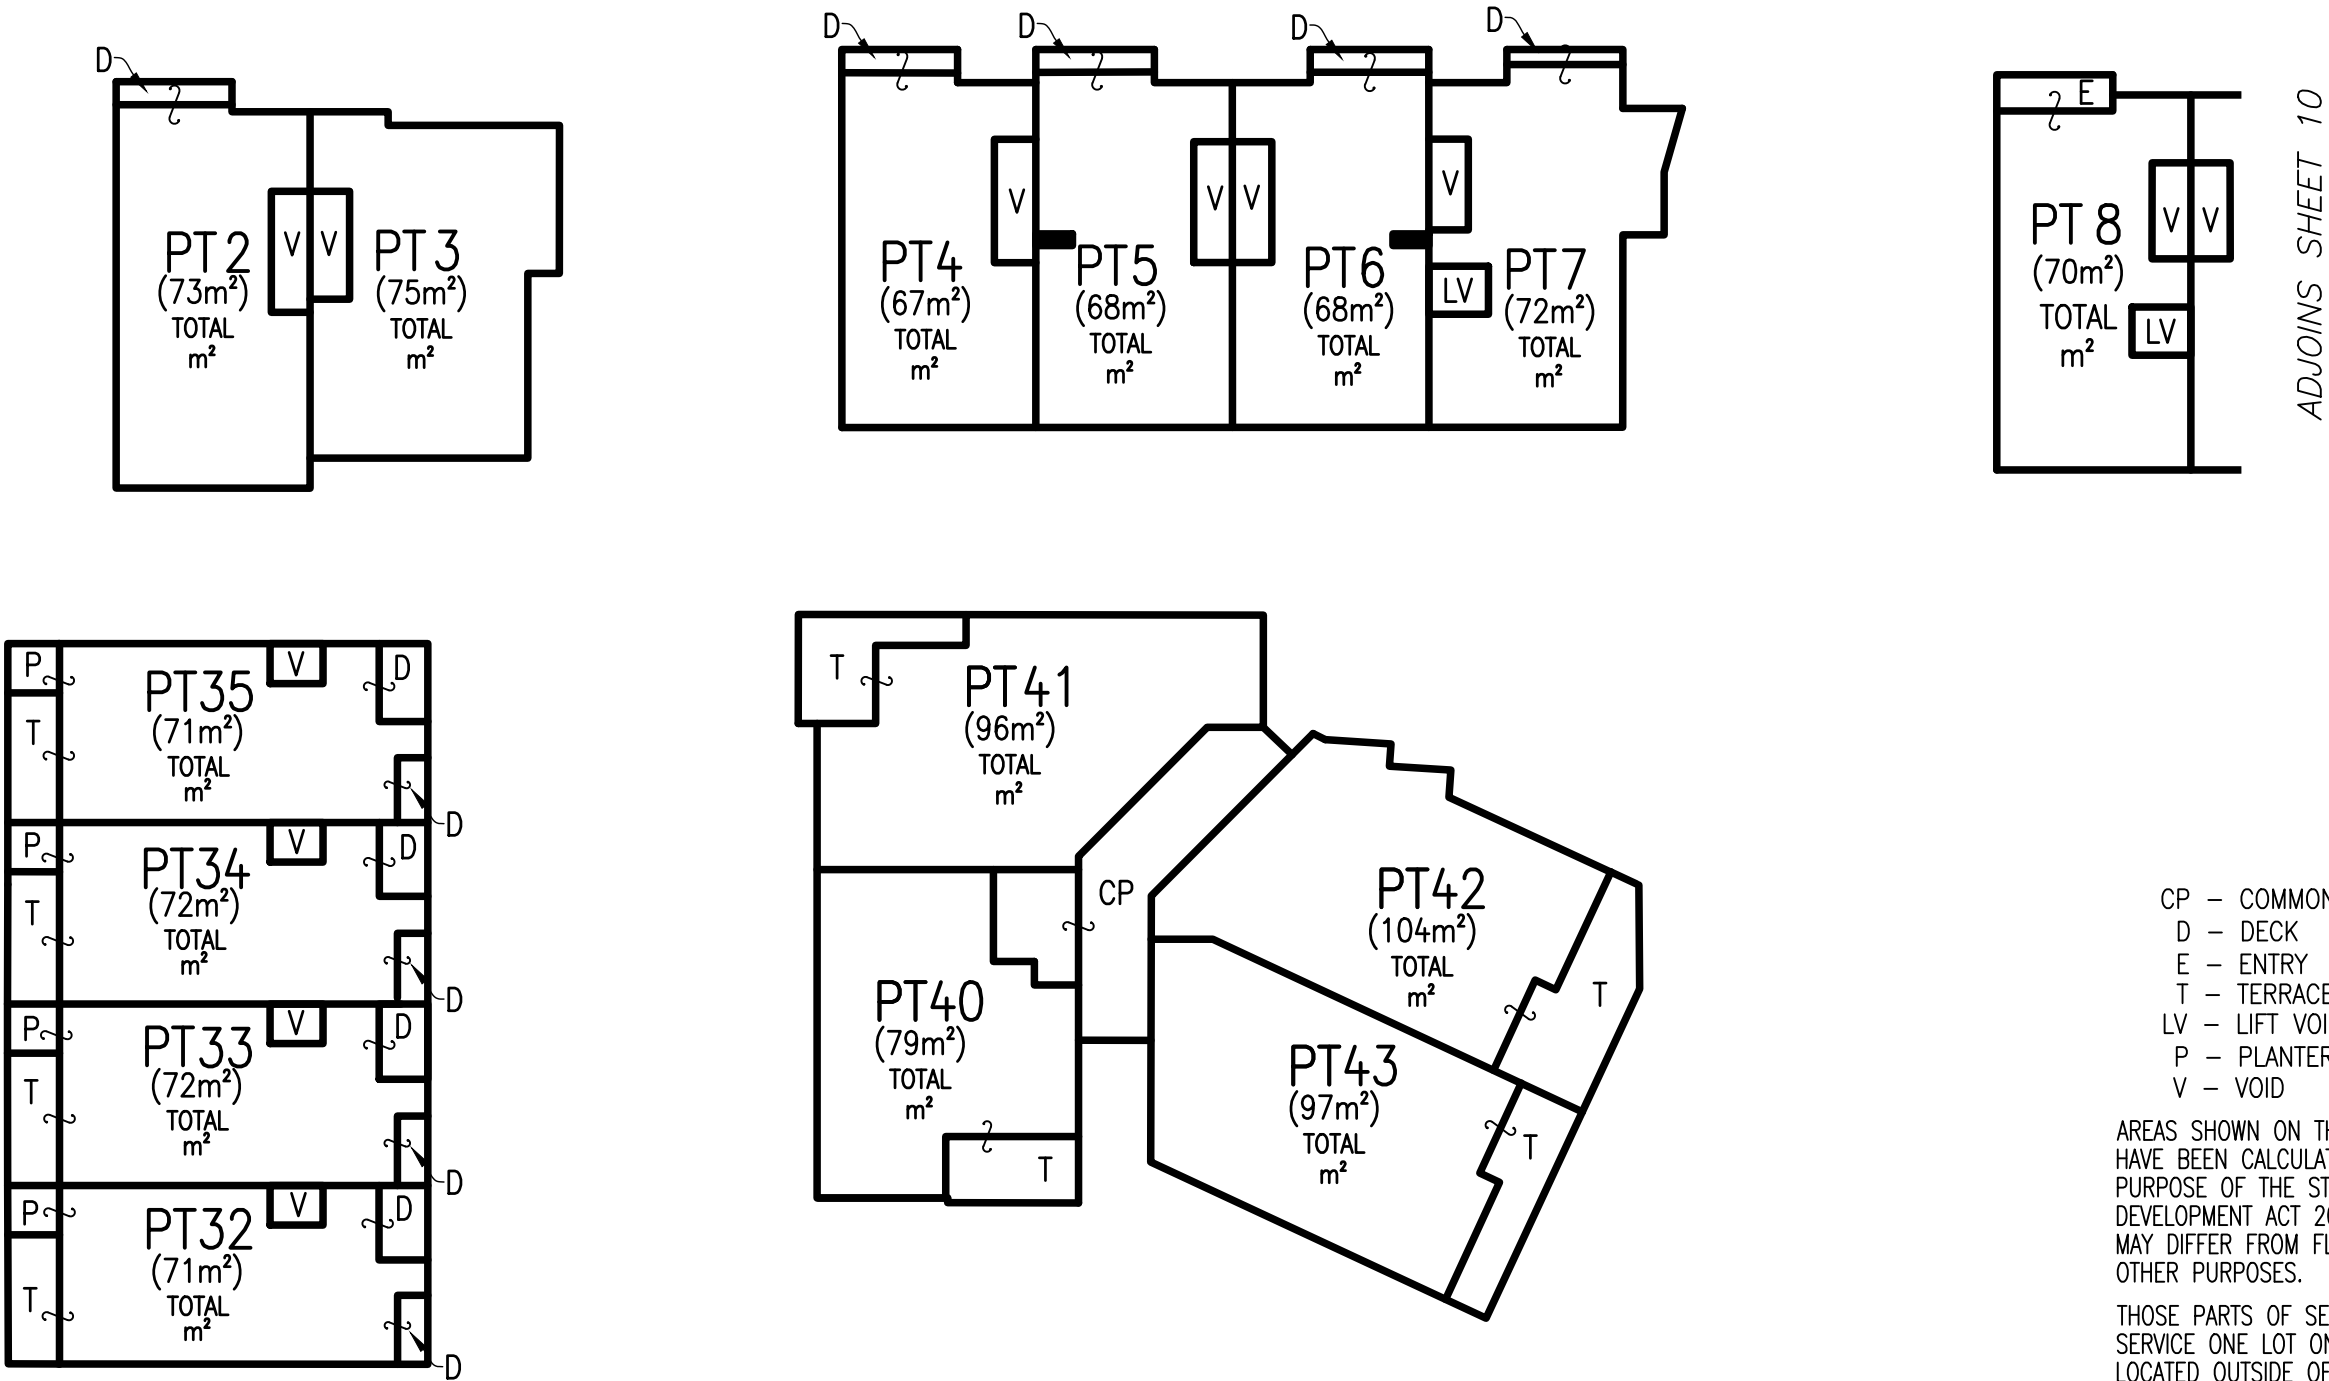AREAS SHOWN ON THE FLOOR PLAN
HAVE BEEN CALCULATED FOR THE
PURPOSE OF THE STRATA SCHEMES
DEVELOPMENT ACT 2015 ONLY. THEY
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PROPERTY STRUCTURES ARE SHOWN.

Name: ADAM RICHARDSON
Date: XX/XXX/XX
Reference: 170224 DSP

PLAN OF SUBDIVISION OF 1-21
DILLWYNNIA GROVE





LGA: SUTHERLAND SHIRE
Locality: HEATHCOTE
Reduction Ratio: 1:250
Lengths are in metres.

REGISTERED
CONTRACT PLAN
Plan compiled from
architectural CAD data.
Plan is subject to final
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LEVEL 1



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- D – DECK
- E – ENTRY
- T – TERRACE
- LV – LIFT VOID
- P – PLANTER
- V – VOID

Name: ADAM RICHARDSON
Date: XX/XXX/XX
Reference: 170224 DSP

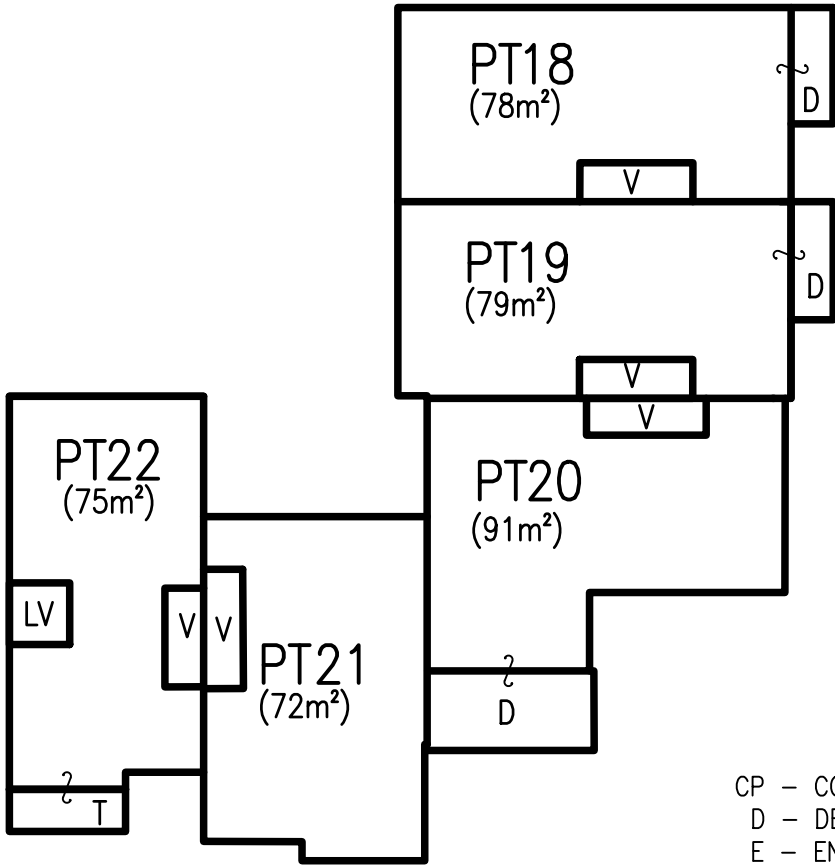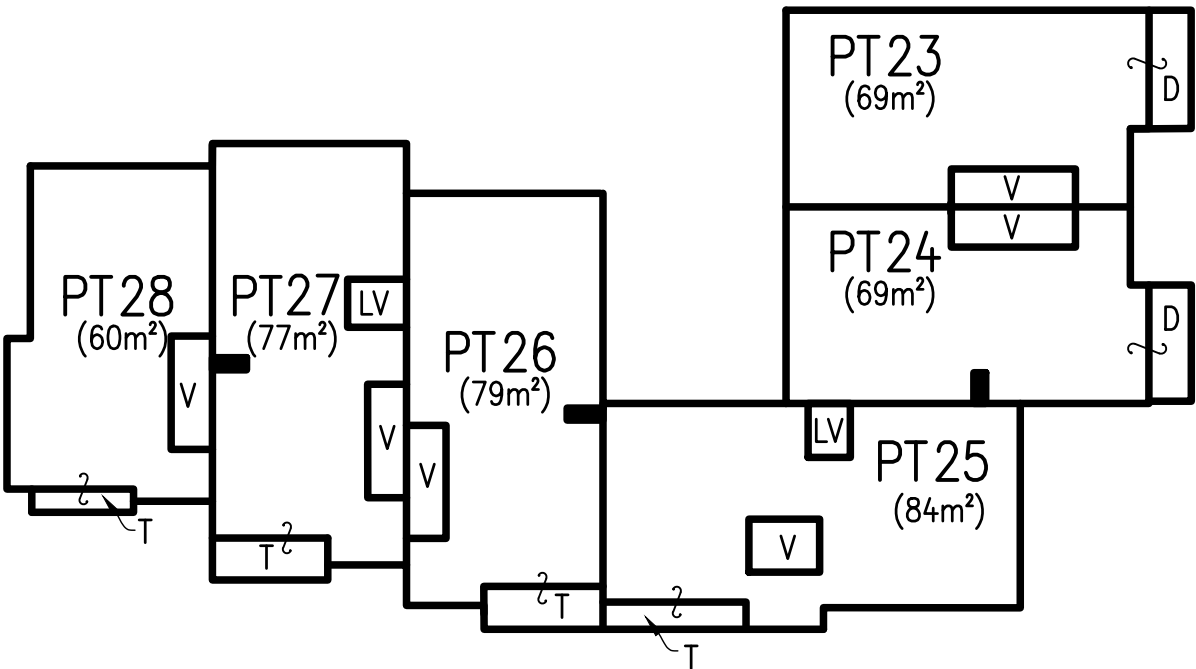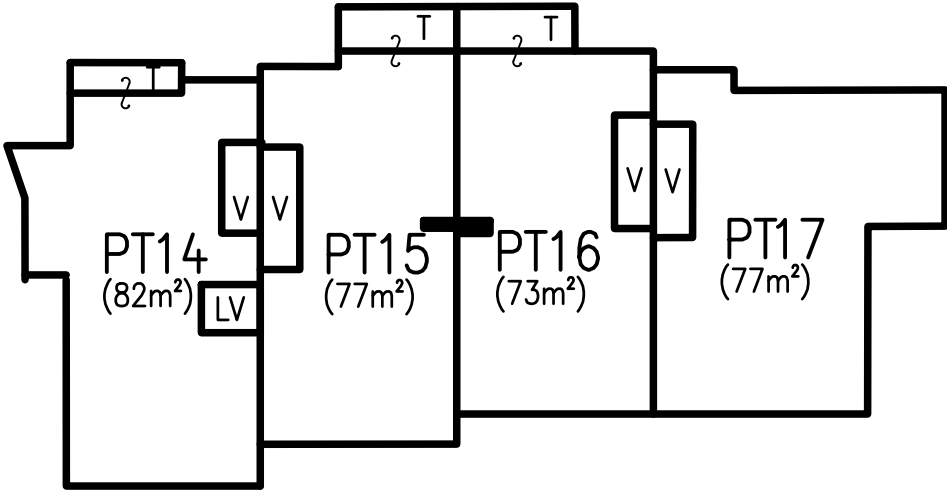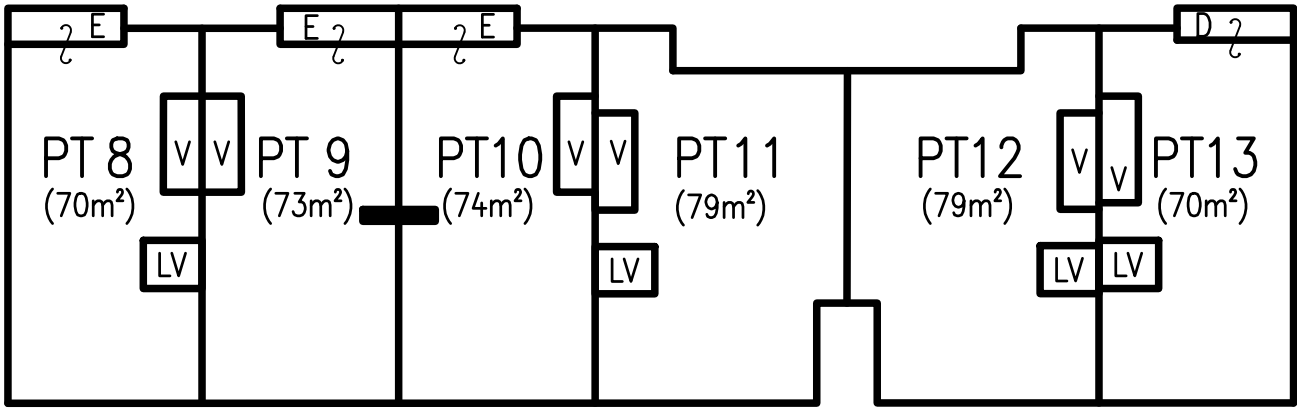PLAN OF SUBDIVISION OF 1-21
DILLWYNNIA GROVE

LGA: SUTHERLAND SHIRE
Locality: HEATHCOTE
Reduction Ratio: 1:250
Lengths are in metres.



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LEVEL 1

ADJOINS SHEET 9



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- P – PLANTER
- V – VOID

Name: ADAM RICHARDSON
Date: XX/XXX/XX
Reference: 170224 DSP

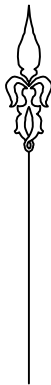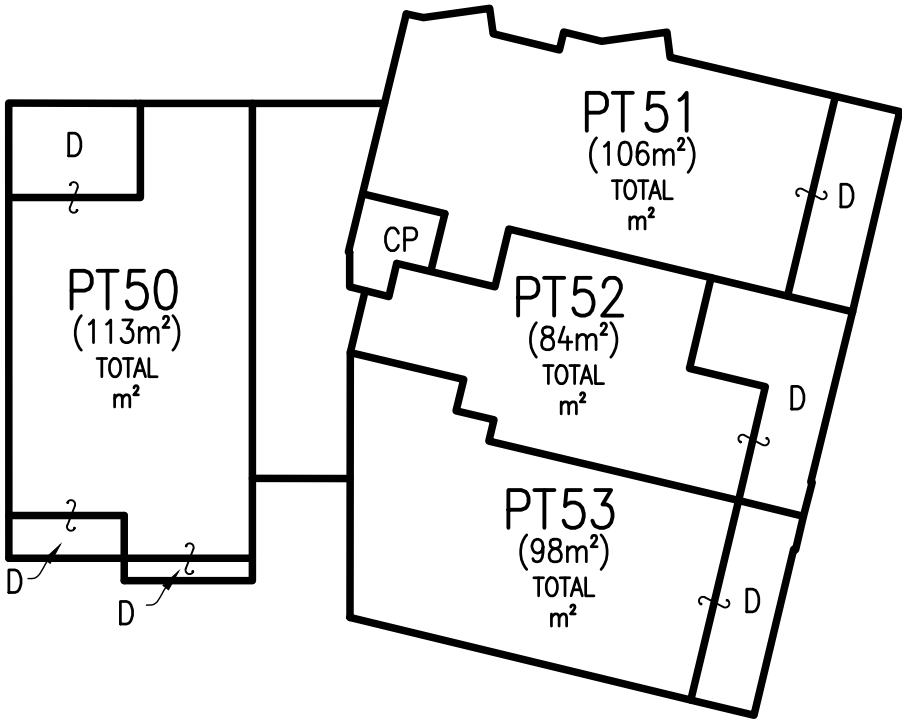PLAN OF SUBDIVISION OF 1–21
DILLWYNNIA GROVE



LGA: SUTHERLAND SHIRE
Locality: HEATHCOTE
Reduction Ratio: 1:250
Lengths are in metres.

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RECEIVED: 5 NOV 2020

LEVEL 2



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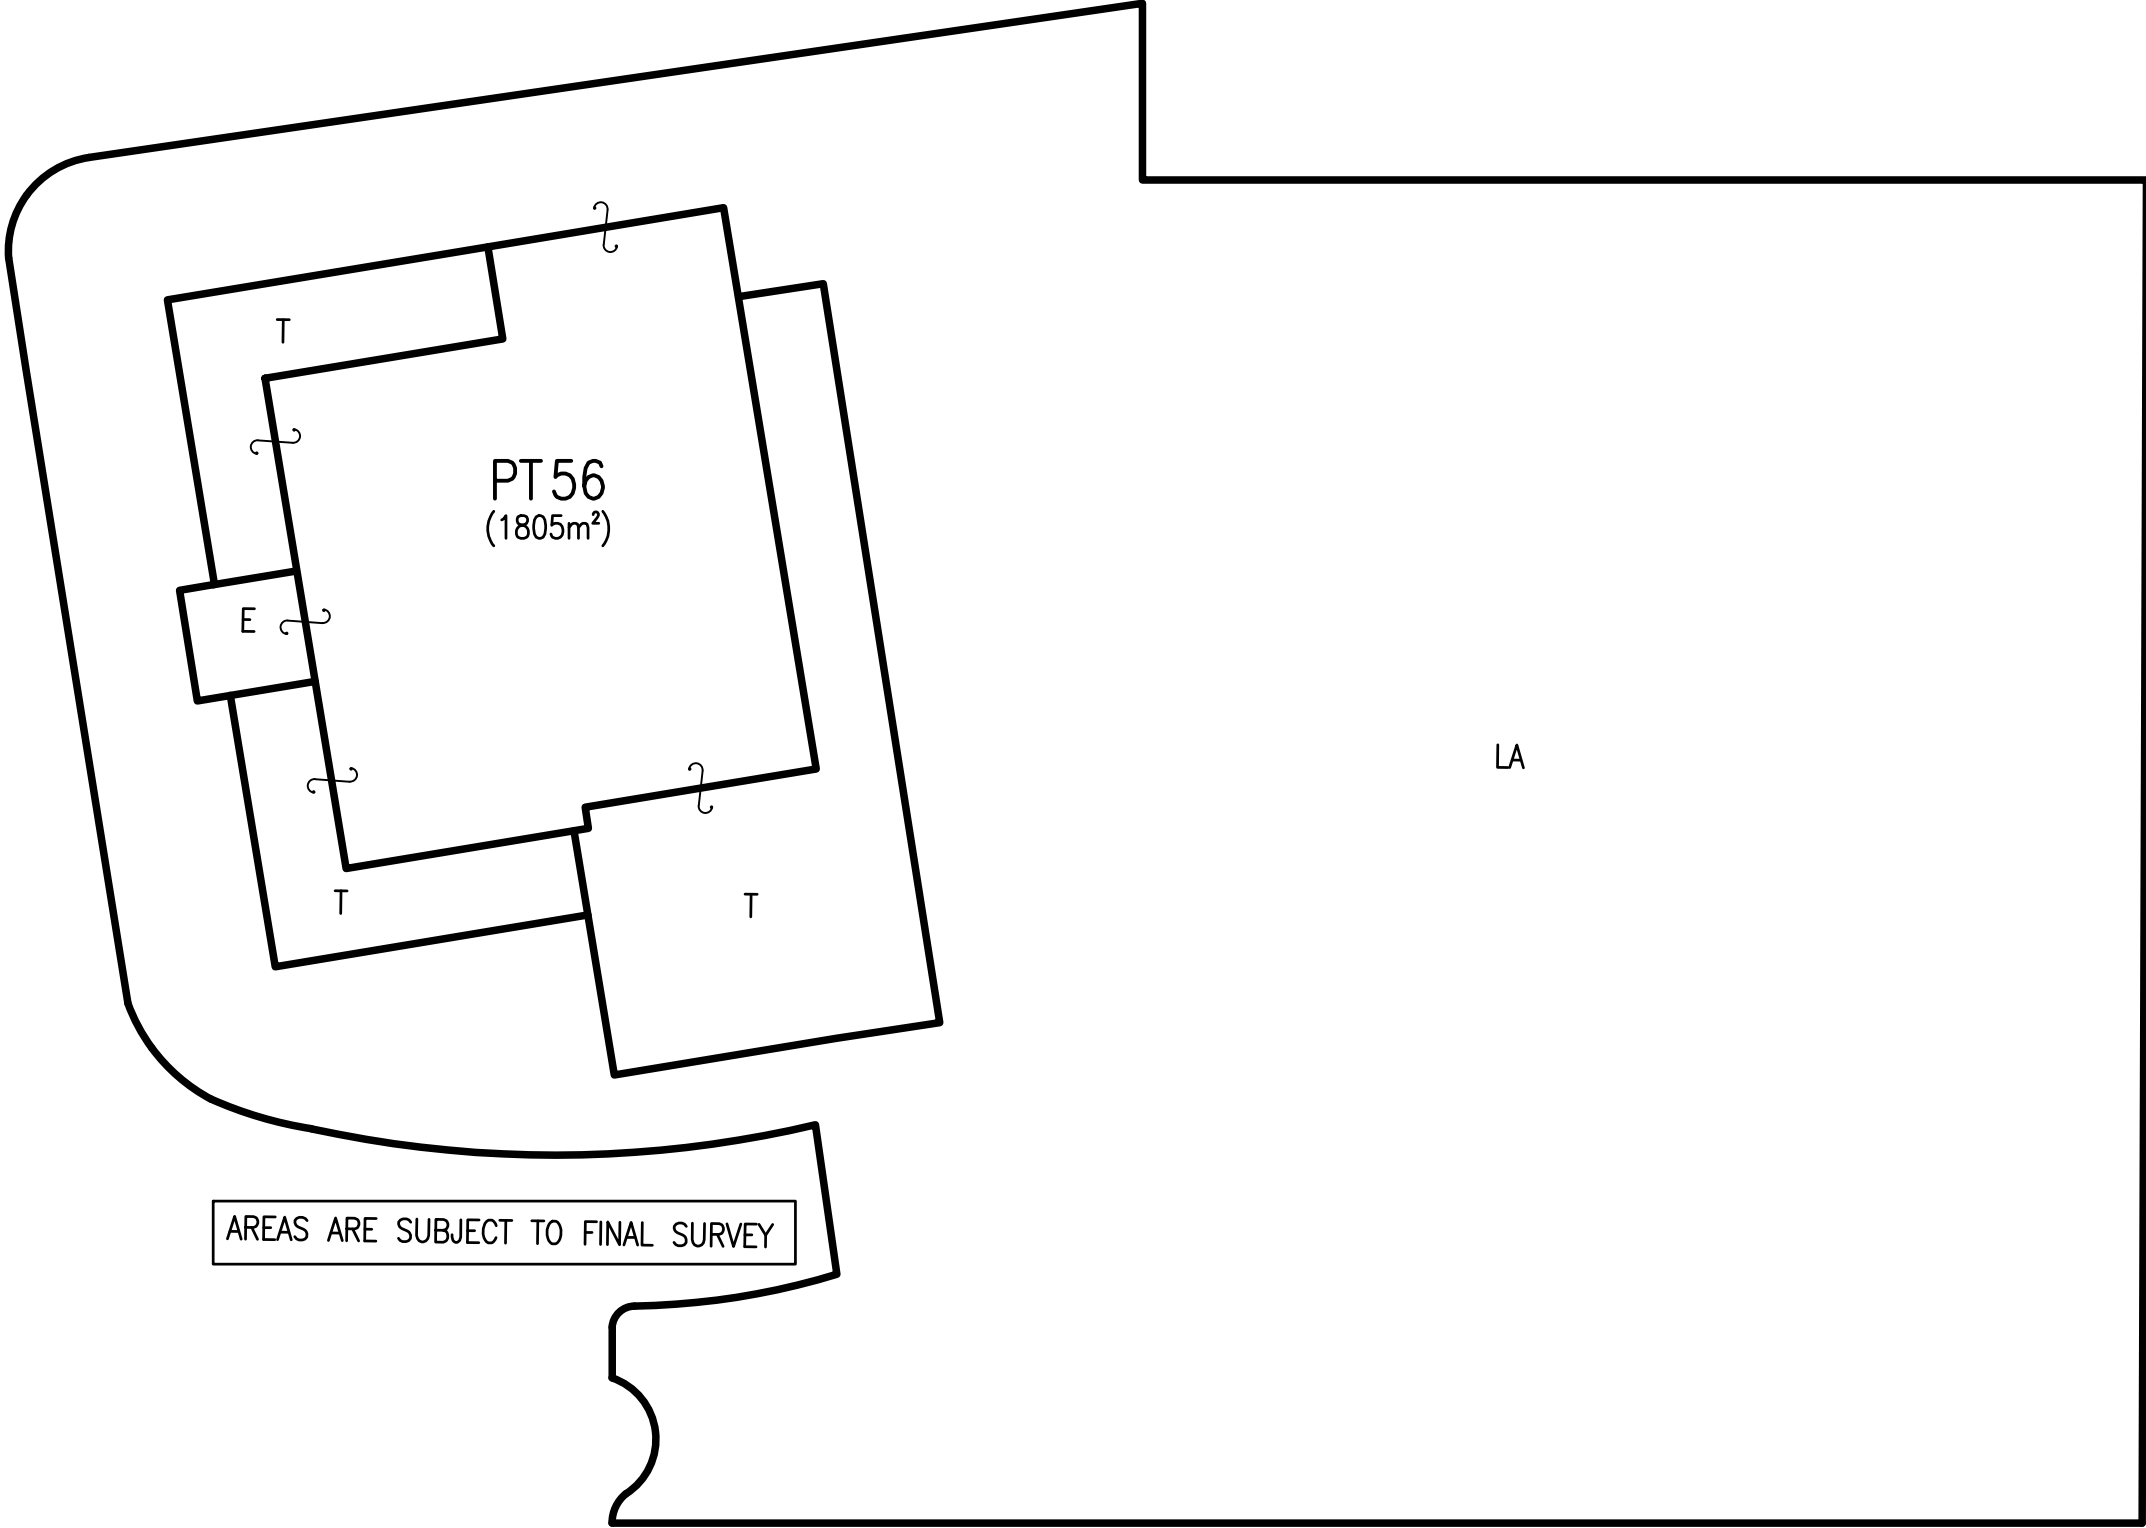
CP – COMMON PROPERTY
T – TERRACE
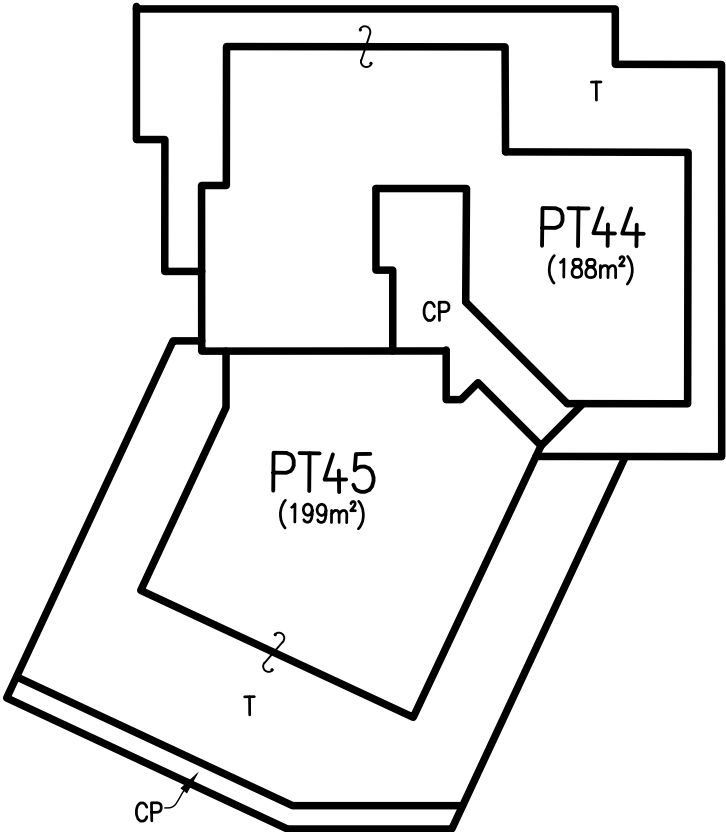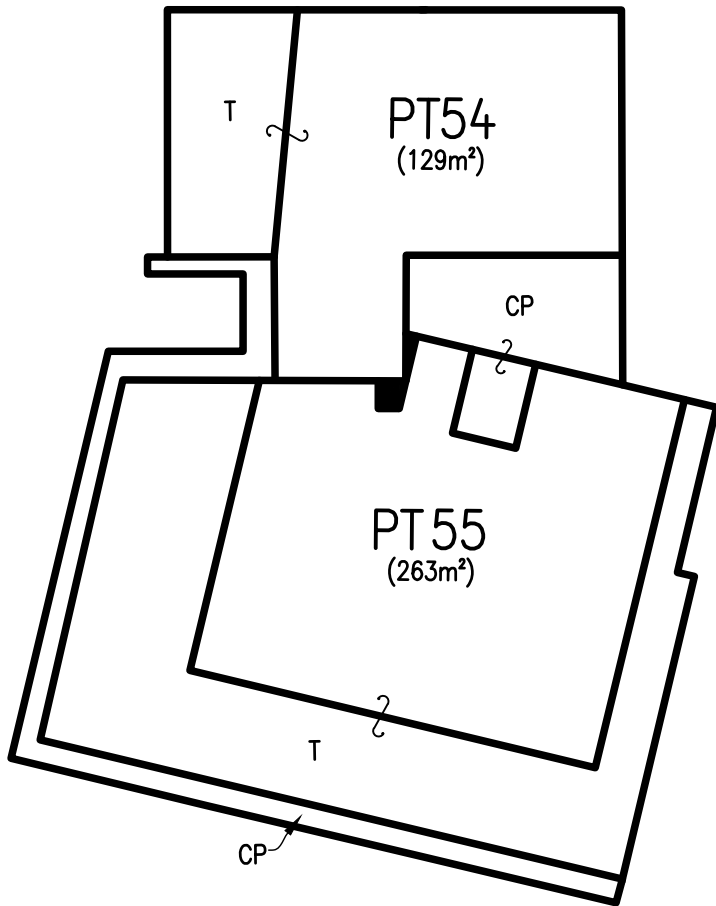
<div>Name: ADAM RICHARDSON</div> <div>Date: XX/XXX/XX</div> <div>Reference: 170224 DSP</div>	<div>PLAN OF SUBDIVISION OF 1–21</div> <div>DILLWYNNIA GROVE</div>	<div>LGA: SUTHERLAND SHIRE</div> <div>Locality: HEATHCOTE</div> <div>Reduction Ratio: 1:250</div> <div>Lengths are in metres.</div>	<div>REGISTERED</div> <div>CONTRACT PLAN</div> <div>Plan compiled from architectural CAD data.</div> <div>Plan is subject to final survey after completion of construction.</div>	<div>DRAFT</div> <div>PRINTED 23 NOV 2020</div> <div>ISSUE 10</div>
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ARCHITECT
DWG No.: 08 FIRST FLOOR PLAN
RECEIVED: 1 SEPT 2020

GROUND LEVEL – HALL

AREAS ARE SUBJECT TO FINAL SURVEY



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LA – LANDSCAPE AREA
E – ENTRY
T – TERRACE

Name: ADAM RICHARDSON
Date: XX/XXX/XX
Reference: 170224 DSP

PLAN OF SUBDIVISION OF 1–21
DILLWYNNIA GROVE

LGA: SUTHERLAND SHIRE
Locality: HEATHCOTE
Reduction Ratio: 1:200
Lengths are in metres.

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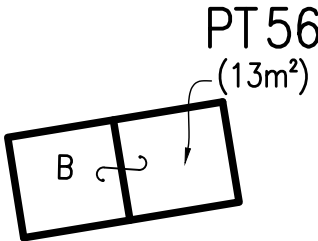
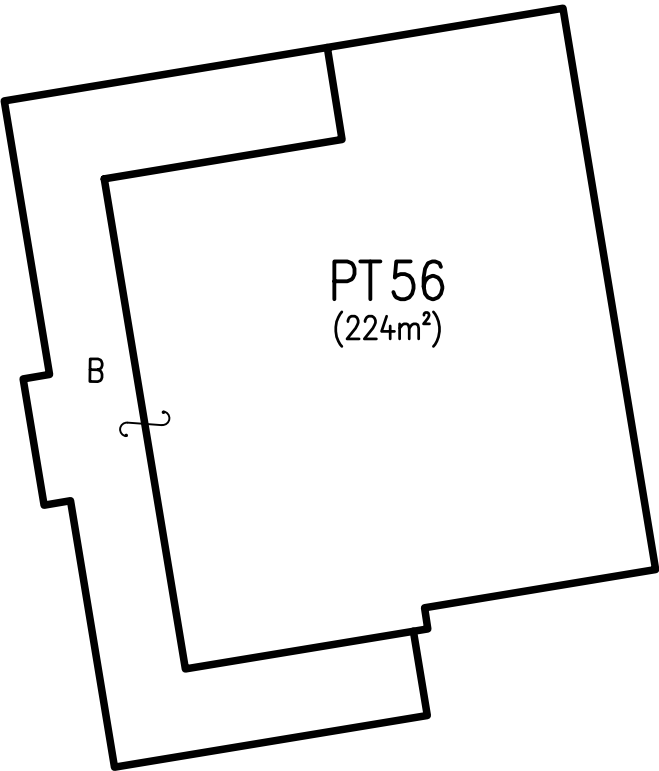
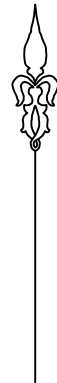
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AREAS ARE SUBJECT TO FINAL SURVEY

LEVEL 1 – HALL

LEVEL 2 – HALL



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B – BALCONY

Name: ADAM RICHARDSON Date: XX/XXX/XX Reference: 170224 DSP	PLAN OF SUBDIVISION OF 1–21 DILLWYNNIA GROVE	LGA: SUTHERLAND SHIRE Locality: HEATHCOTE Reduction Ratio: 1:200 Lengths are in metres.	REGISTERED CONTRACT PLAN Plan compiled from architectural CAD data. Plan is subject to final survey after completion of construction.	DRAFT PRINTED 23 NOV 2020 ISSUE 10
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